
# **ABBREVIATIONS**

**FLOOR** ABOVE FINISHED FLOOR REV REVISION ACC ACST FLOOR DRAIN RIGHT HAND ACCESS/ACCESSIBLE FCO FLOOR CLEANOUT ROW RIGHT OF WAY ACOUSTICAL ACT FTG FOOTING ROOF DRAIN ACOUSTICAL CEILING TILE FOUNDATION FDTN RFG ROOFING ADJUSTABLE FUR FURRING ROOM ACCESS LADDER FRAME ROUGH OPENING FR ALTERNATE GAUGE RUBBER BASE ALUM ALUMINUM GALVANIZED SECT GALV SECTION ANOD ANODIZED GEN CONTRACTOR SCHED SCHEDULE APPROX **APPROXIMATE** GLASS SHEET SHT ARCHITECT(URAL) GRADE SHT GL SHEET GLASS A.D. AREA DRAIN GYP GYPSUM **AUTO** SHWR SHOWER AUTOMATIC GYPSUM BOARD SIM B.E.J. GYP BD SIMILAR BRICK EXPANSION JOINT HDBD HARDBOARD SOLID SURFACE BSMT BASEMENT HDWR HARDWARE SST STAINLESS STEEL BRG **BEARING** HDR HEADER SPKR BRG P SPEAKER BEARING PLATE HEATING/VENT/AC HVAC SPEC **SPECIFICATION** BENCH MARK HEIGHT SQUARE BOARD HOSE BIB STD STANDARD BOC BOTTOM OR CURB HORIZ HORIZONTAL STEEL BUILDING B.U.R HOLLOW CORE STORM DRAIN BUILT UP ROOF HOLLOW METAL STOR STORAGE CAB CABINET CPT STRUCT STRUCTURE INCL INCLUDE(D) CARPET CPB INSIDE DIAMETER SUSP SUSPENDED CARPET BASE INT CSMT SYM SYMMETRICAL CASEMENT INTERIOR CTR INV INVERT SYNTH SYNTHETIC CENTERLINE CLG INSUL SOUND TRANSMISSION CLASS INSULATION STC CEILING CLG HT JOINT TEL TELEPHONE CEILING HEIGHT JOIST TELEVISION СТ CERAMIC TILE CWT J-B0X JUNCTION BOX **TEMP** TEMPERATURE CERAMIC WALL TILE CLO KITCHEN TMPD TEMPERED CLOSET KICKPLATE TENANT FURNISH CONT INSTALL COL TFCI COLUMN CONC LAMINATE TFTI TENANT FURNISH TENANT INSTALL CONCRETE LAVATORY THICK THK CONCRETE MASONRY UNIT LAV CONT LAG BOLT **THRES** THRESHOLD CONTINUOS LEFT HAND CORR CORRIDOR TYPICAL CFCI TOL TOLERANCE CONTRACTOR FURN/INSTALL LT LIGHT WEIGHT TONGUE & GROOVE CONTROL JOINT LOUVER TOS TOP OF SLAB CU FT LVR CUBIC FOOT MANHOLE TOST TOP OF STEEL CUBIC YARD MANUFACTURER TOW TOP OF WALL DTL DETAIL MASONRY OPENING DIAMETER МО TOC TOP OF CURB DIM MATL DIMENSION UNFIN UNFINISHED MAXIMUM DISP MAXDISPENSER UNLESS NOTED OTHERWISE UNO MECHANICAL DBL **MECH** DOUBLE VJ VEE JOINT MEMBRANE DOUBLE HUNG MEMB VAR VARNISH METER DOWN VNR VENEER MILLIMETER DOWN SPOUT MM VER VERIFY MINIMUM DWG DRAWING **VEST** VESTIBULE DRINKING FOUNTAIN MTLVERT VERTICAL MANUFACTURER **MFTR** EACH VCT VINYL COMPOSITION TILE MIRROR EDF ELEC DRINK COOLER MIR VWC VINYL WALL COVERING **MISCELLANEOUS** EWC MISC ELEC WATER COOLER VINYL FLOORING MOUNTED ELEC ELECTRIC VINYL BASE MOD MODULAR EPB ELEC PANELBOARD WSCT WAINSCOT MOVEABLE MOV **EMER EMERGENCY** WALL TILE MULLION MULL ELEVATION WATER CLOSET NATURAL NAT ELEV **ELEVATOR** WWF WELDED WIRE FABRIC NOISE REDUCTION NR **ENCL** ENCLOSURE WDW WINDOW NOMINAL NOM EQUAL WITHOUT W/O NOT IN CONTRACT NIC EQUIP EQUIPMENT WATER HEATER PLATE ESCAL ESCALATOR WIRED GLASS WGL PREFINISHED PREF **EXIST EXISTING** WITH PROPERTY LINE **EXPANSION JOINT** WOOD QUARRY TILE EXP **EXPOSED** WOOD BASE RADIUS EXT **EXTERIOR** REFERENCE FACE OF CONCRETE WORK POINT WPT REFRIGERATOR FACE OF FINISH REINFORCED REINF FOS FACE OF STUD REQUIRED REQD FINISHED FLOOR FACE OF BRICK FIRE EXTINGUISHER FIRE EXITING. CAB FIRE HOSE STATION **FLEXIBLE** 

# SYMBOLS LEGEND

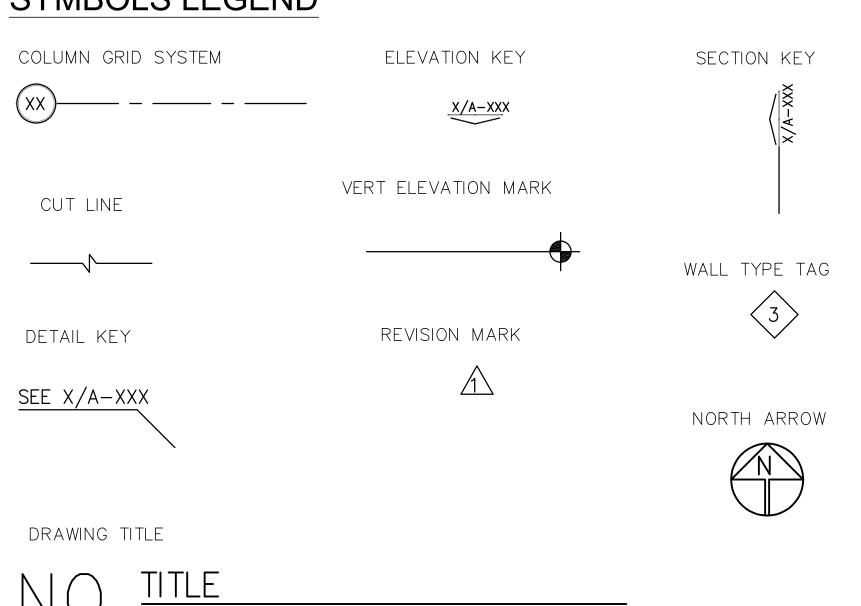

## PROJECT INFORMATION

## CODE INFORMATION

BUILDING 2021 INTERNATIONAL BUILDING CODE MECHANICAL 2021 INTERNATIONAL MECHANICAL CODE PLUMBING 2021 INTERNATIONAL PLUMBING CODE ELECTRICAL 2020 NATIONAL ELECTRICAL CODE 2021 INTERNATIONAL GAS CODE GAS ENERGY 2021 INTERNATIONAL ENERGY CONSERVATION CODE


2013 ANSI A117.1


ACCESSIBILITY

LIFE SAFETY 2021 INTERNATIONAL FIRE CODE

## PROJECT DESCRIPTION

THE PROJECT CONSISTS OF THE DEMOLITION OF APPROXIMATELY 59.565 SF OF EXISTING AIRPORT BUILDINGS WITHIN AN ACTIVE AIRPORT FACILITY. PARTIAL DEMOLITION OF EXISTING AIRFIELD PAVEMENT WILL BE REQUIRED WITH UTILITY REMOVAL. THE EXISTING BUILDING STRUCTURE IS CAST-IN-PLACE CONCRETE WITH NON-LOADBEARING MASONRY, METAL STUD AND GYPSUM BOARD INTERIOR AND EXTERIOR WALLS ON 1 SUBGRADE LEVEL AND 2 ABOVE GRADE LEVELS. PARTIAL SUBGRADE PUT-BACK WILL BE REQUIRED AFTER BUILDING DEMOLITION AND NEW CONSTRUCTION TO ENCLOSE THE PARTIALLY DEMOLISHED ENDS OF THE EXISTING BUILDING TO REMAIN.

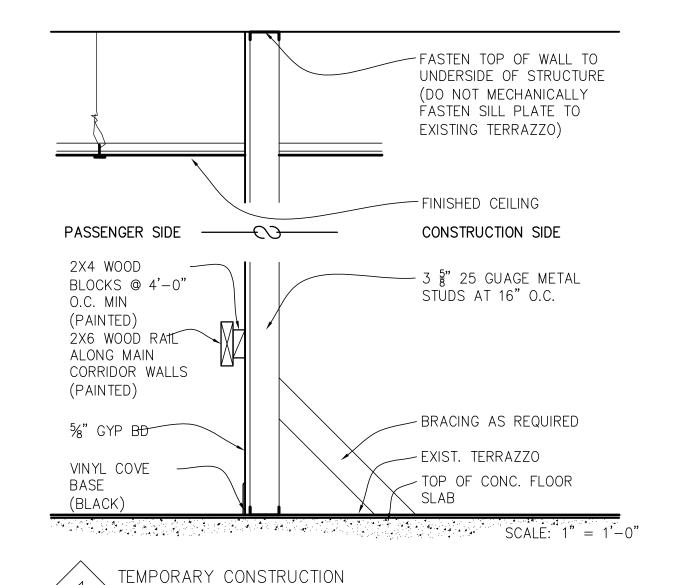

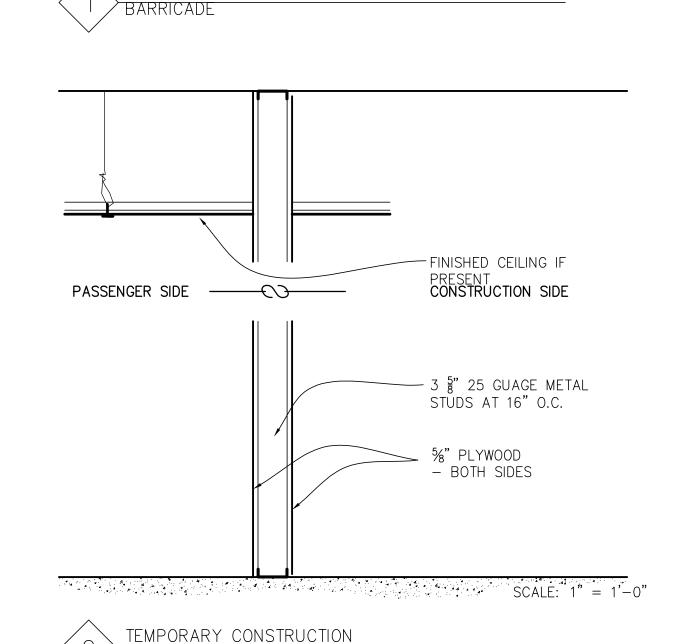

REFERENCES LOCARTIO

IN EXISTING AIRPORT

DRAWINGS

BARRICADE

- SHEET NUMBER - DISCIPLINE - CONCOURSE DESIGNATION - DRAWING NUMBER X X\_X-XXX SHEET TITLE

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# **ISSUED FOR** BID/CONSTRUCTION

1 ADDENDUM #3

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equate control of the materials issued and prod

ARCHITECT

DESCRIPTION DATE

**REVISIONS** 

PROJECT:

TERMINAL APRON RECONSTRUCTION **CONCOURSE C-SOUTH DEMO** 

SHEET TITLE:

XXXXX

PROJECT INFO./ **DRAWING INDEX** 

13-1368-02 DWG. FILE NAME 13030\_A\_DT-000

05/31/22 A\_DT-000 NTS FACILITY NO 2 OF 56

## general notes

- 1. CONTRACT DOCUMENTS INCLUDE ALL DRAWINGS AND THE PROJECT MANUAL
- 2. CONTRACTOR SHALL VISIT SITE AND FAMILIARIZE HIMSELF WITH EXISTING CONDITIONS PRIOR TO BID AND CONSTRUCTION.
- 3. CONTRACTOR TO SUBMIT SITE ACCESS, MOBILIZATION, AND CONSTRUCTION UTILIZATION PLAN TO OWNER FOR APPROVAL PRIOR TO BEGINNING WORK.
- 4. CONTRACTOR RESPONSIBLE FOR OBTAINING ALL PERMITS.
- 5. CONTRACTOR TO COORDINATE WITH WORK OF SEPARATE CONTRACTORS, WORKING DIRECTLY FOR THE OWNER (IF ANY).
- 6. THIS DOCUMENT IS PROVIDED FOR BASIC CONSTRUCTION PURPOSES ONLY. THE ARCHITECT DOES NOT WARRANT ANY MATERIAL EQUIPMENT, HARDWARE, ETC. WHETHER IMPLIED OR EXPLICITLY CALLED OUT ON DRAWINGS.
- 7. ALL GENERAL NOTES APPLY TO THE SCOPE OF THIS TOTAL PROJECT, REGARDLESS OF WHETHER OR NOT THEY ARE KEYED ON EVERY SHEET TO A SPECIFIC DETAIL.
- 8. THE GENERAL CONTRACTOR SHALL ENSURE THAT ALL CONSTRUCTION MEETS OR EXCEEDS APPLICABLE CODES AND STANDARD PRACTICES, INCLUDING ALL FEDERAL, STATE AND LOCAL BUILDING AND HANDICAP REQUIREMENTS AND REGULATIONS. THE CONTRACTOR SHALL BE RESPONSIBLE FOR ANY VIOLATION OF THE SAME AND SHALL MAKE ALL WORK ACCEPTABLE TO THE PUBLIC DEPARTMENT INVOLVED WITHOUT EXTRA
- 9. ALL PERMITS (OCCUPANCY, ELECTRICAL, PLUMBING AND ALL OTHERS) REQUIRED BY STATE AND LOCAL CODES, EXCEPT THOSE ACQUIRED BY SUBCONTRACTORS, ARE TO BE SECURED BY THE GENERAL CONTRACTOR WITH COPIES TO BUILDING OWNER WITHOUT EXTRA CHARGE. ALL PERMITS ACQUIRED BY SUBCONTRACTORS SHALL BE SUBMITTED TO THE GENERAL CONTRACTOR FOR RECORD.
- 10. ALL EXTERIOR EXPOSED WORK SHALL BE INSTALLED IN SUCH MANNER AS TO ASSURE WEATHER TIGHT CONDITION. CONTRACTOR SHALL PROVIDE ALL CAULKING AND WEATHER BARRIER MATERIALS REQUIRED FOR WEATHER TIGHT CONDITIONS DURING ALL CONSTRUCTION TIMES.
- 11. EACH TRADE SHALL VERIFY ALL REQUIREMENTS PERTAINING TO WORK PERFORMED IN THE PROJECT AND ANY REQUIRED PERMITS. ALL SUBCONTRACTORS SHALL DIRECT QUESTIONS, CHANGES OR REQUESTS THROUGH THE GENERAL CONTRACTOR. THE GENERAL CONTRACTOR SHALL SUBMIT ALL REQUESTS, CHANGES OR QUESTIONS TO THE OWNER IN WRITING.
- 12. FOR ANY ARCHITECTURAL WORK THAT IS INDICATED GRAPHICALLY AND NOT NOTED, THE WORK WILL BE EXPECTED TO BE PERFORMED AT NO ADDITIONAL CHARGE.
- 13. IF UNANTICIPATED MECHANICAL, PLUMBING, ELECTRICAL, STRUCTURAL ELEMENTS, OR ANY OTHER CONDITIONS ARE ENCOUNTERED WHICH MIGHT CONFLICT WITH THE INTENDED FUNCTION OR DESIGN OF THE NEW CONSTRUCTION, CONTACT THE ARCHITECT IMMEDIATELY FOR CLARIFICATION. NOTE: IT IS THE RESPONSIBILITY OF THE GENERAL CONTRACTOR TO ENSURE THAT ALL TRADES COORDINATE WITH ONE ANOTHER TO IDENTIFY POTENTIAL CONFLICTS BEFORE THE FIRST TRADE BEGINS WORK.
- 14. REVIEW ALL EXIT SIGNS, EMERGENCY EXITS AND FIRE EXTINGUISHER LOCATIONS WITH LOCAL CODE OFFICIALS PRIOR TO CONSTRUCTION TO VERIFY LIFE SAFETY AND FIRE DEPARTMENT ACCESS AT ALL TIMES DURING CONSTRUCTION. COORDINATE ANY VARIATIONS FROM CONSTRUCTION DOCUMENTS WITH ARCHITECT. EMERGENCY EXITS SHALL BE PROVIDED DURING BUILDING DEMOLITION AT ALL TIMES. IN CASE OF ANY EMERGENCY EVACUATIONS, THE EMERGENCY EXIT WILL SERVE AS A LIFELINE FOR TRANSPORTATION OF INJURED WORKERS.
- 15. THE CONTRACTOR SHALL PROMPTLY REMEDY ANY DAMAGE AND/OR LOSS TO PROPERTY (ALL MATERIALS AND EQUIPMENT INCORPORATED IN THE WORK DESCRIBED HEREIN) CAUSED IN WHOLE OR IN PART BY THE CONTRACTOR, A SUBCONTRACTOR OR ANYONE DIRECTLY OR INDIRECTLY EMPLOYED BY THE CONTRACTOR.
- 16. THE CIVIL, STRUCTURAL, MECHANICAL, PLUMBING, AND ELECTRICAL DRAWINGS ARE SUPPLEMENTARY TO THE ARCHITECTURAL DRAWINGS. SHOULD THERE BE A DISCREPANCY BETWEEN THE ARCHITECTURAL DRAWINGS AND THE ENGINEERING DRAWINGS, SUCH DISCREPANCY IS TO BE BROUGHT TO THE ATTENTION OF THE ARCHITECT PRIOR TO INSTALLATION OF SAID WORK. ANY WORK INSTALLED IN CONFLICT WITH ARCHITECTURAL DRAWINGS SHALL BE CORRECTED BY THE CONTRACTOR AT HIS OWN EXPENSE, AND AT NO EXPENSE TO THE OWNER OR THE ARCHITECT.
- 17. DO NOT SCALE DRAWINGS. ALL DIMENSIONS SHALL BE VERIFIED IN FIELD.
- 18. THE CONTRACTOR IS RESPONSIBLE FOR ANY DEMO'D OR REMOVED CONSTRUCTION MATERIAL RELOCATION AS DIRECTED BY THE OWNER. ANY DEMO'D OR REMOVED CONSTRUCTION MATERIAL, BUILDING COMPONENTS, FURNITURE, ETC. NOT PREVIOUSLY REMOVED FROM PROJECT LIMITS PRIOR TO CONSTRUCTION, INDICATED IN THE CONTRACT DOCUMENTS OR MARKED BY THE OWNER PRIOR TO CONSTRUCTION BECOMES THE PROPERTY OF THE CONTRACTOR. AT THAT POINT THE CONTRACTOR IS RESPONSIBLE FOR REMOVING SAID MATERIAL AWAY FROM THE PROJECT SITE.
- 19. COMPLY WITH ALL CITY OF MEMPHIS, SHELBY COUNTY, STATE OF TENNESSEE AND MSCAA REQUIREMENTS FOR WEIGHT LIMITS FOR ALL OPERATIONS ON SURROUNDING PUBLIC STREETS AND MSCAA MAINTAINED STREETS. ANY EXISTING AND/OR NEWLY CONSTRUCTED STREETS OR ROADS DAMAGED BY HAULING OPERATIONS SHALL BE REPAIRED AT NO EXPENSE TO THE OWNER. ALL PROJECT RELATED HAULING AT THE SITE SHALL BE APPROVED BY THE OWNER, ARCHITECT AND/OR ENGINEER.
- 20. AIRPORT OPERATIONS WILL HAVE PRIORITY AT ALL TIMES OVER VEHICLES, EQUIPMENT, AND PERSONNEL. THE CONTRACTOR SHALL EMPLOY STRICT MEASURES TO PREVENT ANY CONFLICT BETWEEN CONSTRUCTION FORCES AND AIRCRAFT OPERATIONS.
- 21. ALL EQUIPMENT SUCH AS CRANES, DRILL RIGS AND ANY OTHER CONSTRUCTION EQUIPMENT WITH A VERTICAL COMPONENT ARE SUBJECT TO HEIGHT RESTRICTIONS AS GOVERNED BY THE F.A.R. PART 77 SURFACES PROTECTING NAVIGABLE AIRSPACE.
- 22. PERFORM CONSTRUCTION OPERATIONS AS NECESSARY TO MINIMIZE ATTRACTION TO BIRDS CAUSED BY PONDING WATER, TRASH AND OTHER CONSTRUCTION FEATURES. PROTECT ANY PORTION OF BUILDING TO REMAIN FROM WEATHER DAMAGE OR WATER INFILTRATION AS A RESULT FROM ANY DEMO OPERATIONS.
- 23. THE CONTRACTOR SHALL TAKE ALL NECESSARY PRECAUTIONS TO MINIMIZE BLOWING DUST AND/OR DEBRIS. THE OWNER WILL SHUT DOWN CONSTRUCTION OPERATIONS WHEN BLOWING MATERIAL BECOMES HAZARDOUS TO AIRFIELD OPERATIONS. SUCH A SHUTDOWN SHALL NOT BE THE BASIS OF CLAIMS FOR ADDITIONAL COSTS OR CONTRACT
- 24. PROTECT PAVEMENTS AND UNDERGROUND UTILITIES FROM DAMAGE CAUSED BY CONSTRUCTION EQUIPMENT. ANY DAMAGE TO PAVEMENTS OR FACILITIES CAUSED BY THE CONTRACTOR'S EQUIPMENT SHALL BE REPAIRED OR REPLACED IN KIND BY THE CONTRACTOR AT NO ADDITIONAL CONTRACT COST.
- 25. ANY AIRPORT AREA OR FEATURE THAT IS DISTURBED OUTSIDE THE LIMITS OF CONSTRUCTION DURING THE LIFE OF THIS PROJECT SHALL BE REPAIRED OR REPLACED IN KIND BY THE CONTRACTOR AT NO ADDITIONAL CONTRACT COST.
- 26. THE CONTRACTOR SHALL BE RESPONSIBLE FOR THE ACQUISITION OF AND THE COST OF WATER AS REQUIRED FOR DUST CONTROL, DEMOLITION, EARTHWORK, BASE CONSTRUCTION AND ALL OTHER CONSTRUCTION OPERATIONS. ALL COSTS OF SAID WATER ACQUISITION INCLUDING PERMITS, MONTHLY BILLING, TEMPORARY PIPING, CONNECTIONS, HYDRANTS, METERS AND DEMOLITION WILL BE CONSIDERED SUBSIDIARY AND WILL NOT BE MEASURED AND PAID FOR SEPARATELY. THE OWNER, ARCHITECT AND/OR ENGINEER SHALL APPROVE ALL UTILITY AGREEMENTS AND ARRANGEMENTS.


- 27. ALL EARTH, ASPHALT, CONCRETE, CEMENT, TRASH AND OTHER DEBRIS RESULTING FROM CONSTRUCTION OPERATIONS SHALL BE REMOVED CONTINUOUSLY FROM ROADWAYS, STREETS AND PARKING LOTS OPEN TO TRAFFIC DURING CONSTRUCTION. ALL COSTS ASSOCIATED WITH SAID CLEANING TO BE INCLUDED IN THE COSTS OF OTHER ITEMS AND WILL NOT BE PAID FOR SEPARATELY.
- 28. ANY MARKED AND/OR LOCATED UTILITIES OR UNDERGROUND FEATURES DAMAGED BY CONSTRUCTION OPERATIONS SHALL BE REPAIRED OR REPLACED IN KIND AT NO ADDITIONAL CONTRACT COST IF THE UTILITY OR FEATURE IS TO REMAIN OPERATIONAL

## COORDINATION

- 1. THE GENERAL CONTRACTOR IS RESPONSIBLE FOR BECOMING FAMILIAR WITH THE REQUIREMENTS OF ALL CONSTRUCTION DOCUMENTS WHICH INCLUDES DRAWINGS. SPECIFICATIONS, SOIL, AND ENVIRONMENTAL REPORTS, THE CONTRACT FOR CONSTRUCTION, GENERAL CONDITIONS OF THE CONTRACT AND ALL ADDENDA.
- 2. LETTER PREFIXES FOR EACH DRAWING SHEET INDICATING THE ENGINEERING DISCIPLINE & BUILDING TYPE ARE FOR CONVENIENCE ONLY. INFORMATION AFFECTING THE SCOPE OF WORK FOR ALL TRADES WILL BE FOUND THROUGHOUT ALL DOCUMENTS AND IS NOT LIMITED TO ONLY THOSE DOCUMENTS WITH THE APPROPRIATE LETTER PREFIX.
- 3. THE CONTRACTOR SHALL CONSULT AND COORDINATE WITH THE OWNER REGARDING LIMITATIONS FOR SITE ACCESS, MOBILIZATION, CONSTRUCTION WORK HOURS, AND WORK BEING DONE BY THE OWNER OR SEPARATE OWNER CONTRACTOR.
- 4. THE CONTRACTOR SHALL CONSULT AND COORDINATE WITH THE OWNER FOR ITEMS PURCHASED DIRECTLY BY THE OWNER BUT INSTALLED BY THE CONTRACTOR.
- 5. THE ARCHITECT/ENGINEER IS THE SOLE INTERPRETER OF THE CONTRACT DOCUMENTS INCLUDING ANY APPARENT CONFLICTS OR OMISSIONS. THE CONTRACTOR SHALL REPORT ANY CONFLICTS, ETC. TO THE ARCHITECT/ENGINEER PRIOR TO BID AND CONSTRUCTION, OTHERWISE IT SHALL BE ASSUMED HE UNDERSTANDS FULLY THE REQUIREMENTS OF THE CONTRACT DOCUMENTS.
- 6. SEE SPECIFICATIONS AND DRAWINGS FOR ADDITIONAL COORDINATION REQUIREMENTS.
- 7. ON ELEMENTS LABELED N.I.C. (NOT IN CONTRACT), G.C. TO COORDINATE / ACCOMMODATE FUTURE LOCATIONS WHEN CONSTRUCTING WALLS, FLOORS, CEILINGS, SIDEWALKS, ETC. WHICH WILL PREVENT THESE FUTURE ELEMENTS FROM BEING ACCESSIBLE.

### DEMOLITION NOTES

- 1. EXISTING CONDITIONS SHOWN ARE FROM AVAILABLE RECORD DRAWINGS AND SHOWN FOR REFERENCE ONLY. VERIFY ACTUAL EXISTING CONDITIONS ON SITE PRIOR TO SUBMITTING BID AND BEGINNING WORK. ALL DEMOLITION, ALTERATION, EXTENSION, RELOCATION, REHABILITATION AND NEW CONSTRUCTION SHALL BE INCLUDED IN CONTRACT.
- 2. NOTIFY THE CONSTRUCTION MANAGER IMMEDIATELY WHERE EXISTING EQUIPMENT OR UTILITIES ARE ENCOUNTERED WHICH MUST BE RELOCATED DUE TO THE NEW CONSTRUCTION OR NOT INDICATED ON THE "AS BUILT" OR WAS BURIED OR EMBEDDED IN EXISTING STRUCTURE.
- 3. PROTECT ALL WALLS, TRIM, FLOORS, EQUIPMENT AND MATERIALS WHEN WORKING ON FINISHED SURFACES TO REMAIN. LIMIT DAMAGE TO THE SMALLER AREA IF POSSIBLE AND RESTORE TO THE ORIGINAL CONDITION ALL SURFACES WHICH ARE DAMAGED DUE TO THE INSTALLATION OF THIS WORK.
- 4. EQUIPMENT, MATERIALS AND SUPPLIES TEMPORARILY REMOVED FOR PROTECTION SHALL BE REPLACED IN ORIGINAL LOCATIONS OR AS SPECIFIED ON DRAWINGS. REPLACE MATERIALS DAMAGED WITH NEW MATERIALS OF LIKE KIND AND QUALITY. AFTER CONCLUSION OF DEMOLITION AND NEW CONSTRUCTION, CONTRACTOR TO CLEAN AND MAKE ALL EXISTING FINISH MATERIALS BOTH INTERIOR AND EXTERIOR LIKE NEW.
- 5. PROVIDE TEMPORARY SUPPORT OR SHORING TO BUILDING STRUCTURE AND COMPONENTS BEING DEMOLISHED AS REQUIRED INCLUDING BUT NOT LIMITED TO: WHEN THE WHOLE OR ANY PART OF THE STRUCTURE IS SUBJECTED TO EXCESS LOADING DERIVED FROM THE DEMOLITION ACTIVITIES, MOVEMENT OF POWERED MECHANICAL EQUIPMENT, OR DEBRIS ACCUMULATION; WHEN ANY PART OF THE STRUCTURE OR ANY ELEMENT BEING DEMOLISHED IS NOT SELF-SUPPORTING: OR WHEN THE TEMPORARY STABILITY OF THE STRUCTURE OR ITS ELEMENTS COULD BE IMPAIRED AS A RESULT OF THE DEMOLITION ACTIVITIES.
- 6. WHEN THE DEMOLITION ACTIVITIES ARE SHUT DOWN FOR A PROLONGED PERIOD OF TIME BEFORE ITS COMPLETION FOR ANY REASON, THE REMAINING STRUCTURE IF ANY, SHALL BE STABILIZED BY TEMPORARY SUPPORT AND/OR BRACING SYSTEMS.
- 7. PROTECT EXISTING BUILDING TO REMAIN AS REQUIRED TO PREVENT DAMAGE DURING DEMOLITION. STABILITY TREATMENT SHALL BE PROVIDED TO PROTECT BUILDING ELEMENTS THAT MAY BE AFFECTED BY THE DEMOLITION PROJECT. THE DESIGN OF THE BRACING OR PROTECTION SYSTEM SHALL BE BASED ON A STRUCTURAL ASSESSMENT AND ENGINEERED BY THE CONTRACTOR PENDING THE APPROVAL OF THE OWNER, ARCHITECT, AND/OR ENGINEER.
- 8. IF ANY UNSAFE CONDITIONS ARE PRESENT AS RECOGNIZED BY THE OWNER, ARCHITECT, ENGINEER, CONTRACTOR OR ANY OTHER AUTHORIZED PERSONELL, ALL DEMOLITION ACTIVITIES SHALL BE IMMEDIATELY HALTED UNTIL THE UNSAFE CONDITIONS ARE RECTIFIED. ALL UNSAFE CONDITIONS SHALL BE REPORTED TO THE MSCAA PROJECT MANAGER FOR FURTHER INSTRUCTIONS.
- 9. CONTRACTOR TO SUBMIT FOR APPROVAL A DEMOLITION PLAN REPORT INCLUDING BUT NOT LIMITED TO: DEMOLITION SEQUENCE, DEMOLITION METHODS, POWERED MECHANICAL DEMOLITION EQUIPMENT LIST, EXPECTED EXISTING BUILDING PROTECTION MEASURES, PROPOSED DUST-CONTROL MEASURES, PROPOSED NOISE-CONTROL MEASURES, CONTRACTOR'S WASTE MANAGEMENT AND RECYCLING PLAN, ETC. SEE DEMOLITION SPEC FOR MORE INFO. - SECTION P-150
- 40. TÊMPORARY EXCAVATION-SHORING SHALL BE BASED ON A-STRUCTURAL ASSESSMENT AND ENGINEERED BY THE CONTRACTOR PENDING THE APPROVAL OF THE OWNER, ARCHITECT, AND/OR ENGINEER. PARAMETERS AND LIMITS FOR TEMPORARY EXCAVATION SHORING ARE SET FORTH IN THE SPECIFICATIONS AND GEOTECHNICAL INVESTIGATION REPORT. CONTRACTOR TO LOCATE SHORING IN THE FIELD TO INCORPORATE AND ACCOUNT FOR NEARBY LOCATIONS OF BUILDING FOOTINGS, UTILITY 🖊 -whes possible cement treated base backfill against thing walls, etc.  $\sqrt{1}$

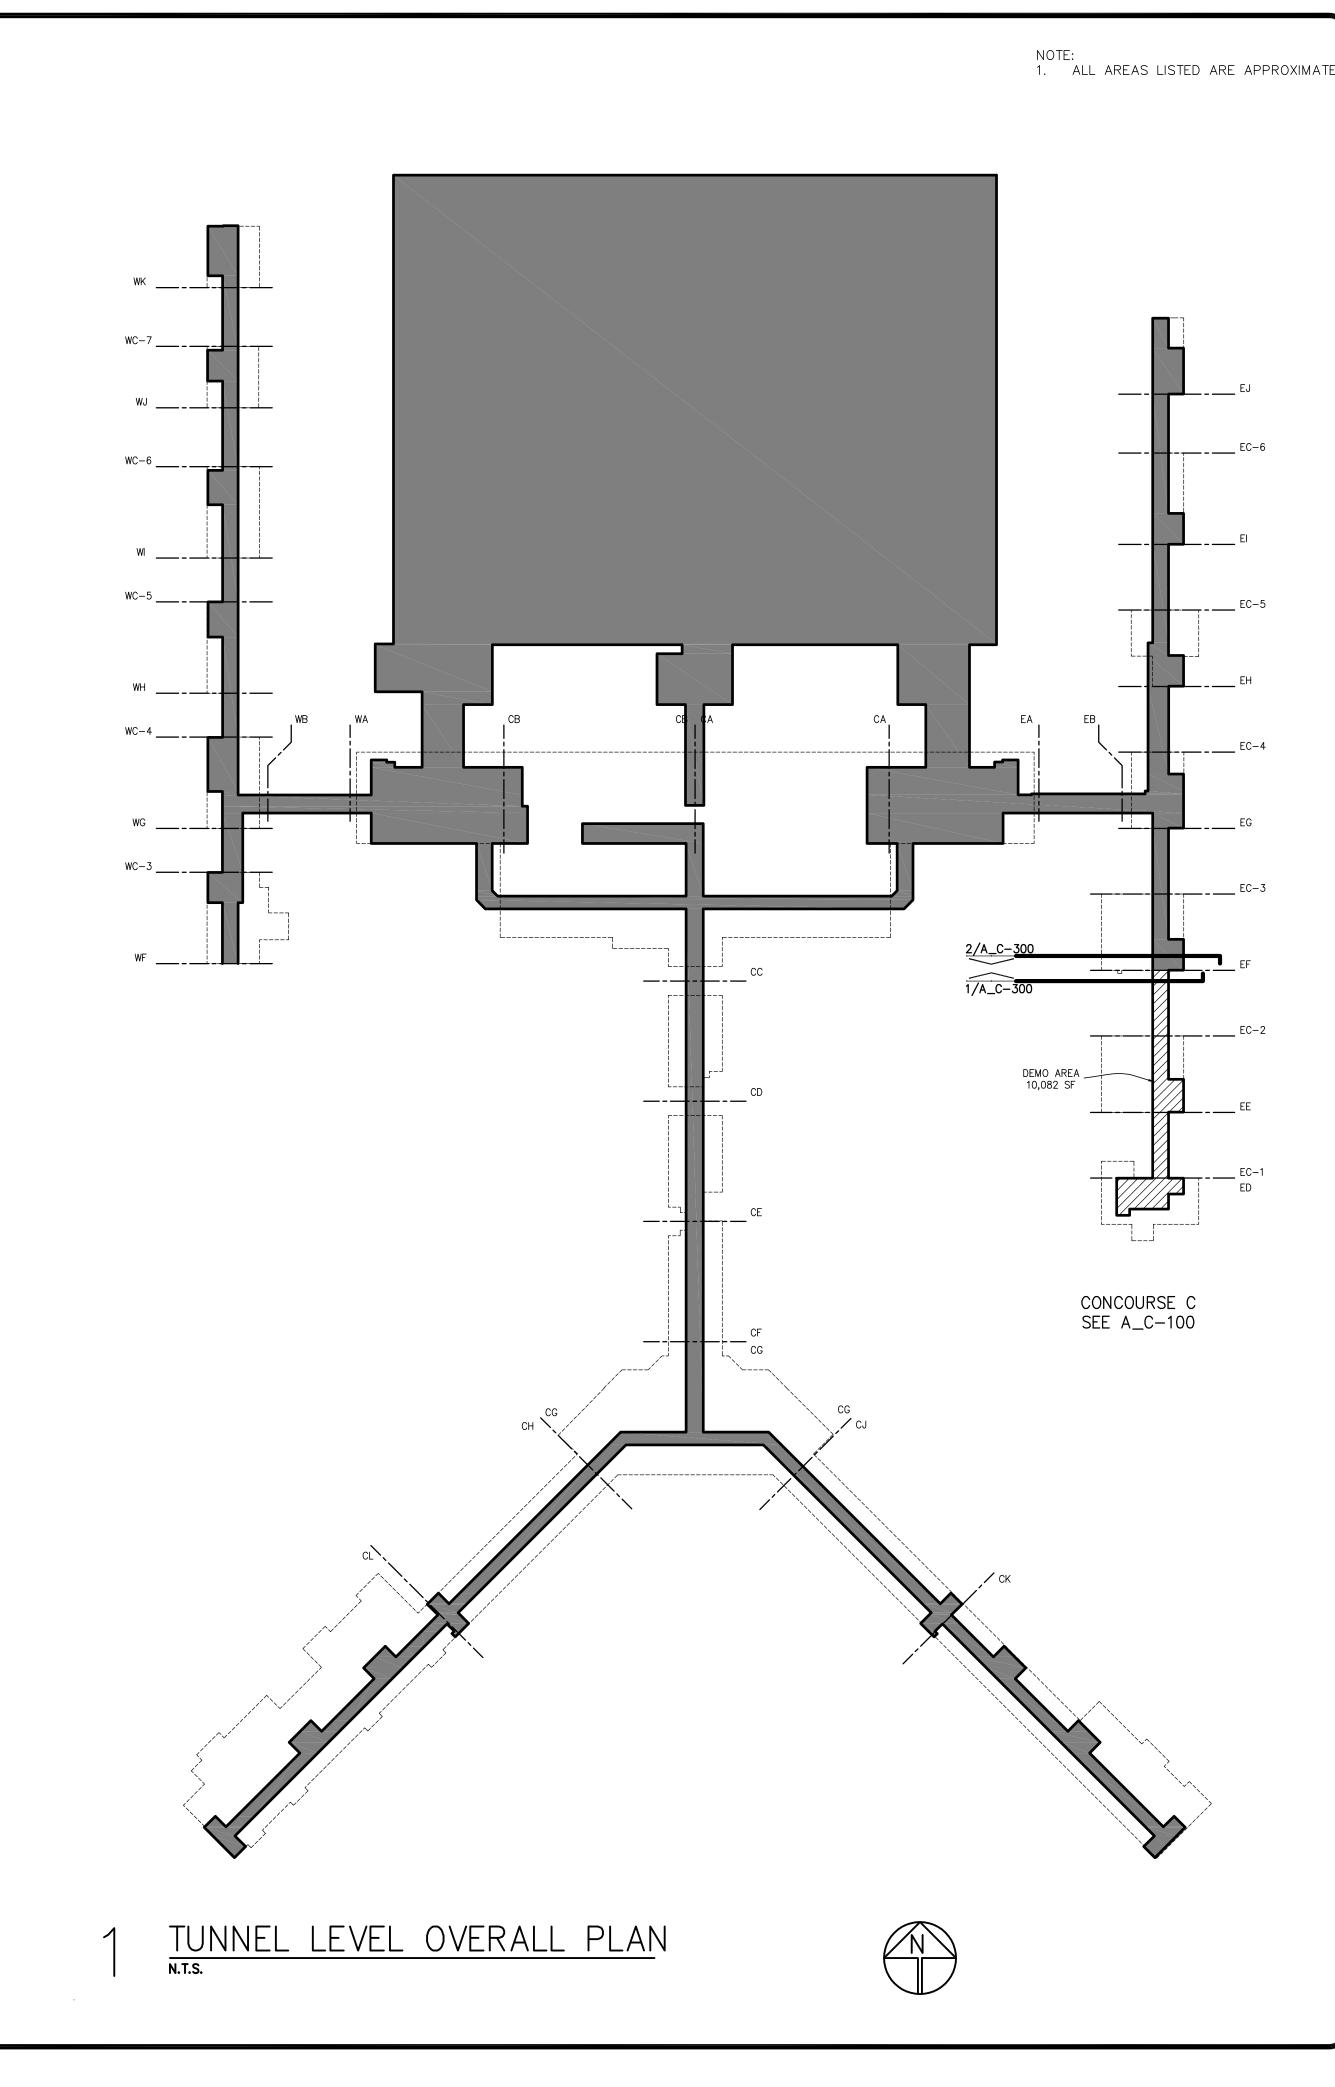


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**ISSUED FOR** BID/CONSTRUCTION

1	ADDENDUM #3	06.22.2
NO.	DESCRIPTION	DATE
	REVISIONS	
PRO	DJECT:	

TERMINAL APRON RECONSTRUCTION **CONCOURSE C-**SOUTH DEMO


SHEET TITLE:

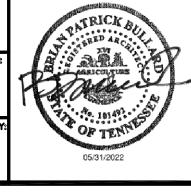XXXXX

**GENERAL NOTES/ KEY PLANS** 


MSCAA NO. 13-1368-02 DWG. FILE NAME 13030\_A\_DT-000 05/31/22

A\_DT-001 NTS HEET NO. 3 OF 56

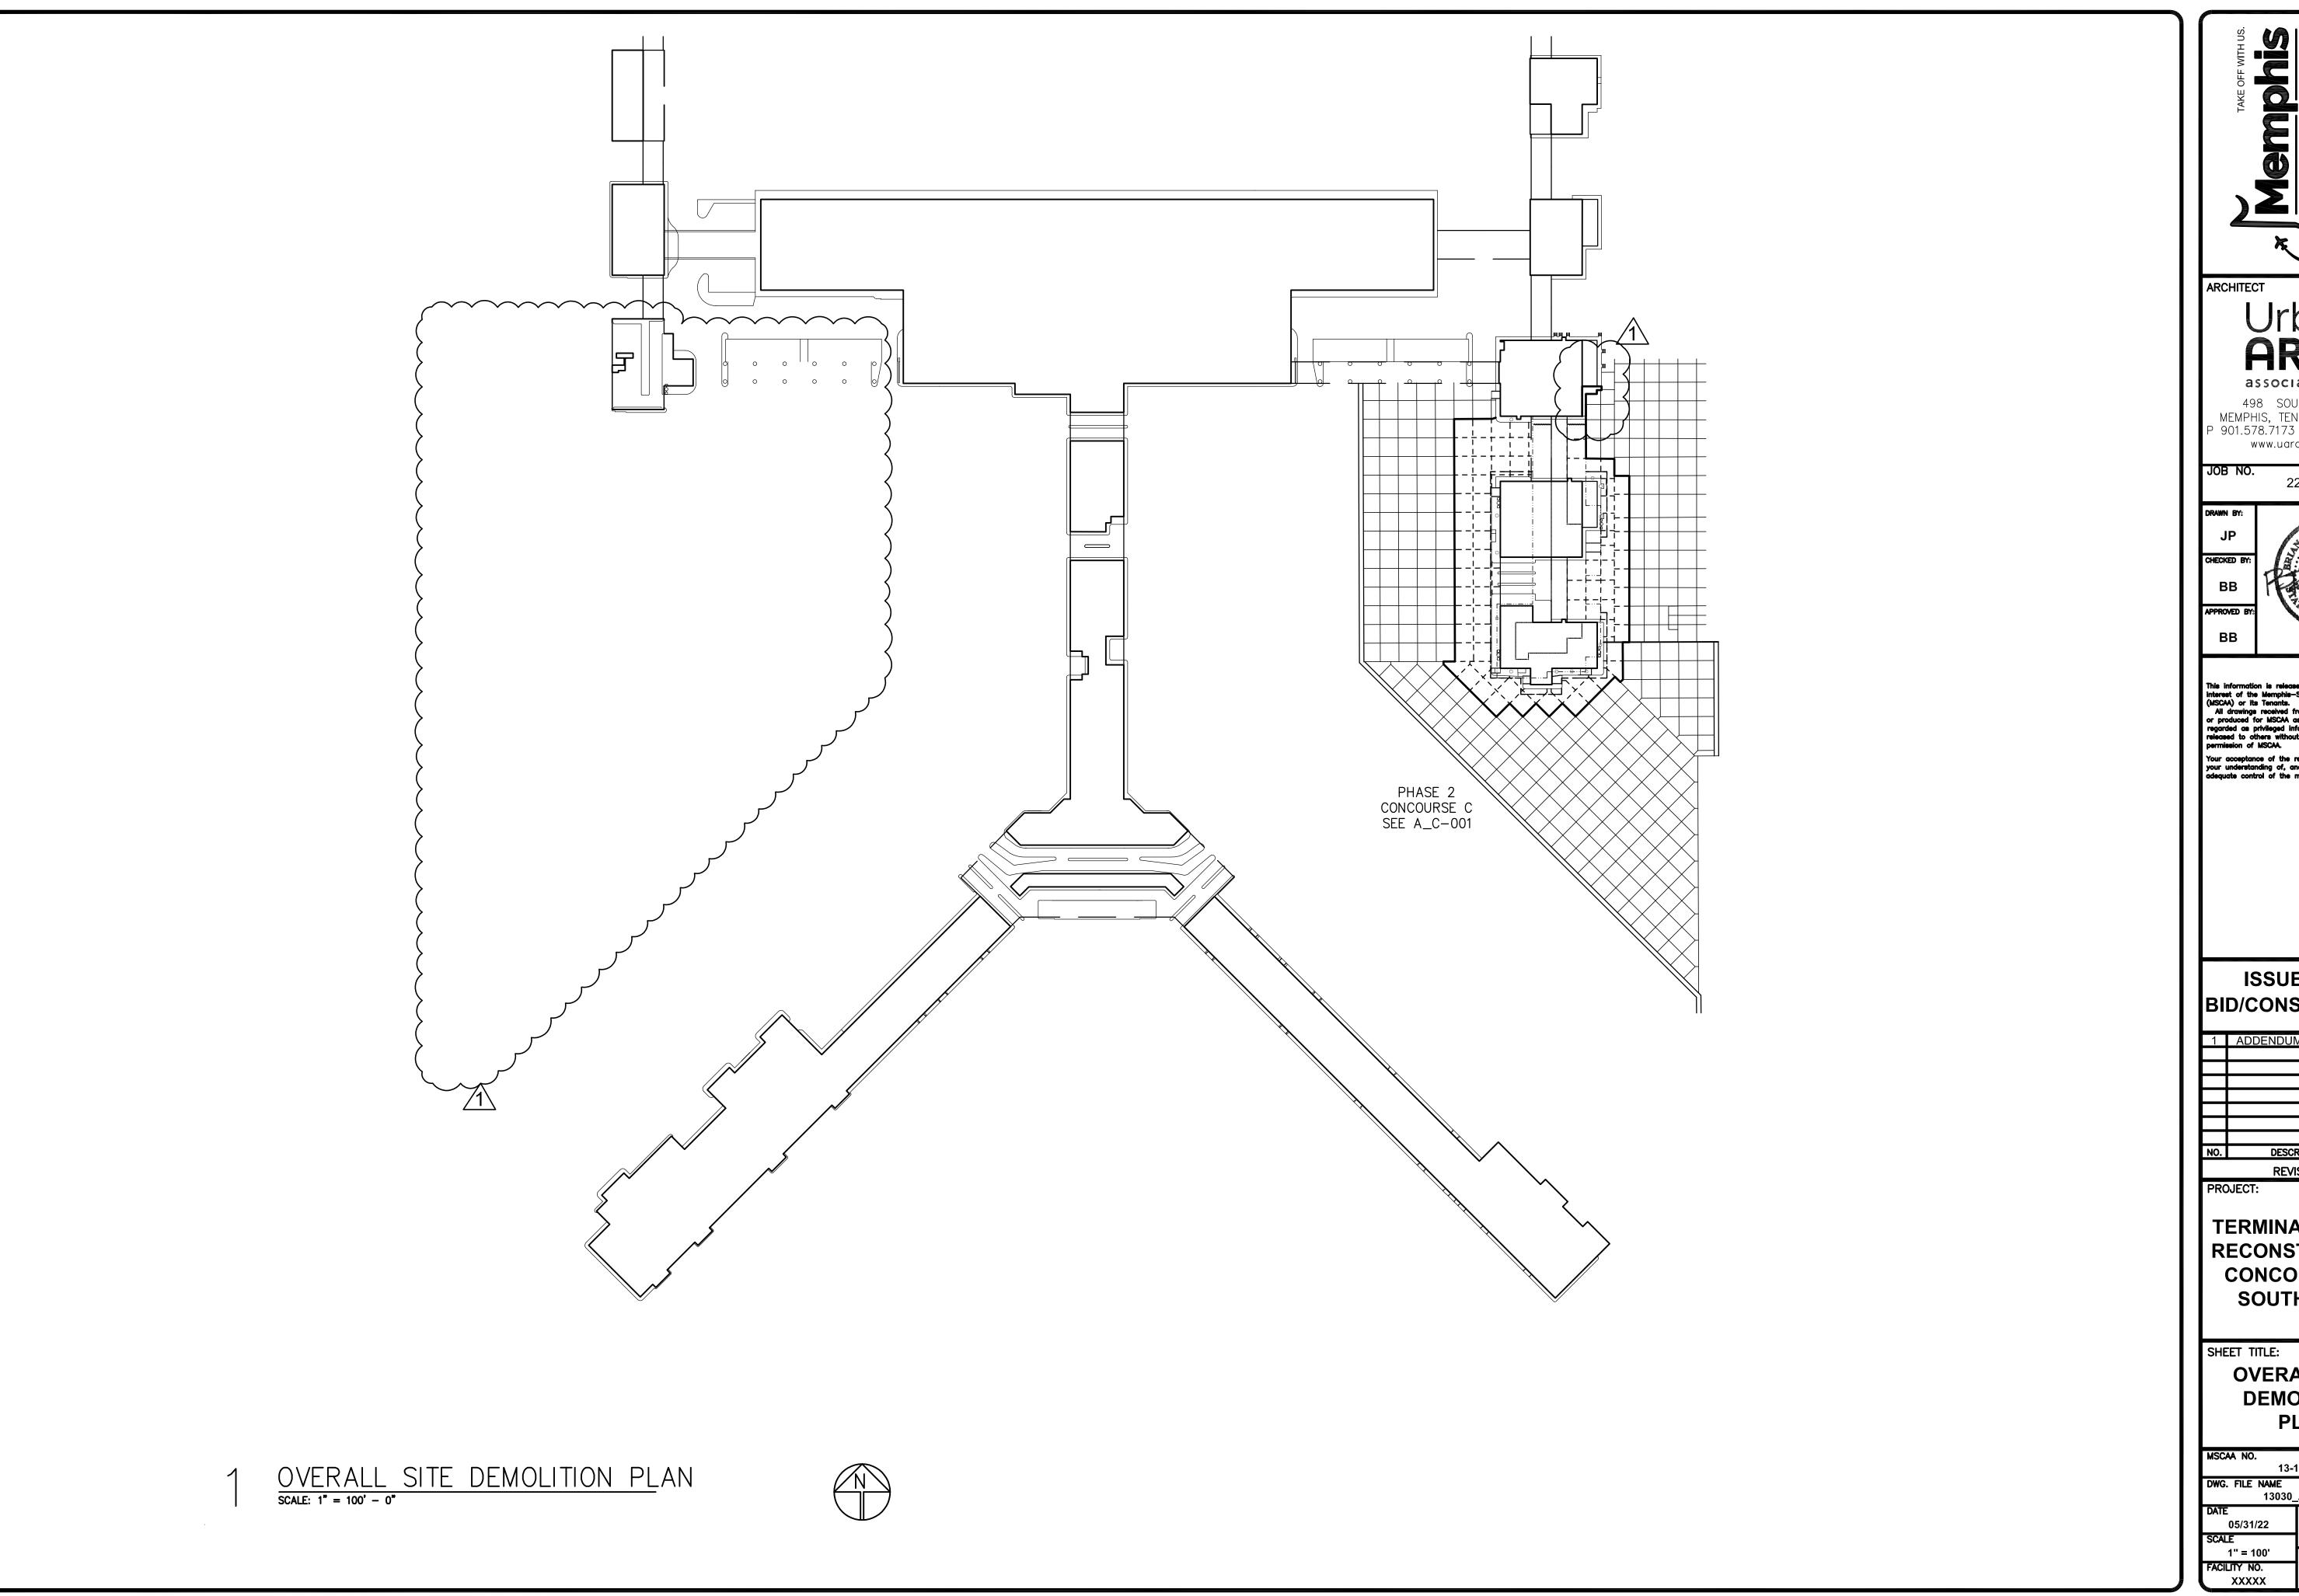

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	REVISIONS				
NO.	DESCRIPTION	DATE			
1	ADDENDUM #3	06.22.			


**TERMINAL APRON** RECONSTRUCTION **CONCOURSE C -**SOUTH DEMO

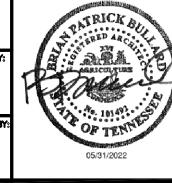**OVERALL SITE DEMOLITION PLAN** 

13-1368-02 DWG. FILE NAME 13030\_A\_DT-003

A\_DT-003

5 OF 56

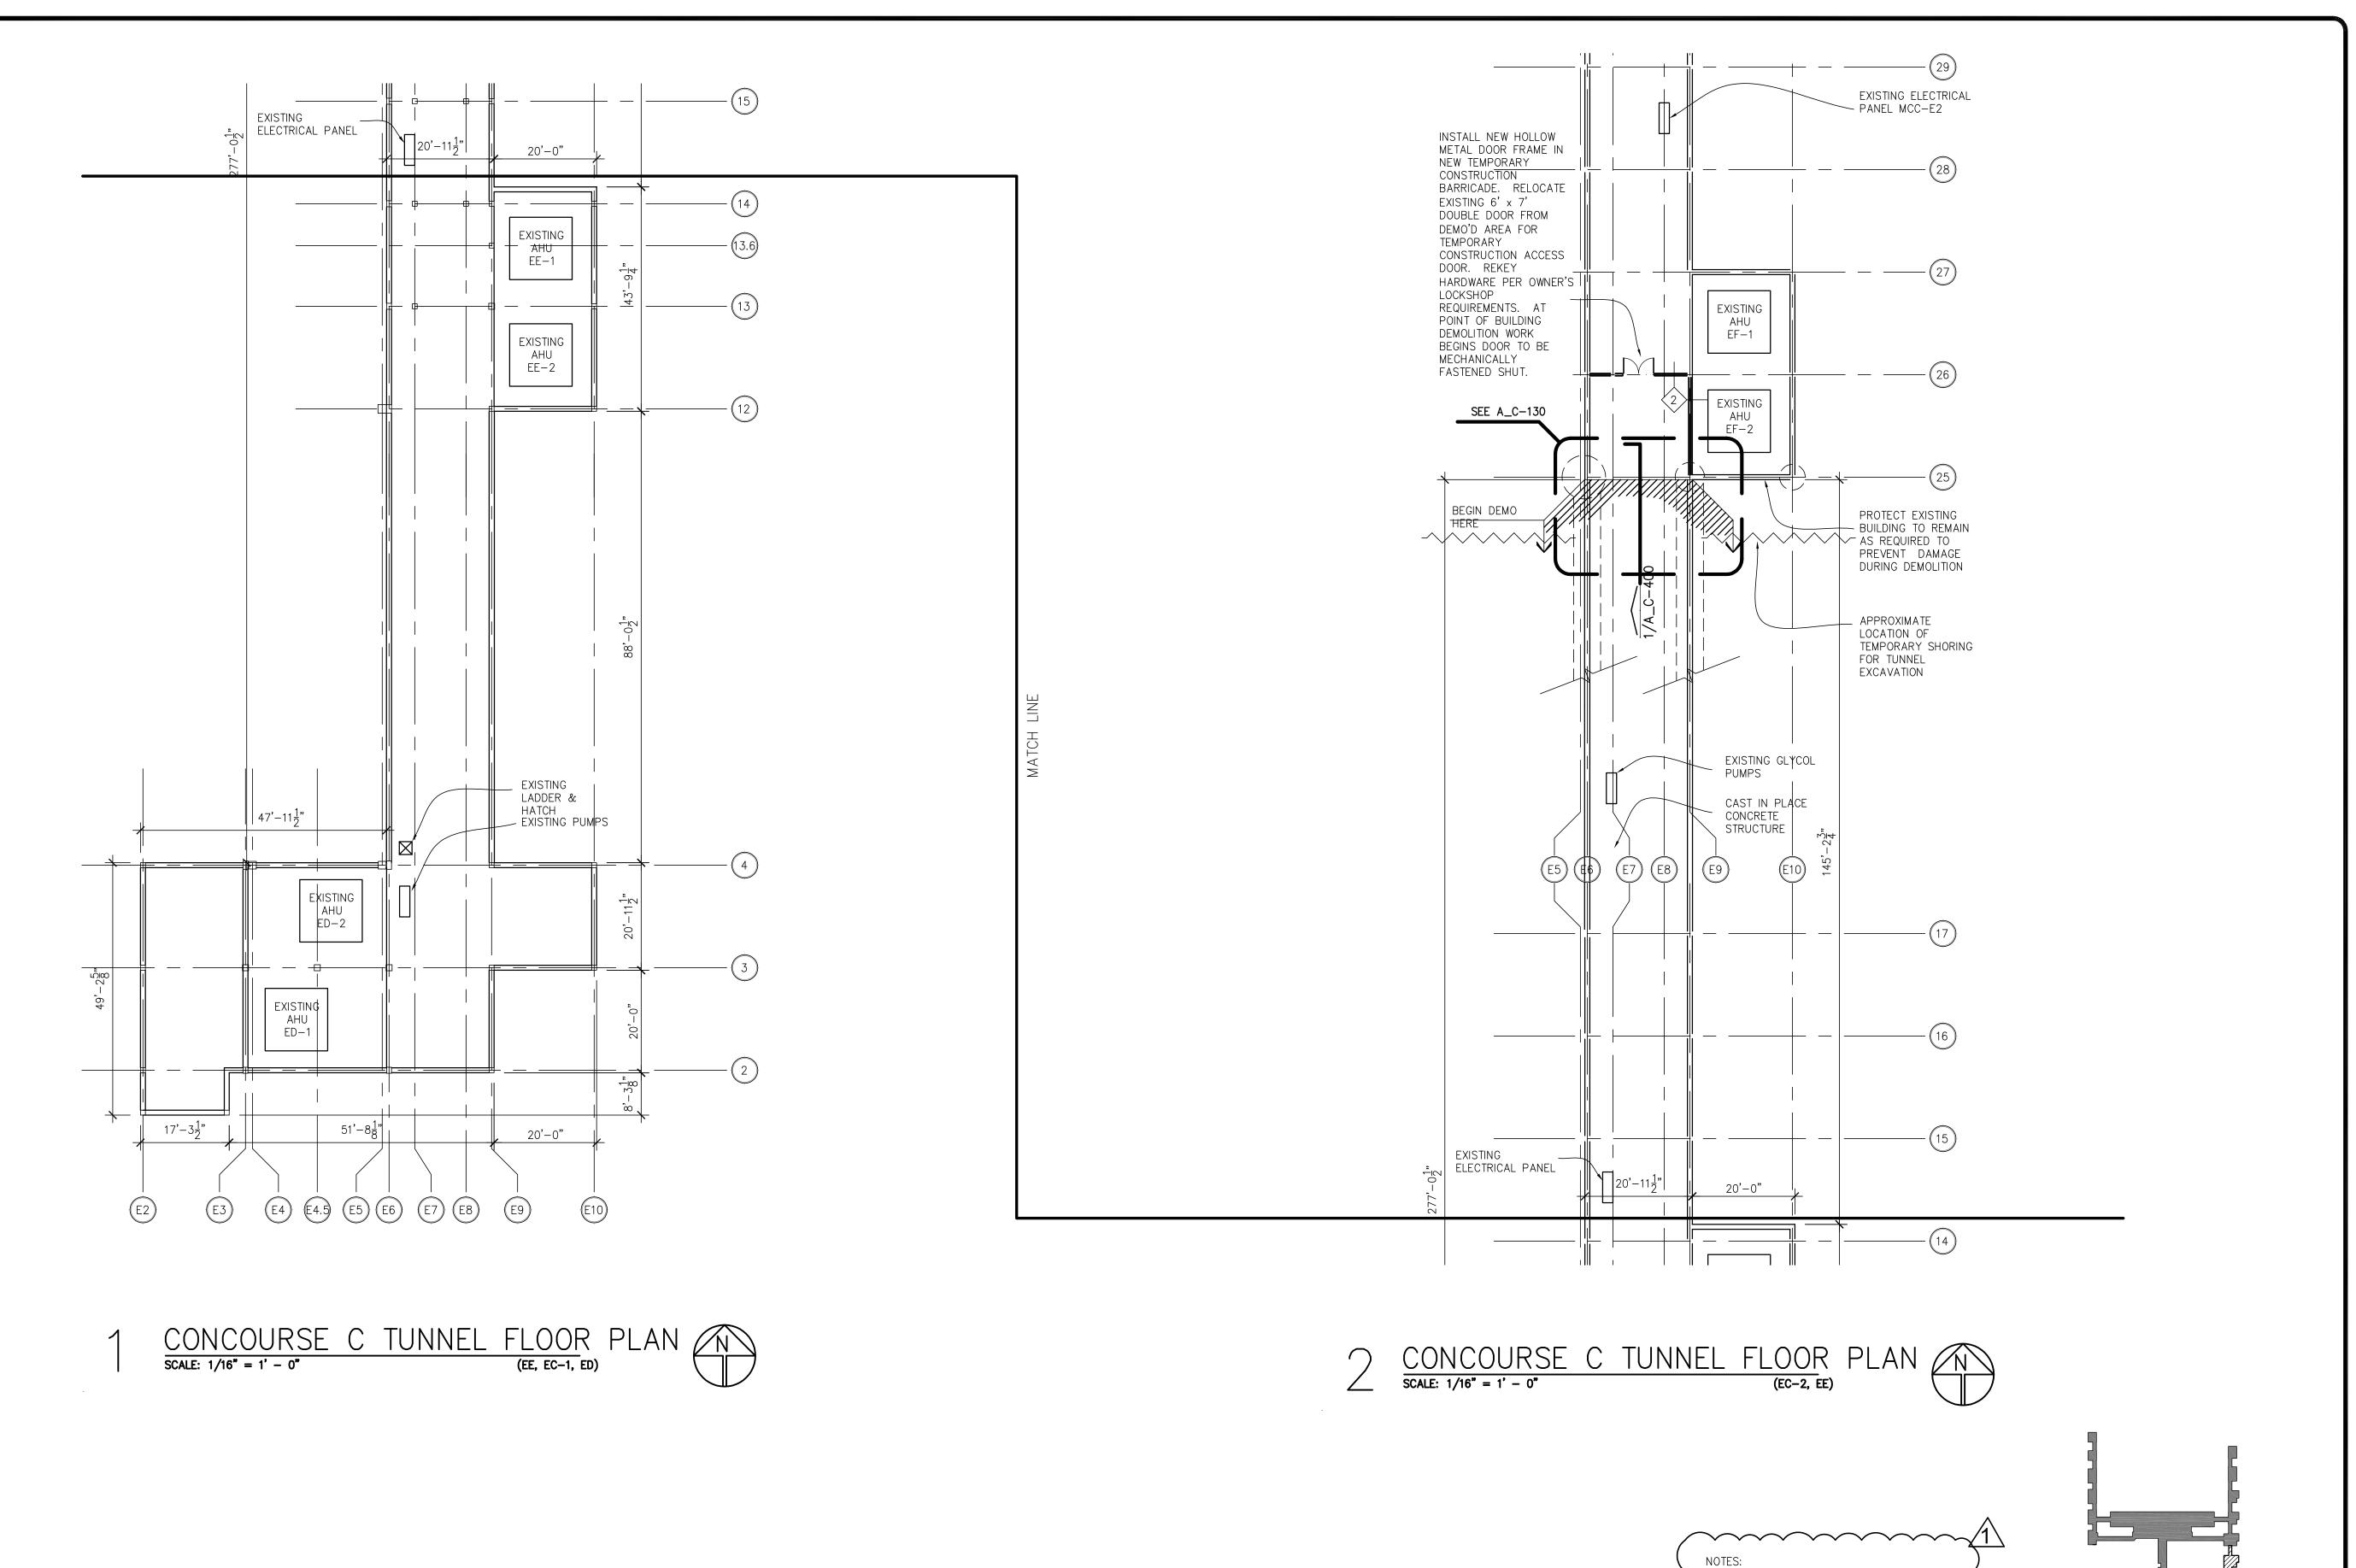


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1	ADDENDUM #3	06.22
NO.	DESCRIPTION	DATE
		-

REVISIONS

PROJECT:

**TERMINAL APRON** RECONSTRUCTION CONCOURSE C -**SOUTH DEMO** 

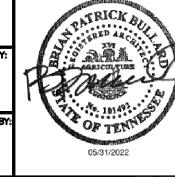SHEET TITLE:

1. TEMPORARY EXCAVATION SHORING SHALL BE BASED ON A STRUCTURAL ASSESSMENT

AND ENGINEERED BY THE CONTRACTOR PENDING THE APPROVAL OF THE OWNER,

ARCHITECT, AND/OR ENGINEER.
PARAMETERS AND LIMITS FOR TEMPORARY
EXCAVATION SHORING ARE SET FORTH IN


SPECIFICATIONS SECTION P-152.


**CONCOURSE C TUNNEL FLOOR PLAN** 

MSCAA NO. 13-1368-02 DWG. FILE NAME 13030\_A-100

05/31/22

A\_C-100 1/16" = 1'-0" FACILITY NO. 7 OF 56 XXXXX

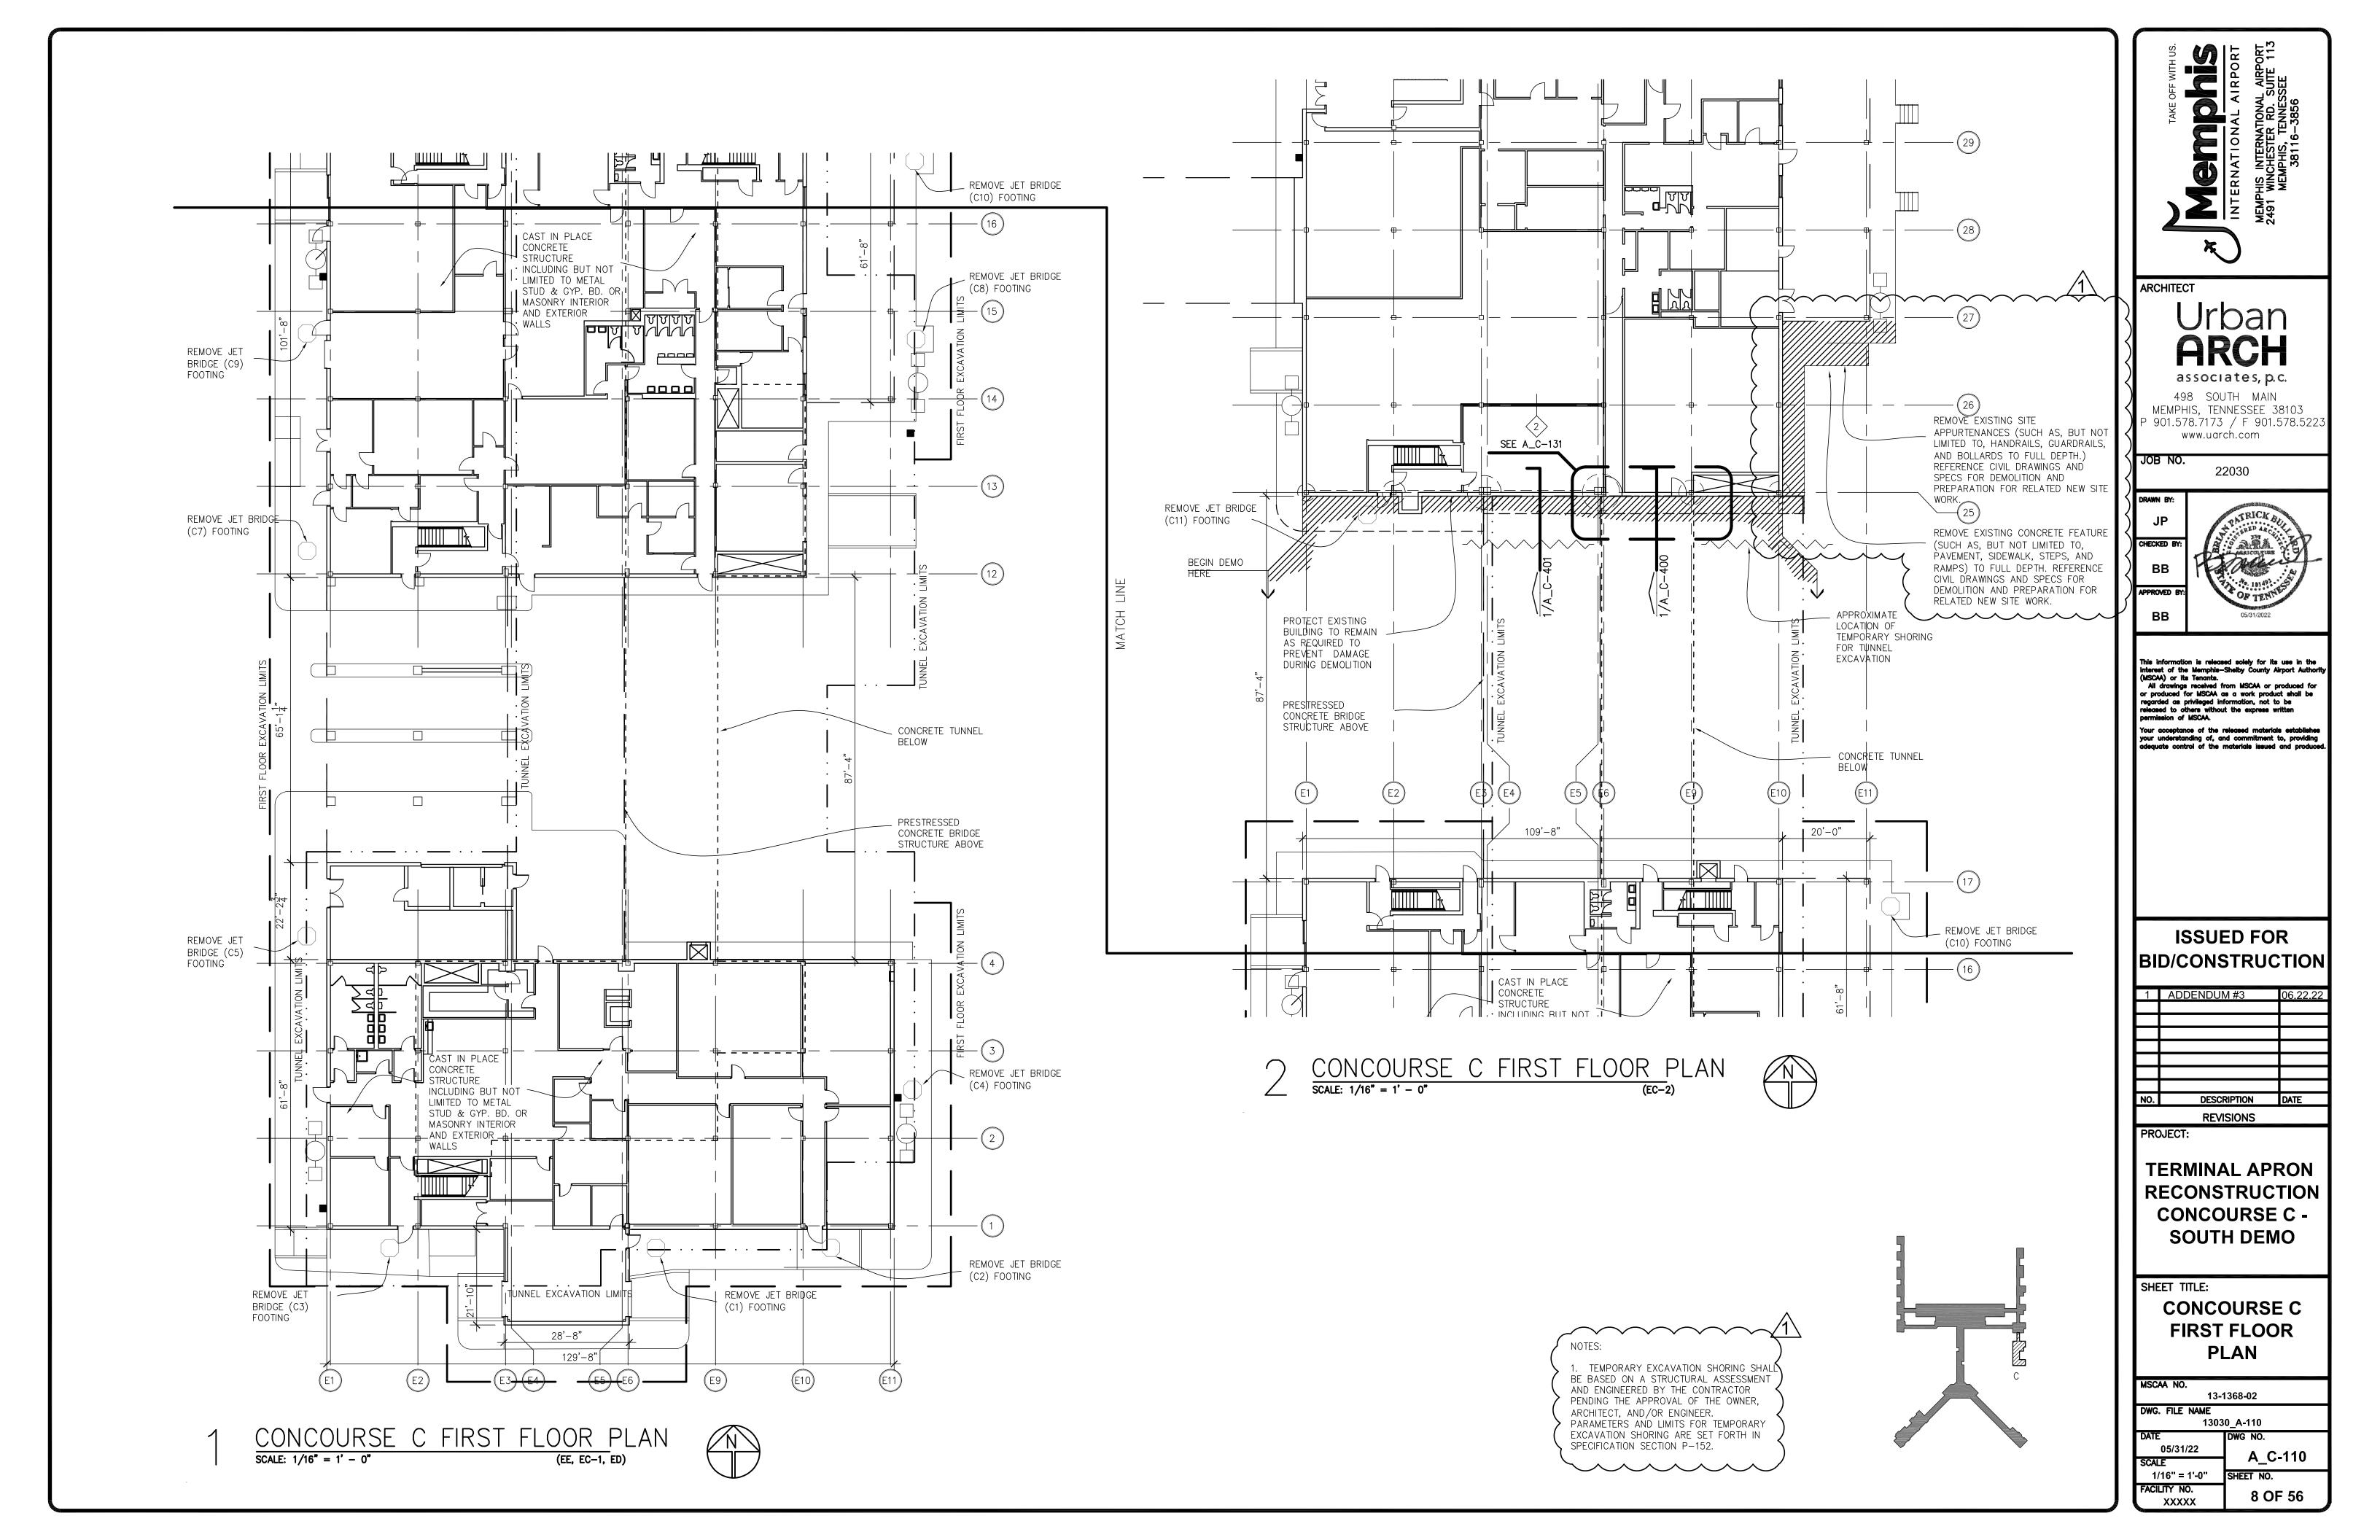


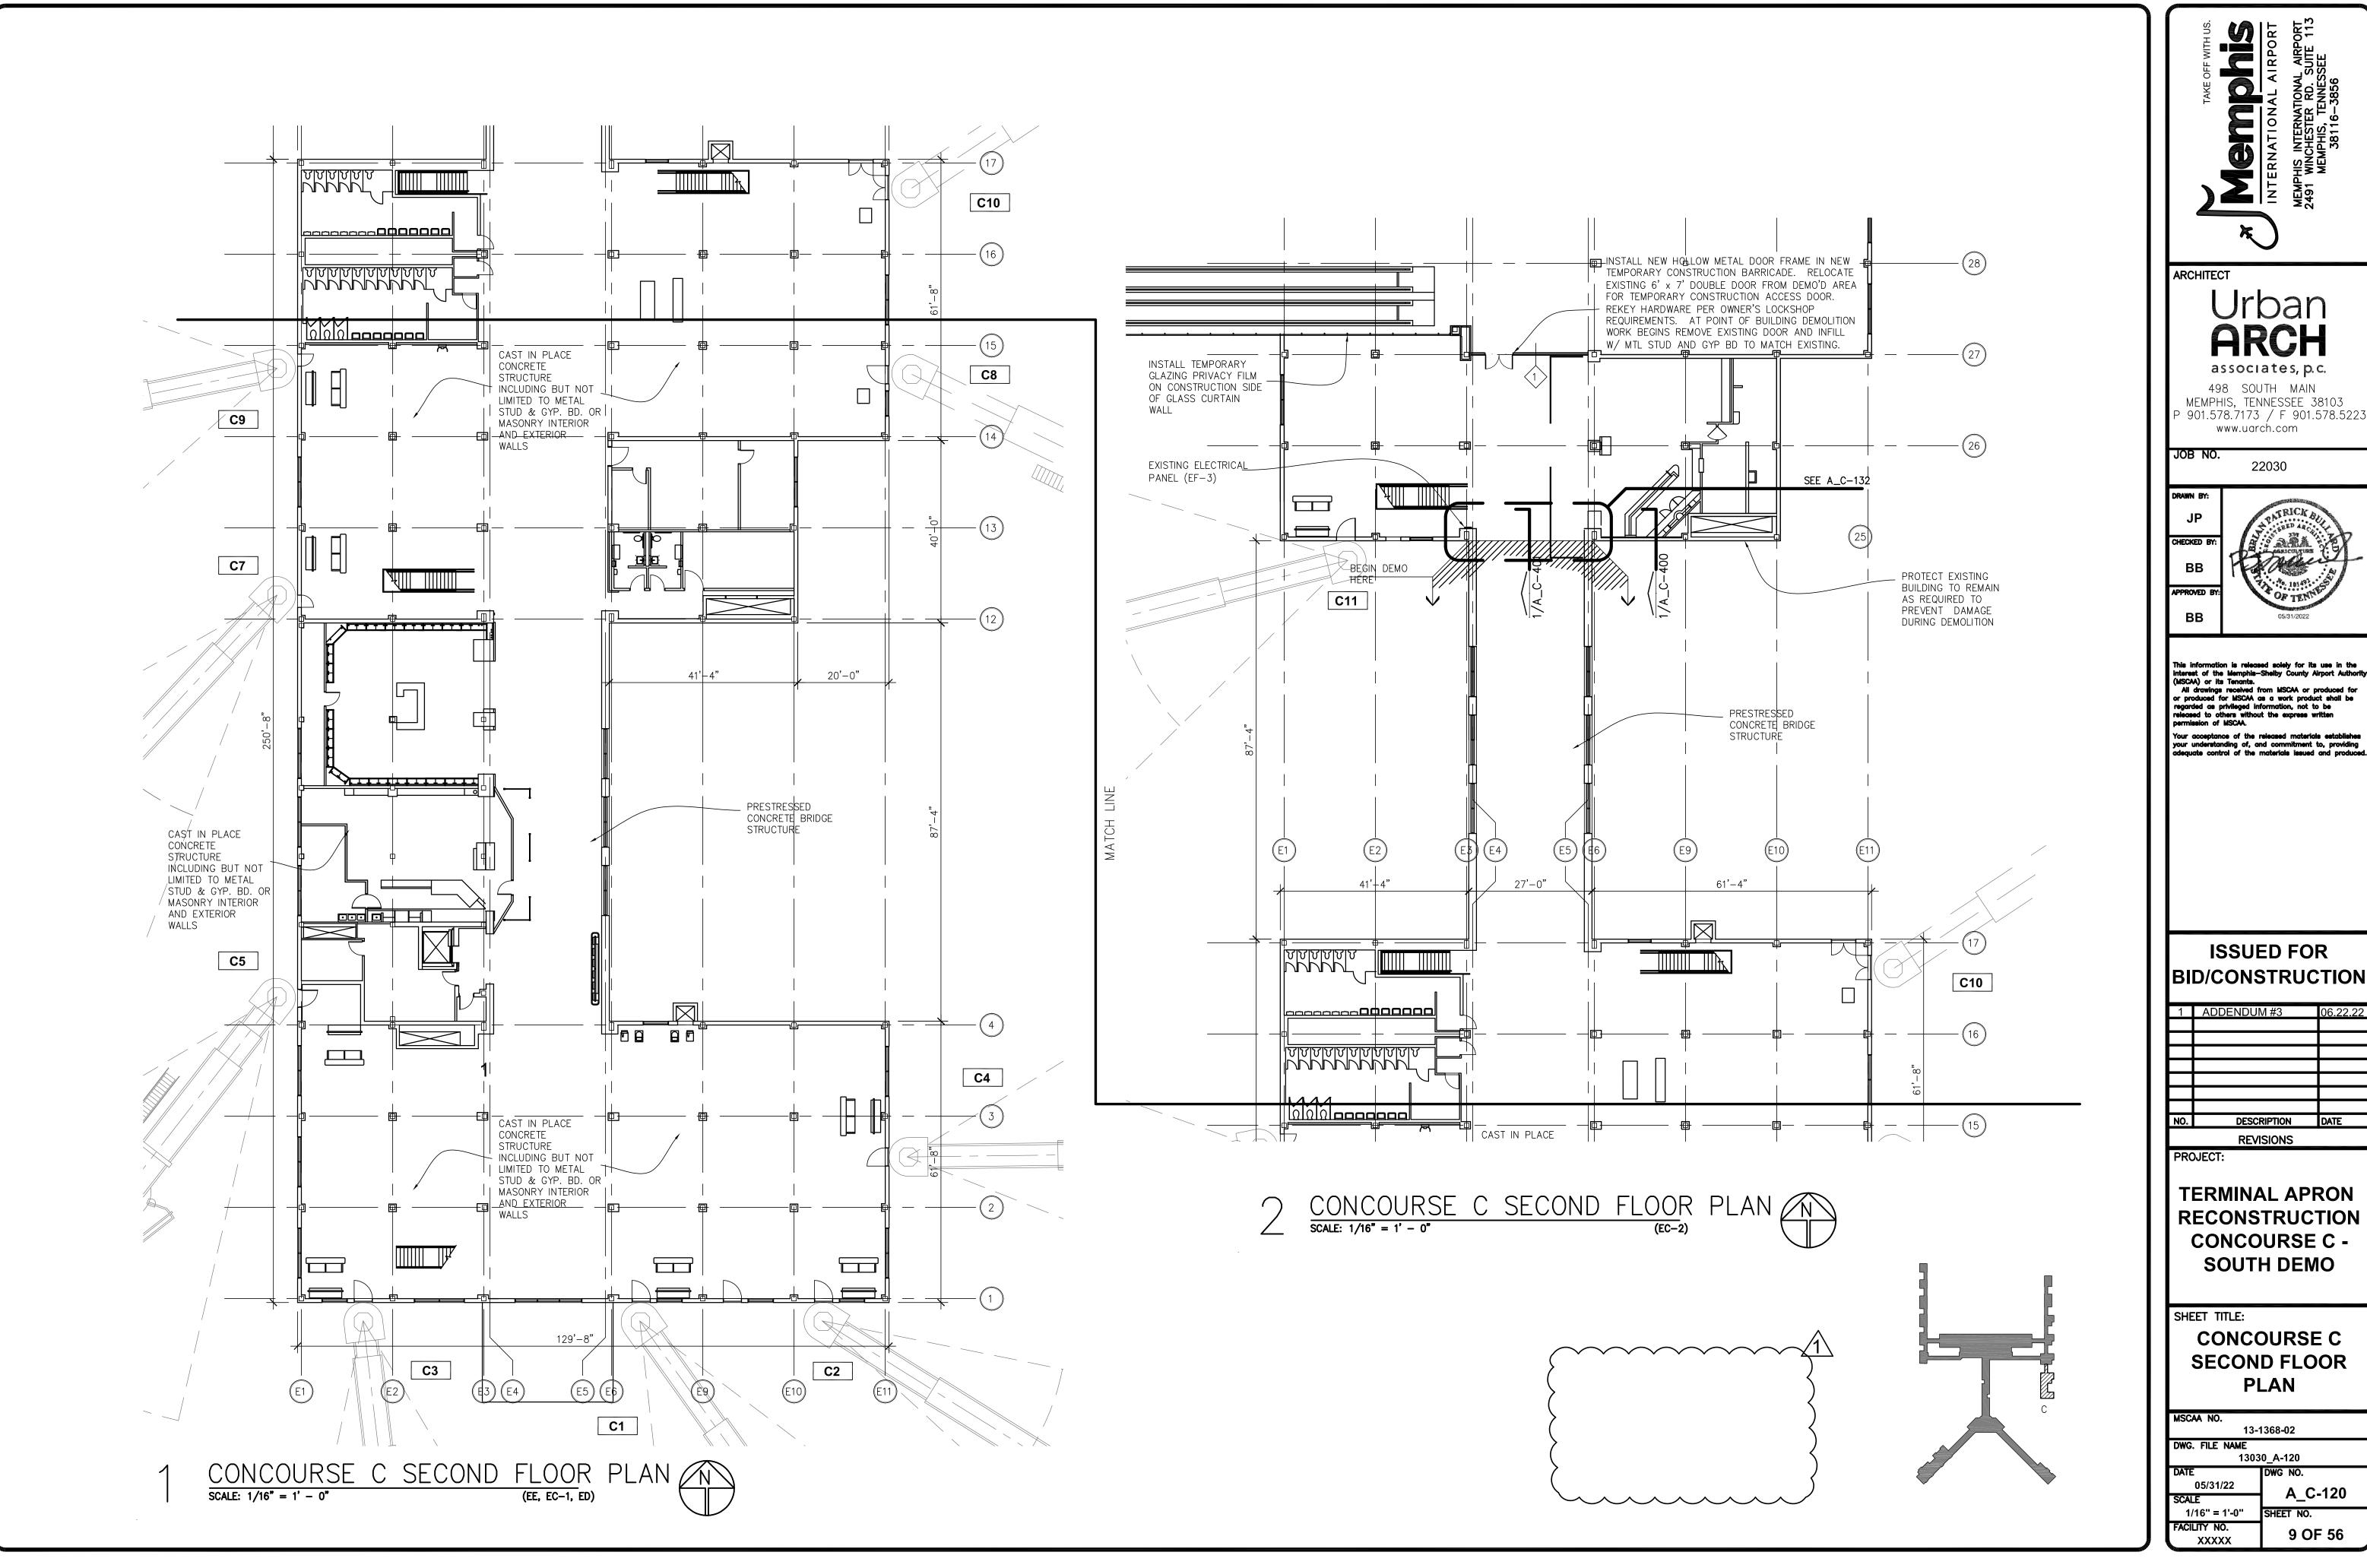



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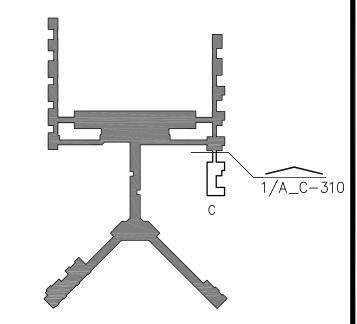


RECONSTRUCTION



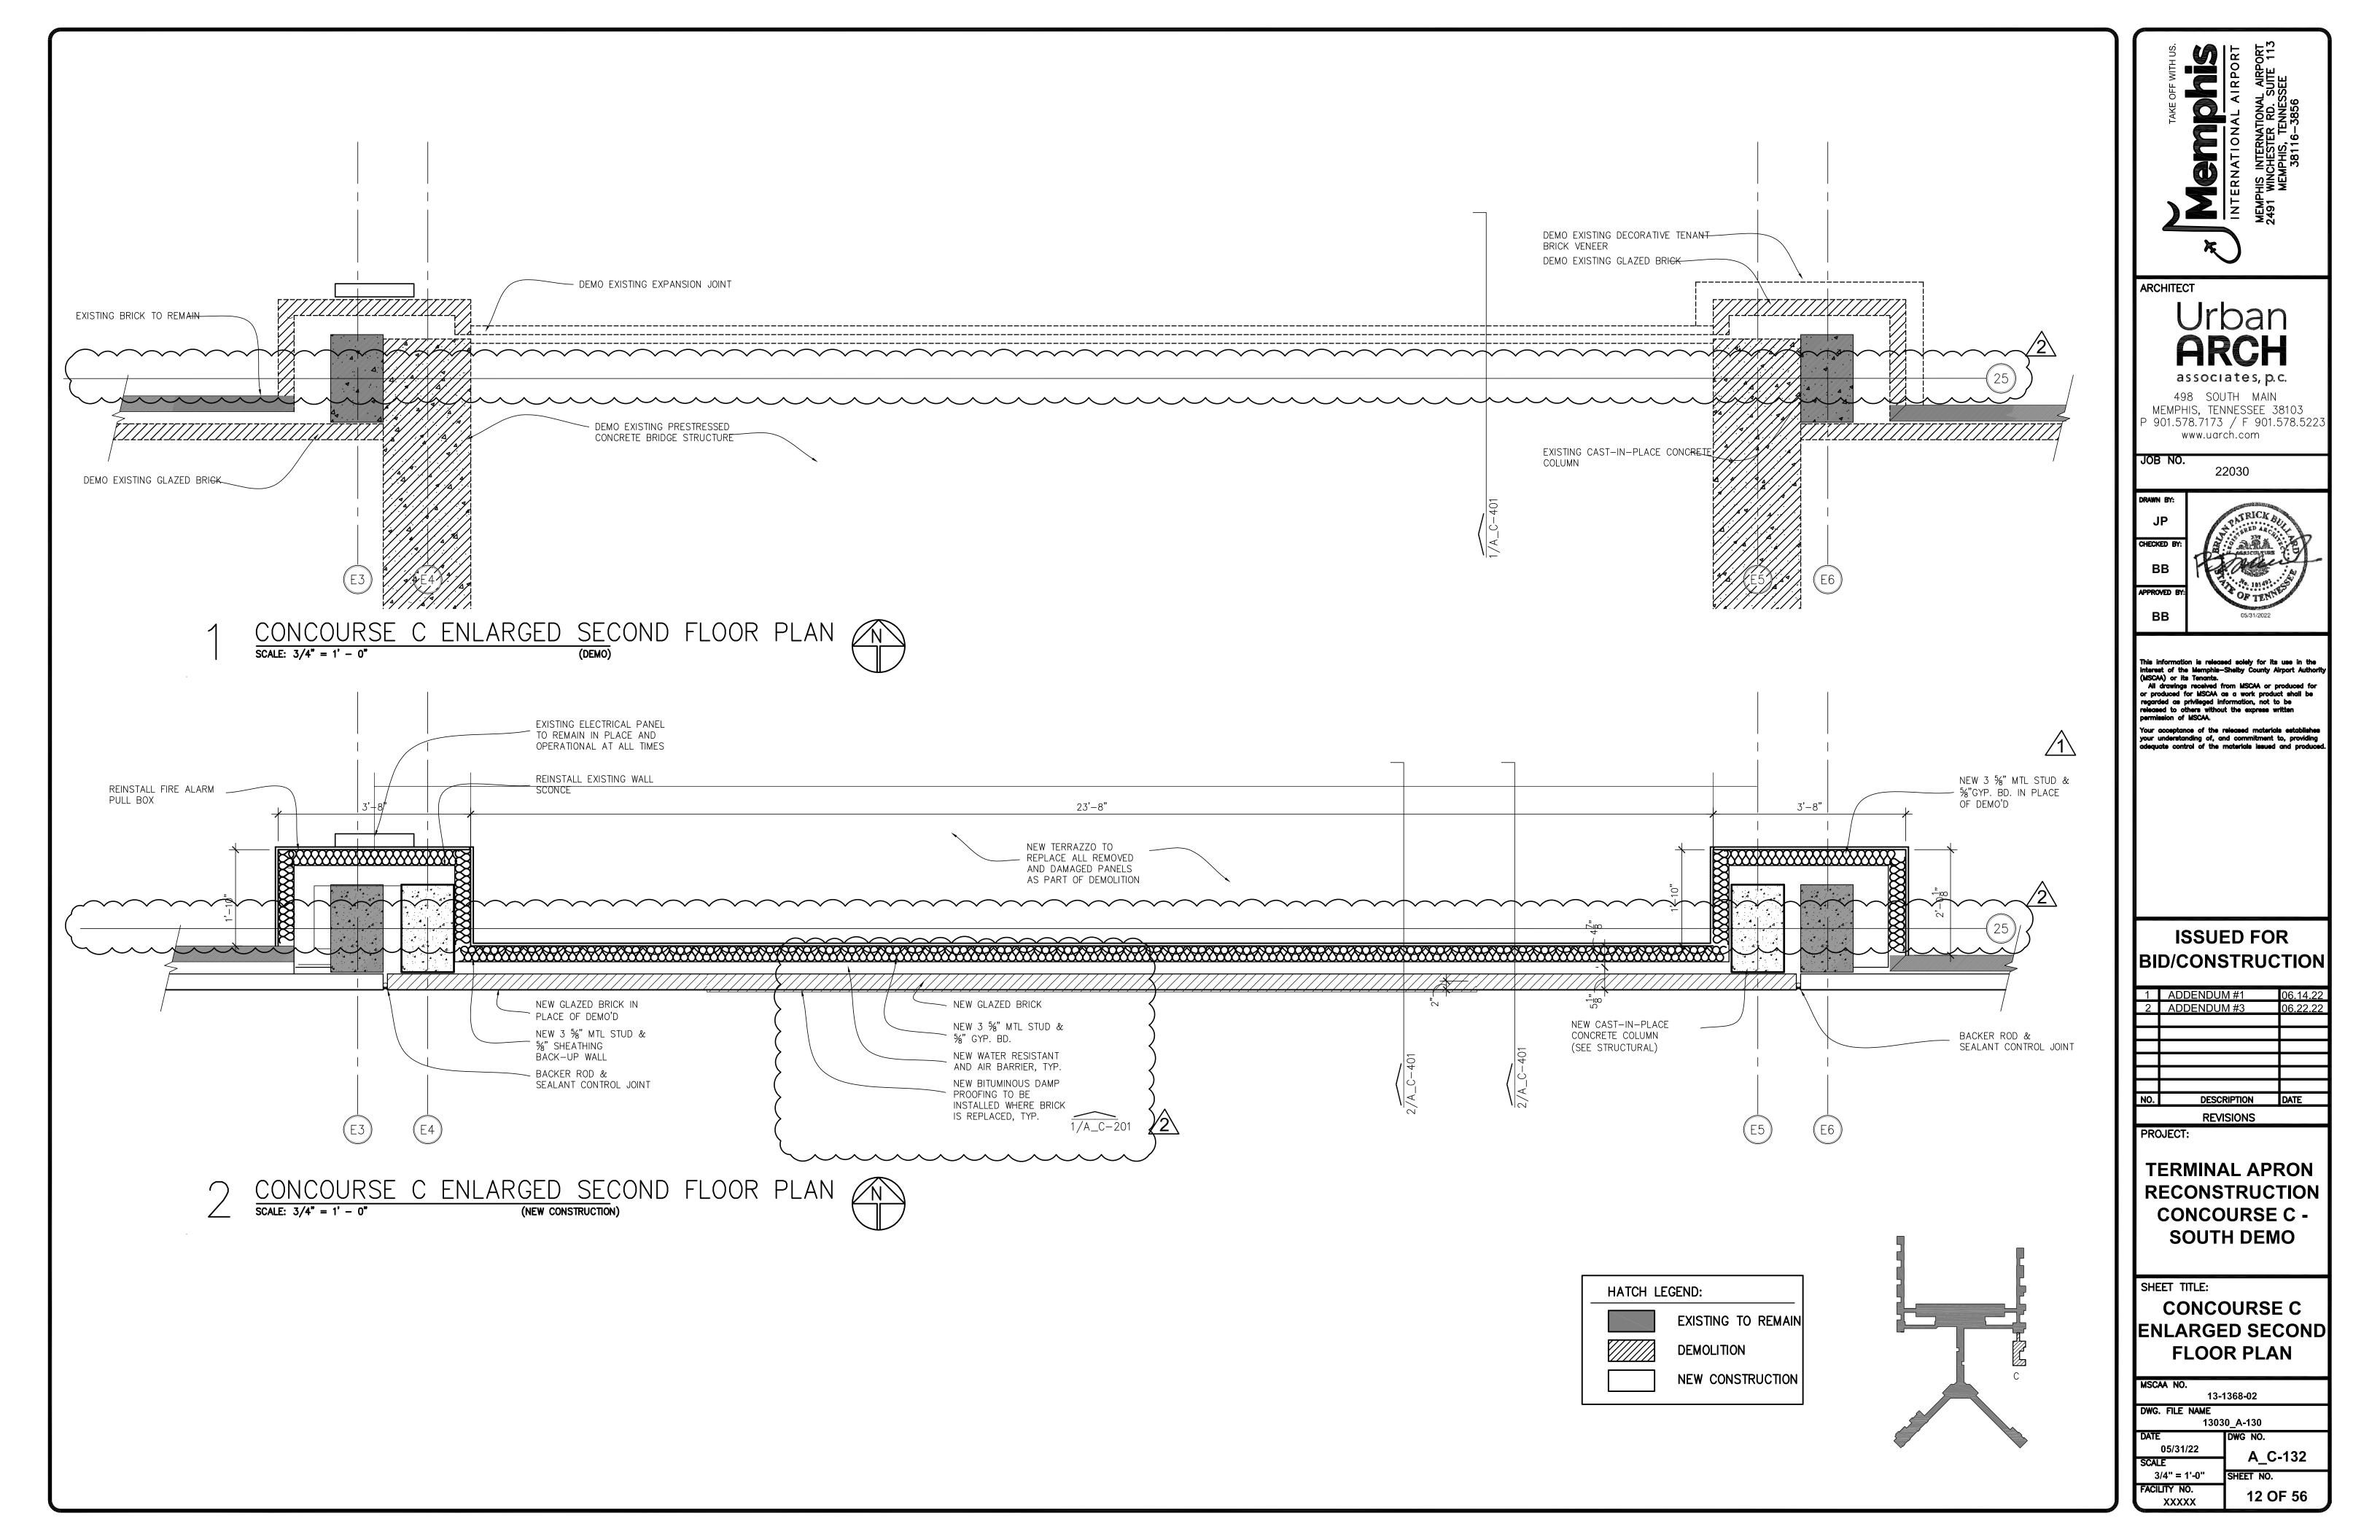

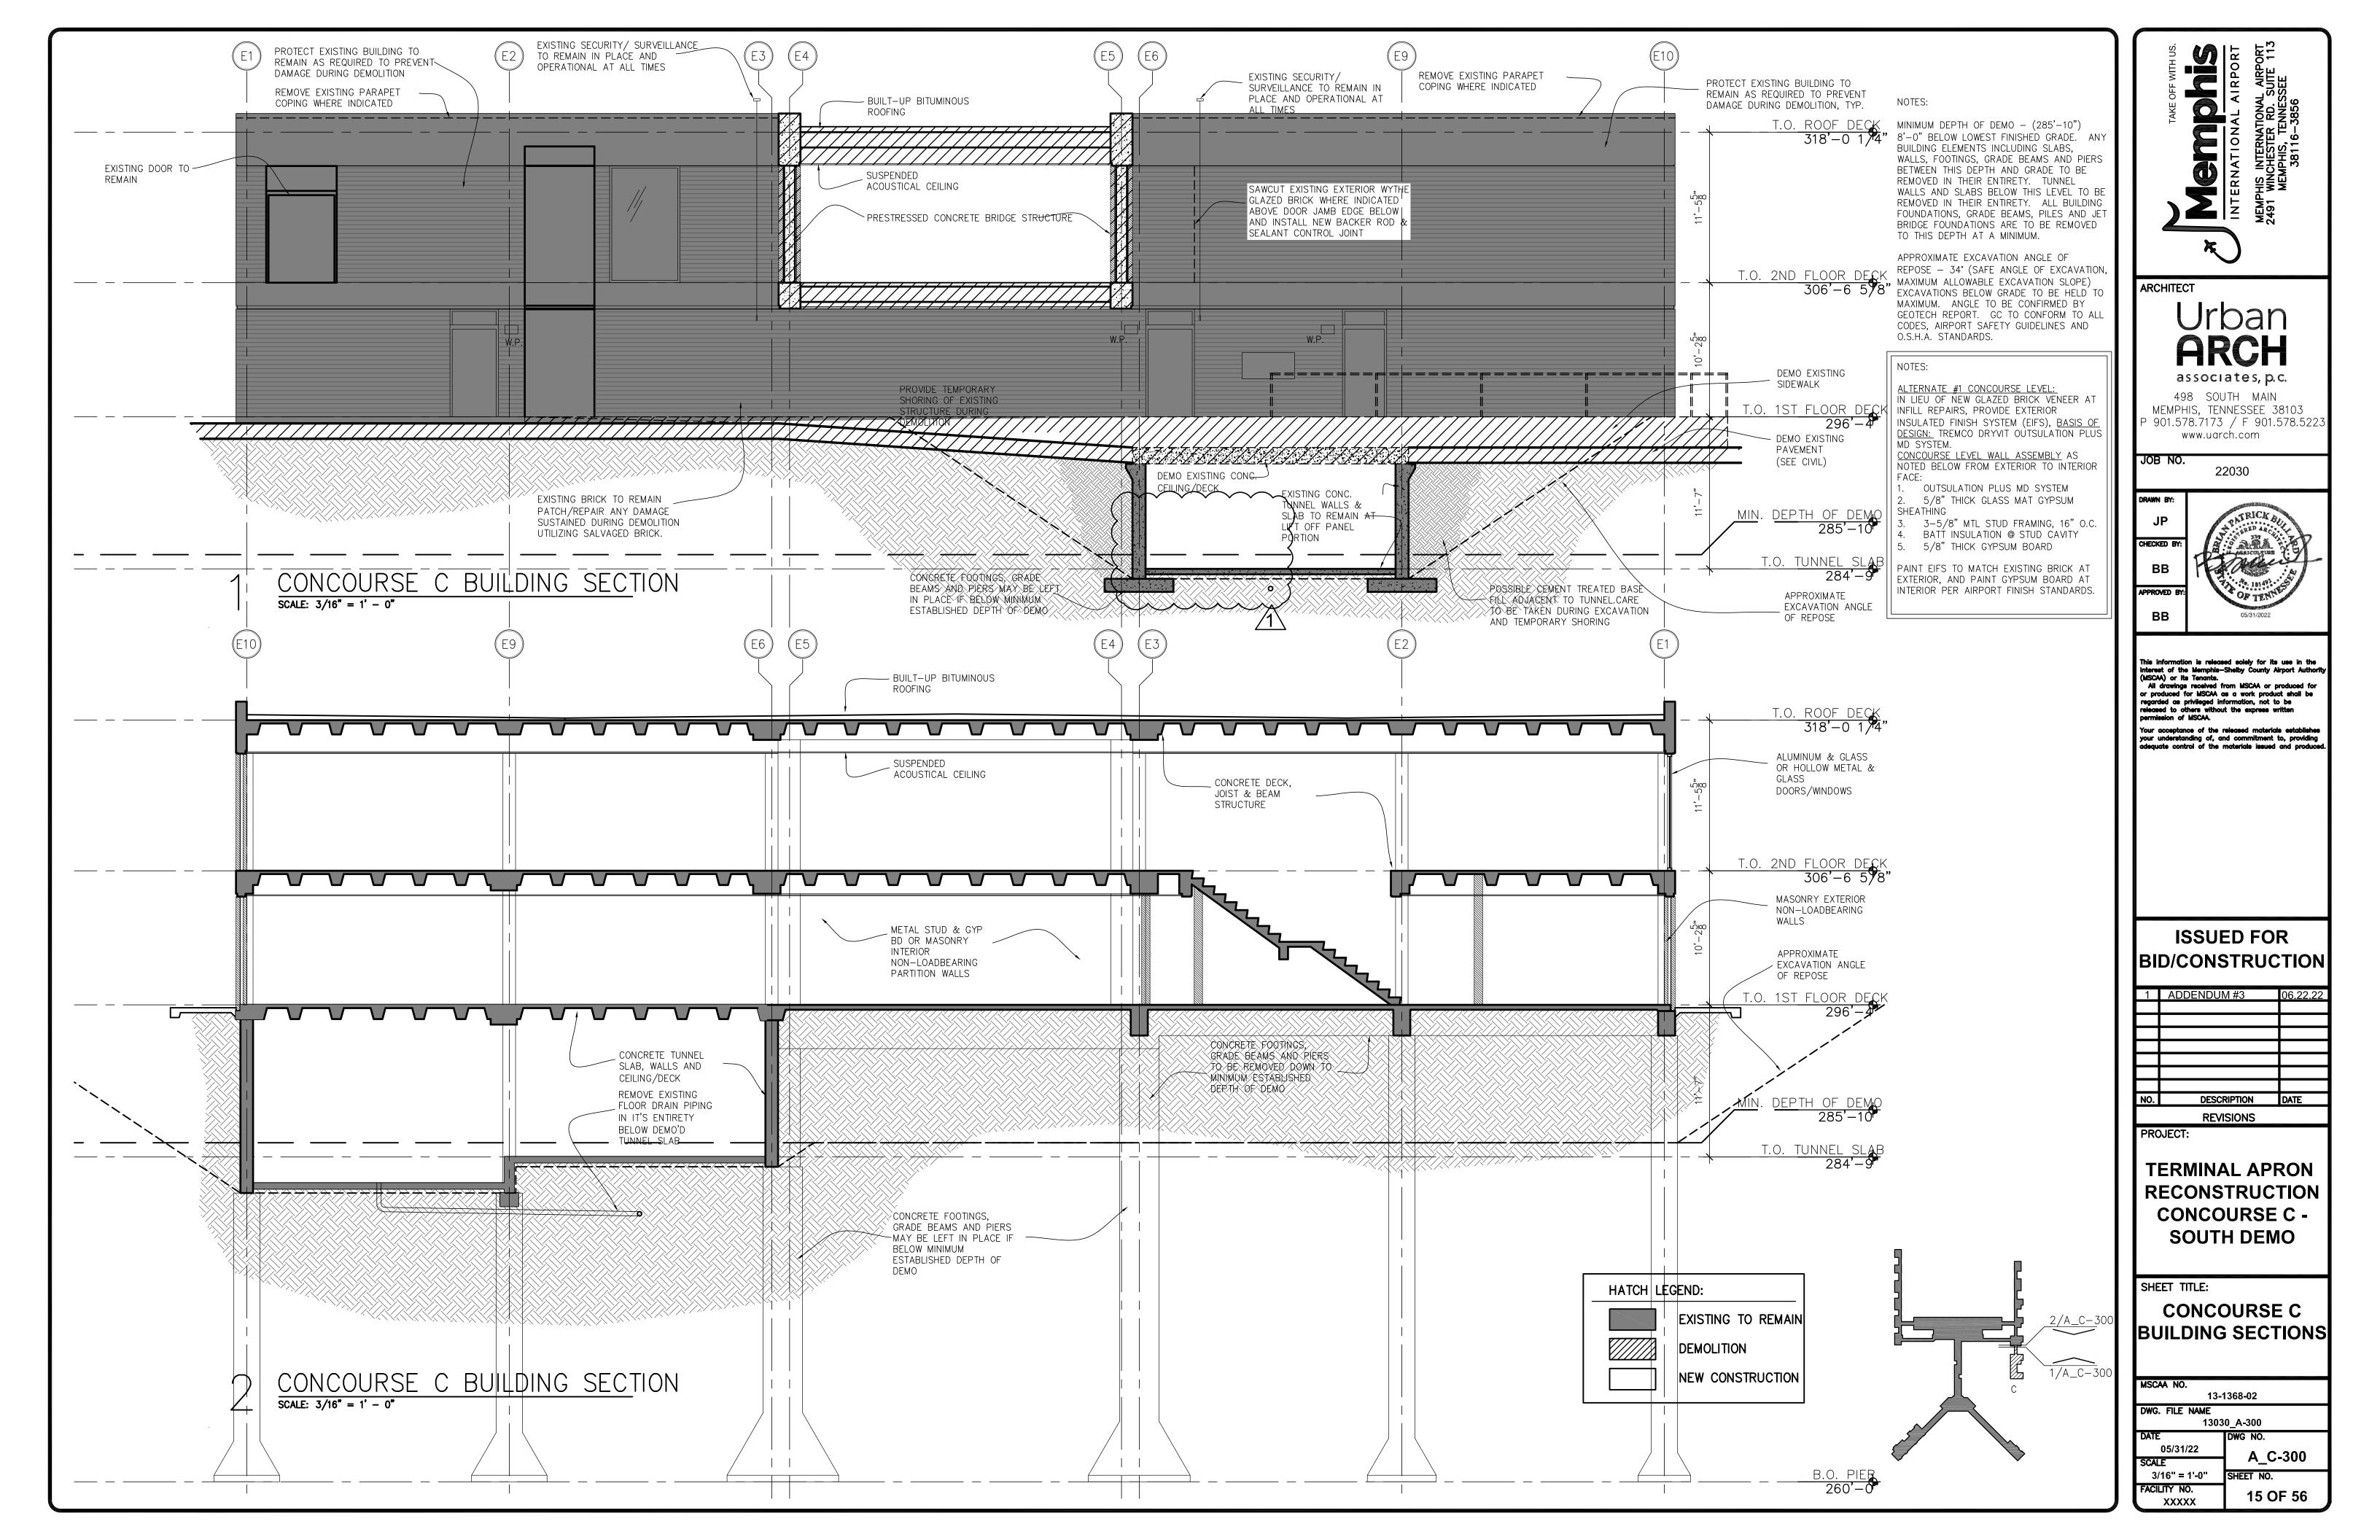

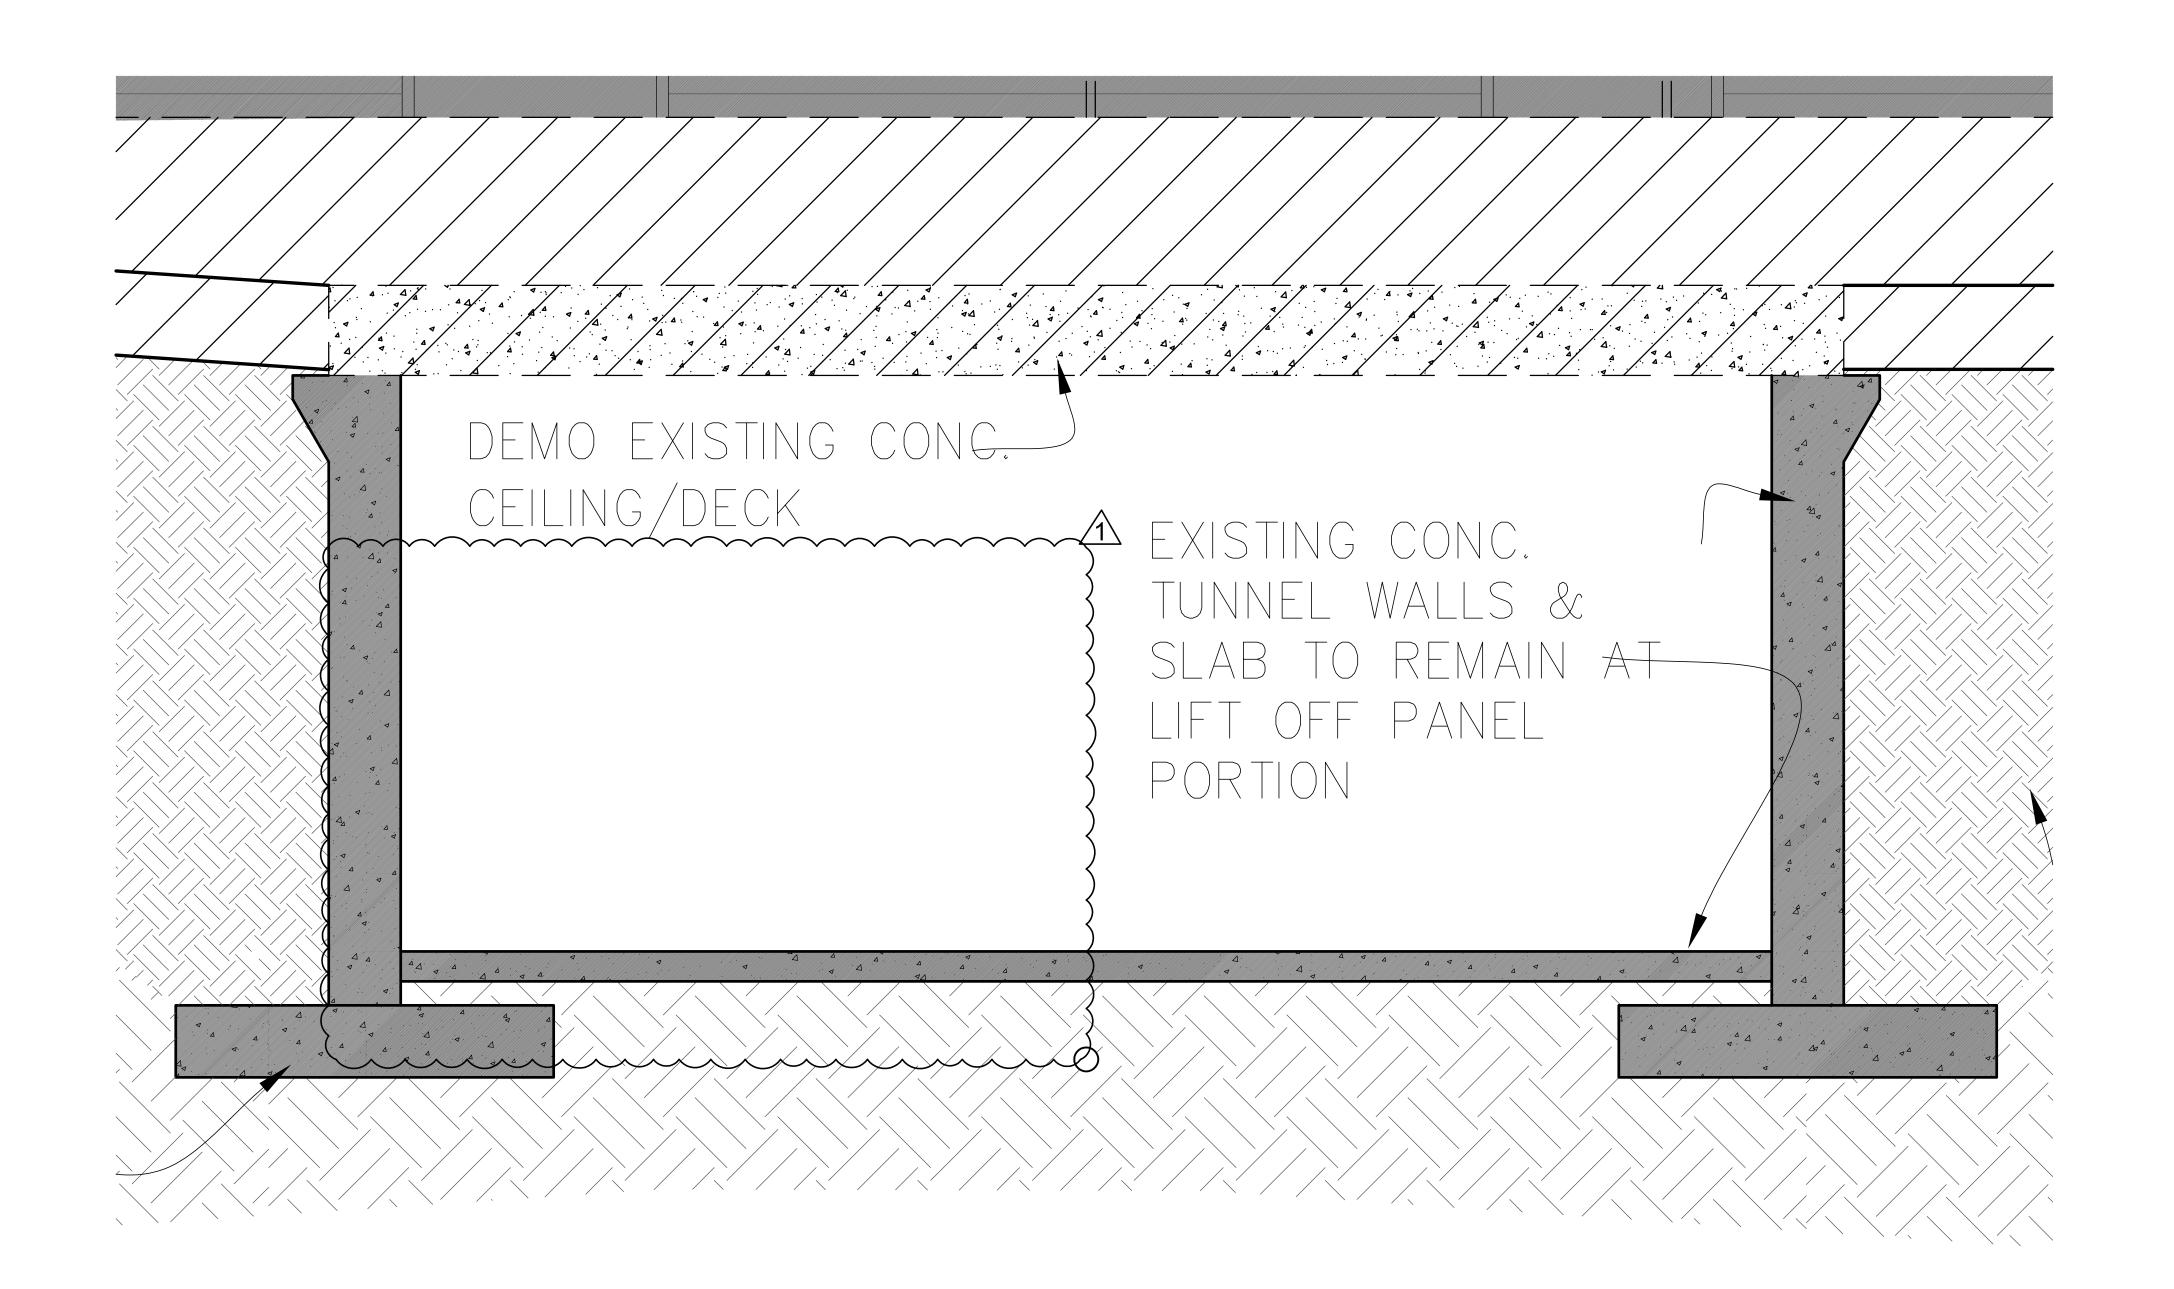



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1	ADDENDUM #3	06.22
NO.	DESCRIPTION	DATE
·	REVISIONS	

PROJECT:

TERMINAL APRON

RECONSTRUCTION CONCOURSE C -**SOUTH DEMO** 

SHEET TITLE:


**CONCOURSE C BUILDING SECTIONS** 

13-1368-02

XXXXX

13030-BS\_48 05/31/22

A\_C-310 3/4" = 1'-0" SHEET NO. FACILITY NO. X OF X

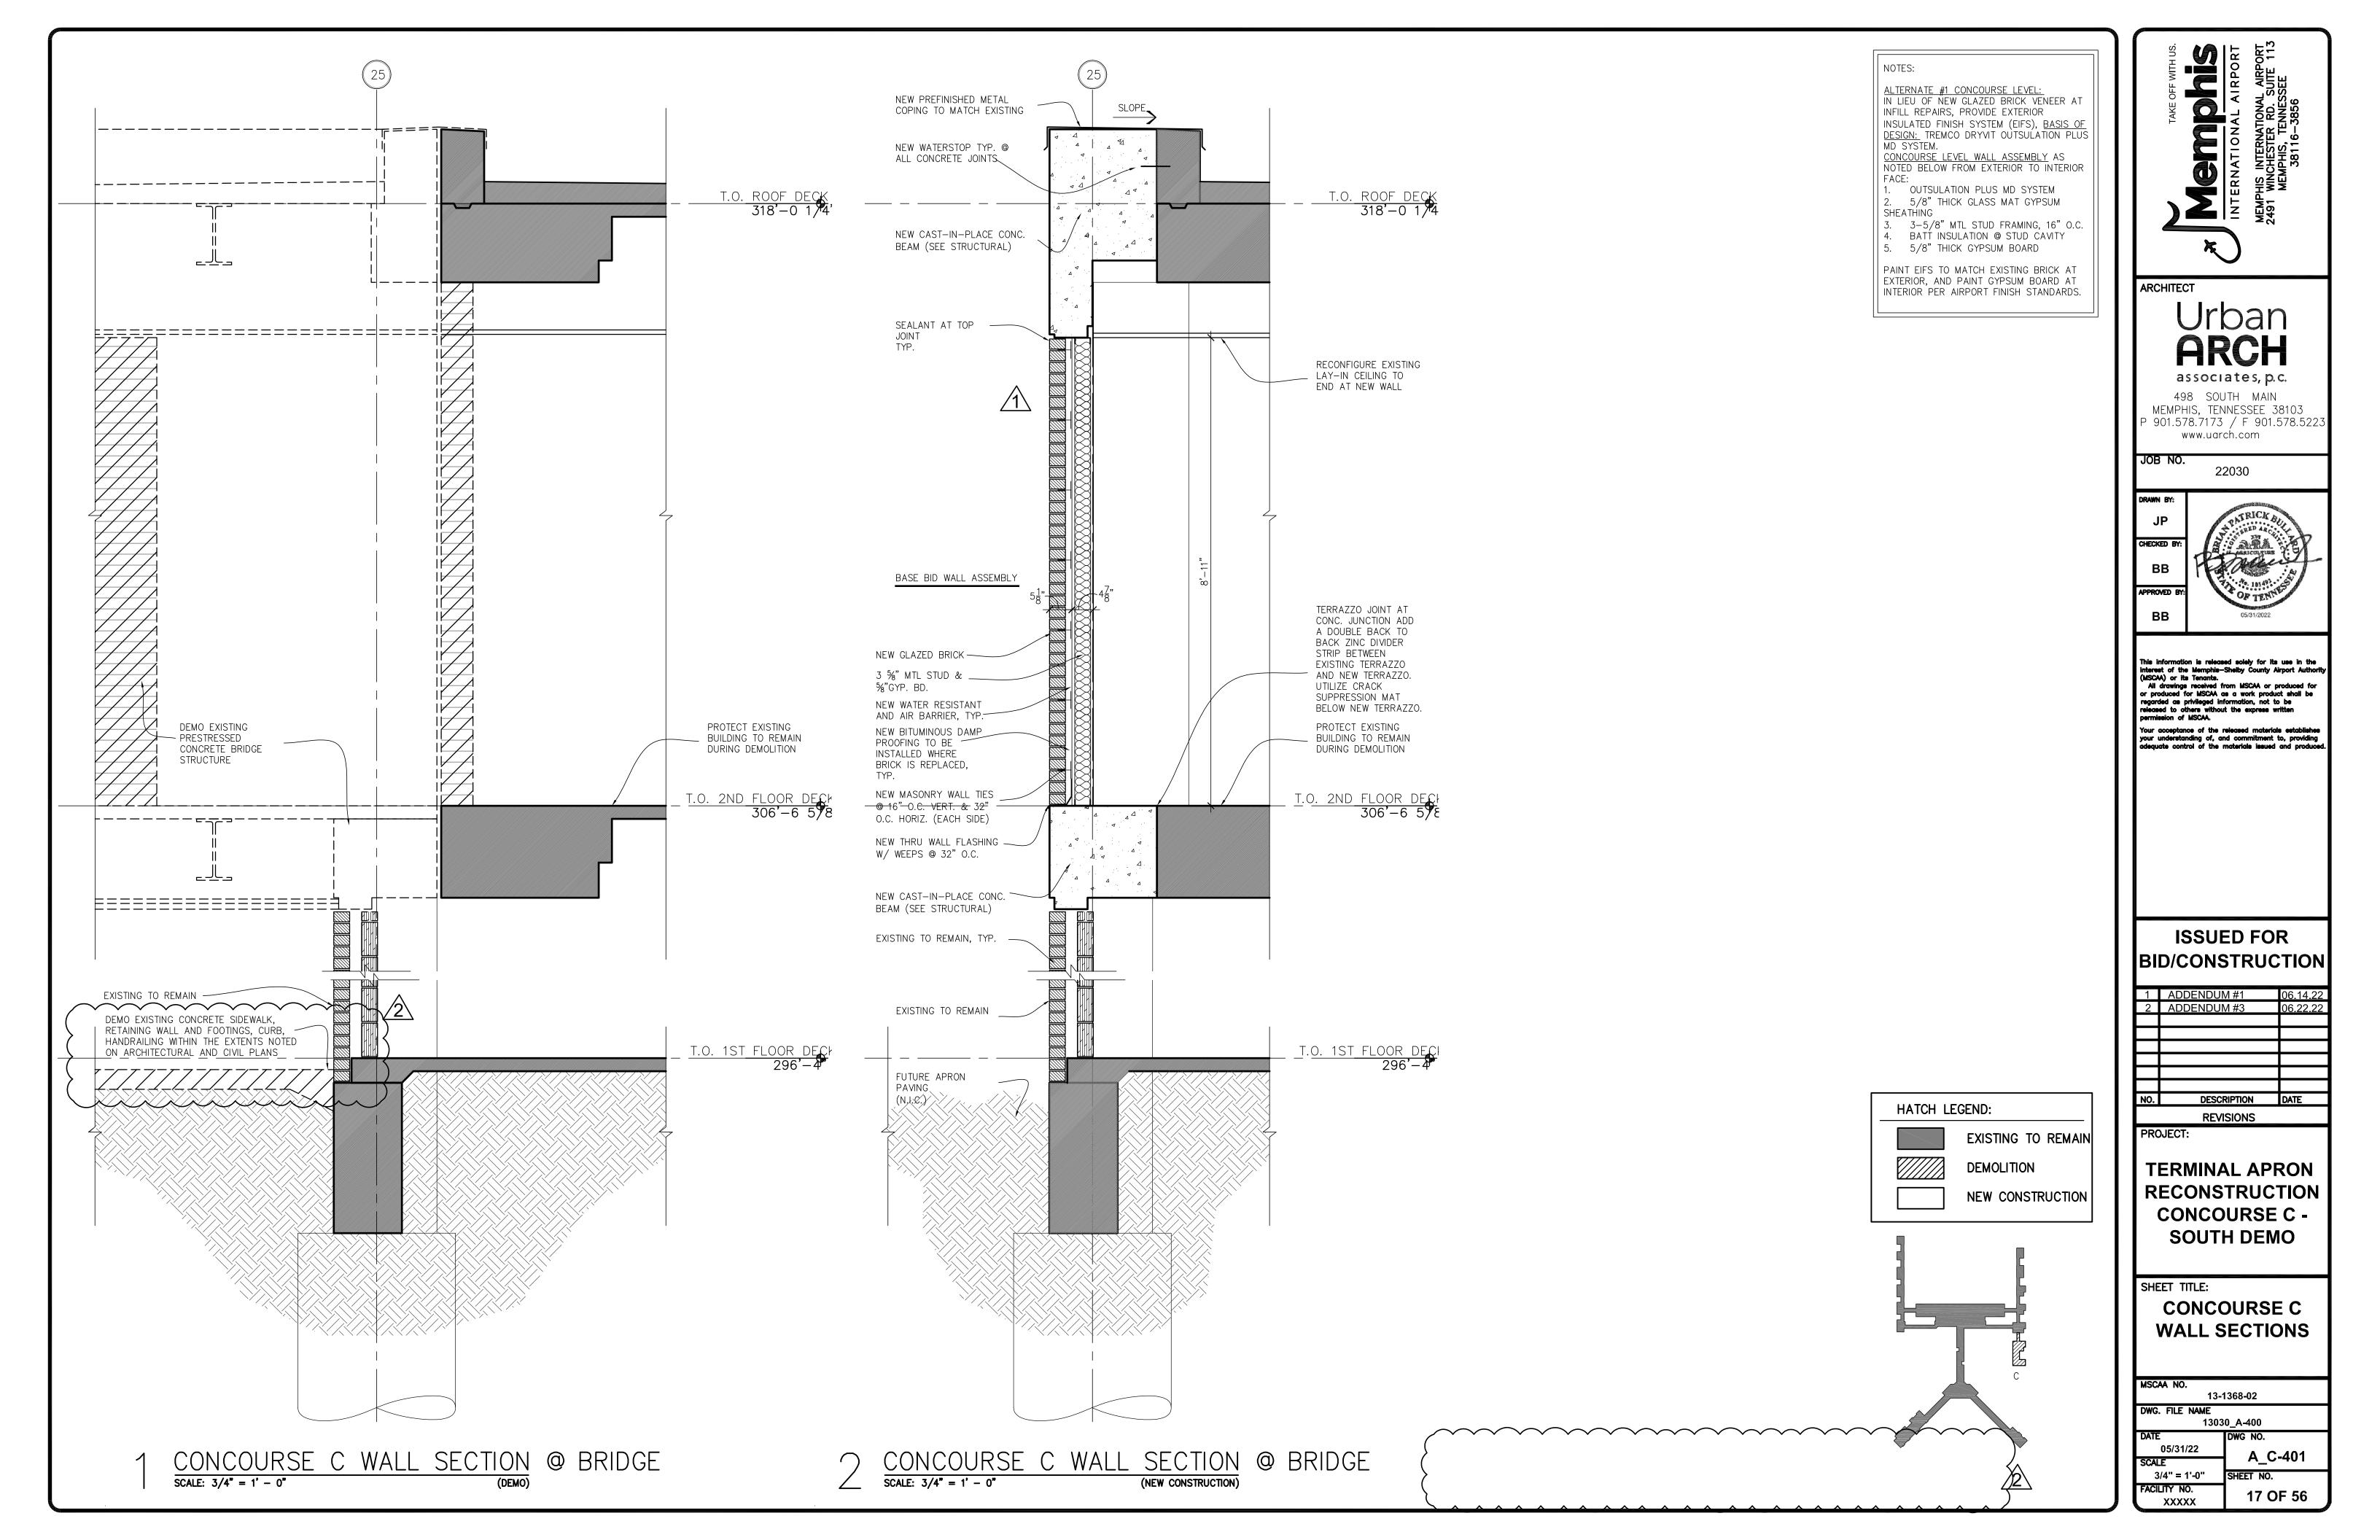


	ITEM	FAA SPEC			QUAN	NTITY
=N	No.	No.	DESCRIPTION	UNIT	ORIGINAL	FINA
		<u> </u>	MISCELLANEOUS ITEMS		ONIGINAL	I IIVA
	1	C-100-14.1	CONTRACTOR QUALITY CONTROL PROGRAM (CQCP)	LS	1	
_						
_	2	C-102-5.1	SEDIMENT TUBE	LF	300	
	3	C-102-5.2	EROSION CONTROL BARRIER	LF	200	
	4	C-102-5.3	SILTFENCE	LF	1,000	
_	5	C-102-5.4	MANHOLE SEDIMENT TRAP	EA	3	
	6 7	C-102-5.5 C-102-5.6	SEDIMENT BASIN TEMPORARY CONSTRUCTION EXIT	EA EA	2	
_	<u>'</u>	0-102-3.0	TEMP ORART CONSTRUCTION EXT		2	
	8	S-100-6.1	GUARD HOUSE	EA	2	
	9	S-100-6.2	FIELD OFFICE TRAILER AND CURRING FACILITIES	LS	1	
	10 11	S-100-6.3 S-100-6.4	CROSSING GATE ARM PROJECT SAFETY & SECURITY	LS EA	4	
	11	3-100-0.4	PROJECT SAFETT & SECURIT	LS	1	
	12	S-101-5.1	UTILITY MARKERS	EA	25	
	13	S-103-5.1	EXTERIOR BUILDING REPAIRS	SF	200	
_	13	3-103-5.1	EXTERIOR BUILDING REPAIRS	35	200	
			WATER LINE ITEMS	•		
	14	S-105-5.1	12" DUCTILE IRON PIPE WITH RESTRAINED JOINTS	LF	300	
	15	S-105-5.2	6" DUCTILE IRON PIPE WITH RESTRAINED JOINTS	LF EA	30	
_	16 17	S-105-5.3 SC-30-4	FLUSH MOUNTED FIRE HYDRANT MLGW WATER LINE FEES	EA ALLOW	1	
	17			, , , , , , , , , , , , , , , , , , , ,		
			DEMOLITION ITEMS			
	18	P-101-5.1	PAVEMENT DEMOLITION, CONCRETE (ALL THICKNESS AND TYPES)	SY	14,500	
		P-101-5.2 P-101-5.3	PAVEMENT DEMOLITION, ASPHALT (ALL THICKNESS AND TYPES) STABILIZED BASE DEMOLITION, CONCRETE (ALL THICKNESS AND TYPES)	SY	14,500 14,500	
_		. 131 0.0			11,550	
	21	P-150-4.1	DEMOLITION OF EXISTING STORM DRAIN PIPE (ALL SIZES)	LF	500	
	22	P-150-4.2	DEMOLITION OF EXISTING STORM DRAIN MANHOLE	EA	2	
	23 24	P-150-4.3 P-150-4.4	DEMOLITION OF EXISTING SANITARY SEWER PIPE (ALL SIZES)  DEMOLITION OF EXISTING SANITARY SEWER MANHOLE	LF EA	400	
<u> </u>	25	P-150-4.5	DEMOLITION OF EXISTING SANITARY SEWER WANTIOLE  DEMOLITION OF EXISTING WATER PIPE (ALL SIZES)	LF	1,200	
	26	P-150-4.6	REMOVE EXISTING FLUSH MOUNTED FIRE HYDRANT	EA	3	
	27	P-150-4.7	DEMOLITION OF EXISTING METAL GUARDRAIL	LF	150	
<u>.</u>	28	P-150-4.8	DEMOLITION OF EXISTING ABANDONED PASSENGER BOARDING BRIDGE FOUNDATIONS	EA	10	
-	29 30	P-150-4.9 P-150-4.10	REMOVE EXISTING WATER CABINET REMOVE EXISTING PASSENGER BOARDING BRIDGE CARGO LIFT	EA EA	5 3	
	31	P-150-4.11	REMOVE EXISTING LIGHT POLE AND FOUNDATION	EA	4	
	32	P-150-4.12	DEMOLITION OF EXISTING FUEL PIPE (ABANDONED/SLURRY-FILLED)	LF	490	
_	33	P-150-4.13	DEMOLITION OF EXISTING HYDRANT PIT (INACTIVE)	EA	4	
			L CIVIL ITEMS			
	34	P-152-4.1	UNCLASSIFIED EXCAVATION	CY	2,500	
	35	P-152-4.2	UNDERCUT EXCAVATION	CY	200	
_	36	P-152-4.3	UNSUITABLE MATERIAL EXCAVATION AND DISPOSAL	CY	100	
_	37 38	P-152-4.4 P-152-4.5	BORROW EXCAVATION PETROLEUM IMPACTED SOIL EXCAVATION (NON-REGULATED)	CY	1,500 300	
	38	P-152-4.5 P-152-4.6	PETROLEUM IMPACTED SOIL EXCAVATION (NON-REGULATED) PETROLEUM IMPACTED SOIL EXCAVATION (NON-HAZARDOUS SPECIAL WASTE)	CY	100	
_	40	P-152-4.8	SUBGRADE PREPARATION	SY	16,625	
	41	P-152-4.9	GRANULAR BACKFILL	CY	100	
_	42	P-152-4.10	LIME	TON	200	
_	43	P-209-5.1	CRUSHED AGGREGATE BASE COURSE	CY	300	
	-	D 6/6 = 1	DEOVOLED CONCRETE ACCRECATE TOO CONCRETE ACCRECATE TOO		1.5.5	
_	44	P-219-5.1	RECYCLED CONCRETE AGGREGATE FOR GENERAL USE	CY	100	
	45	P-220-6.1	CEMENT TREATED SOIL BASE COURSE	SY	16,625	
	46	P-220-6.2	CEMENT	TON	850	
	47	P-304-8.1	CEMENT-TREATED AGGREGATE BASE COURSE (8-INCH THICK)	SY	16,625	
	.,	1 001 0.1	DEMIETT TREATED ROCKES (TE BROE GOORGE (G II TOTT THIOTY)	01	10,020	
	48	P-306-8.1	LEAN CONCRETE BASE COURSE	SY	2,310	
_	49	S-102-6.1	POROUS BITUMINOUS BASE COURSE (4" THICK)	SY	16,625	
					. 5,520	
_	50	P-501-8.1	PORTLAND CEMENT CONCRETE PAVEMENT (18 INCH THICK)	SY	16,625	
	51	P-610-6.1	STEEL PIPE BOLLARDS	EA	10	
	52	P-610-6.1	PROTECTIVE CONCRETE APRON	SF	1,120	
		P-610-6.3	TYPE 2 CONCRETE LANDING WITH RAMPS	SF	200	
	53		TYPE 3 CONCRETE LANDING WITH DAMPS	CE	040	
	54	P-610-6.4	TYPE 3 CONCRETE LANDING WITH RAMPS	SF 	210	
	54 55	P-610-6.5	PEDESTRIAN HANDRAIL	LF	50	
	54	+				

			SCHEDULE OF ESTIMATED QUANTITIES	3		
I FNI I	FAA SPEC No.	DESCRIPTION	UNIT	QUANTITY		
	No.	INO.			ORIGINAL	FINAL
	58	P-620-5.1	PAVEMENT MARKINGS WITHOUT REFLECTIVE BEADS	SF	1,500	
	59	P-620-5.2	EXISTING PAINT MARKING REMOVAL	SF	4,000	
î\—	60	P-620-5.3	PAVEMENT MARKING WITH REFLECTIVE BEADS	SF	2,000	
			DRAINAGE ITEMS			
	61	D-701-5.1	18 INCH REINFORCED CONCRETE PIPE (CLASS V)	LF	152	
	62	D-701-5.2	24 INCH REINFORCED CONCRETE PIPE (CLASS V)	LF	105	
	63	D-701-5.3	CONCRETE FOR PIPE PLUGS AND COLLARS	CY	10	
	64	D-705-5.1	4 INCH PERFORATED UNDERDRAIN PIPE	LF	750	
î	65	D-705-5.2	UNDERDRAIN CLEANOUT - CONCRETE	EA	11	
	66	D-751-5.1	STORM DRAIN MANHOLE (5' DIAMETER, > 4' - 8' DEPTH)	EA	1	
	67	D-751-5.2	STORM DRAIN MANHOLE (6' DIAMETER, > 4' - 8' DEPTH)	EA	1	
	68	D-751-5.3	STORM DRAIN INLET (4'x4', > 4' - 8' DEPTH)	EA	2	
	69	D-751-5.4	TRENCH DRAIN (ALL DEPTHS)	LF	340	

## **FOOTNOTES (FN):**

- ESTIMATED)ITEM TO BE USED AS DIRECTED BY THE PROGRAM MANAGER.
- 2 OWNERSHIP OF ITEM AFTER REMOVAL TO REMAIN WITH MSCAA.
- 3 OWNERSHIP OF ITEM AFTER REMOVAL TO REMAIN WITH CONTRACTOR.
- 4 OWNERSHIP OF ITEM AFTER REMOVAL TO REMAIN WITH MLG&W.

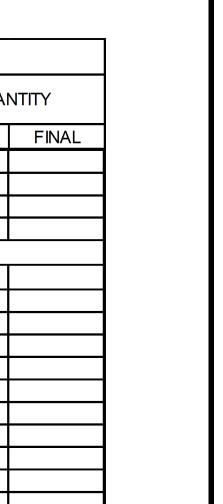

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DESCRIPTION REVISIONS


TERMINAL APRON RECONSTRUCTION CONCOURSE C -**SOUTH DEMO** 

SHEET TITLE:

**SCHEDULE OF ESTIMATED QUANTITIES** 

13-1368-02 13136802\_G-QT-01 05/31/22 G-QT-01

FACILITY NO. 20 OF 87

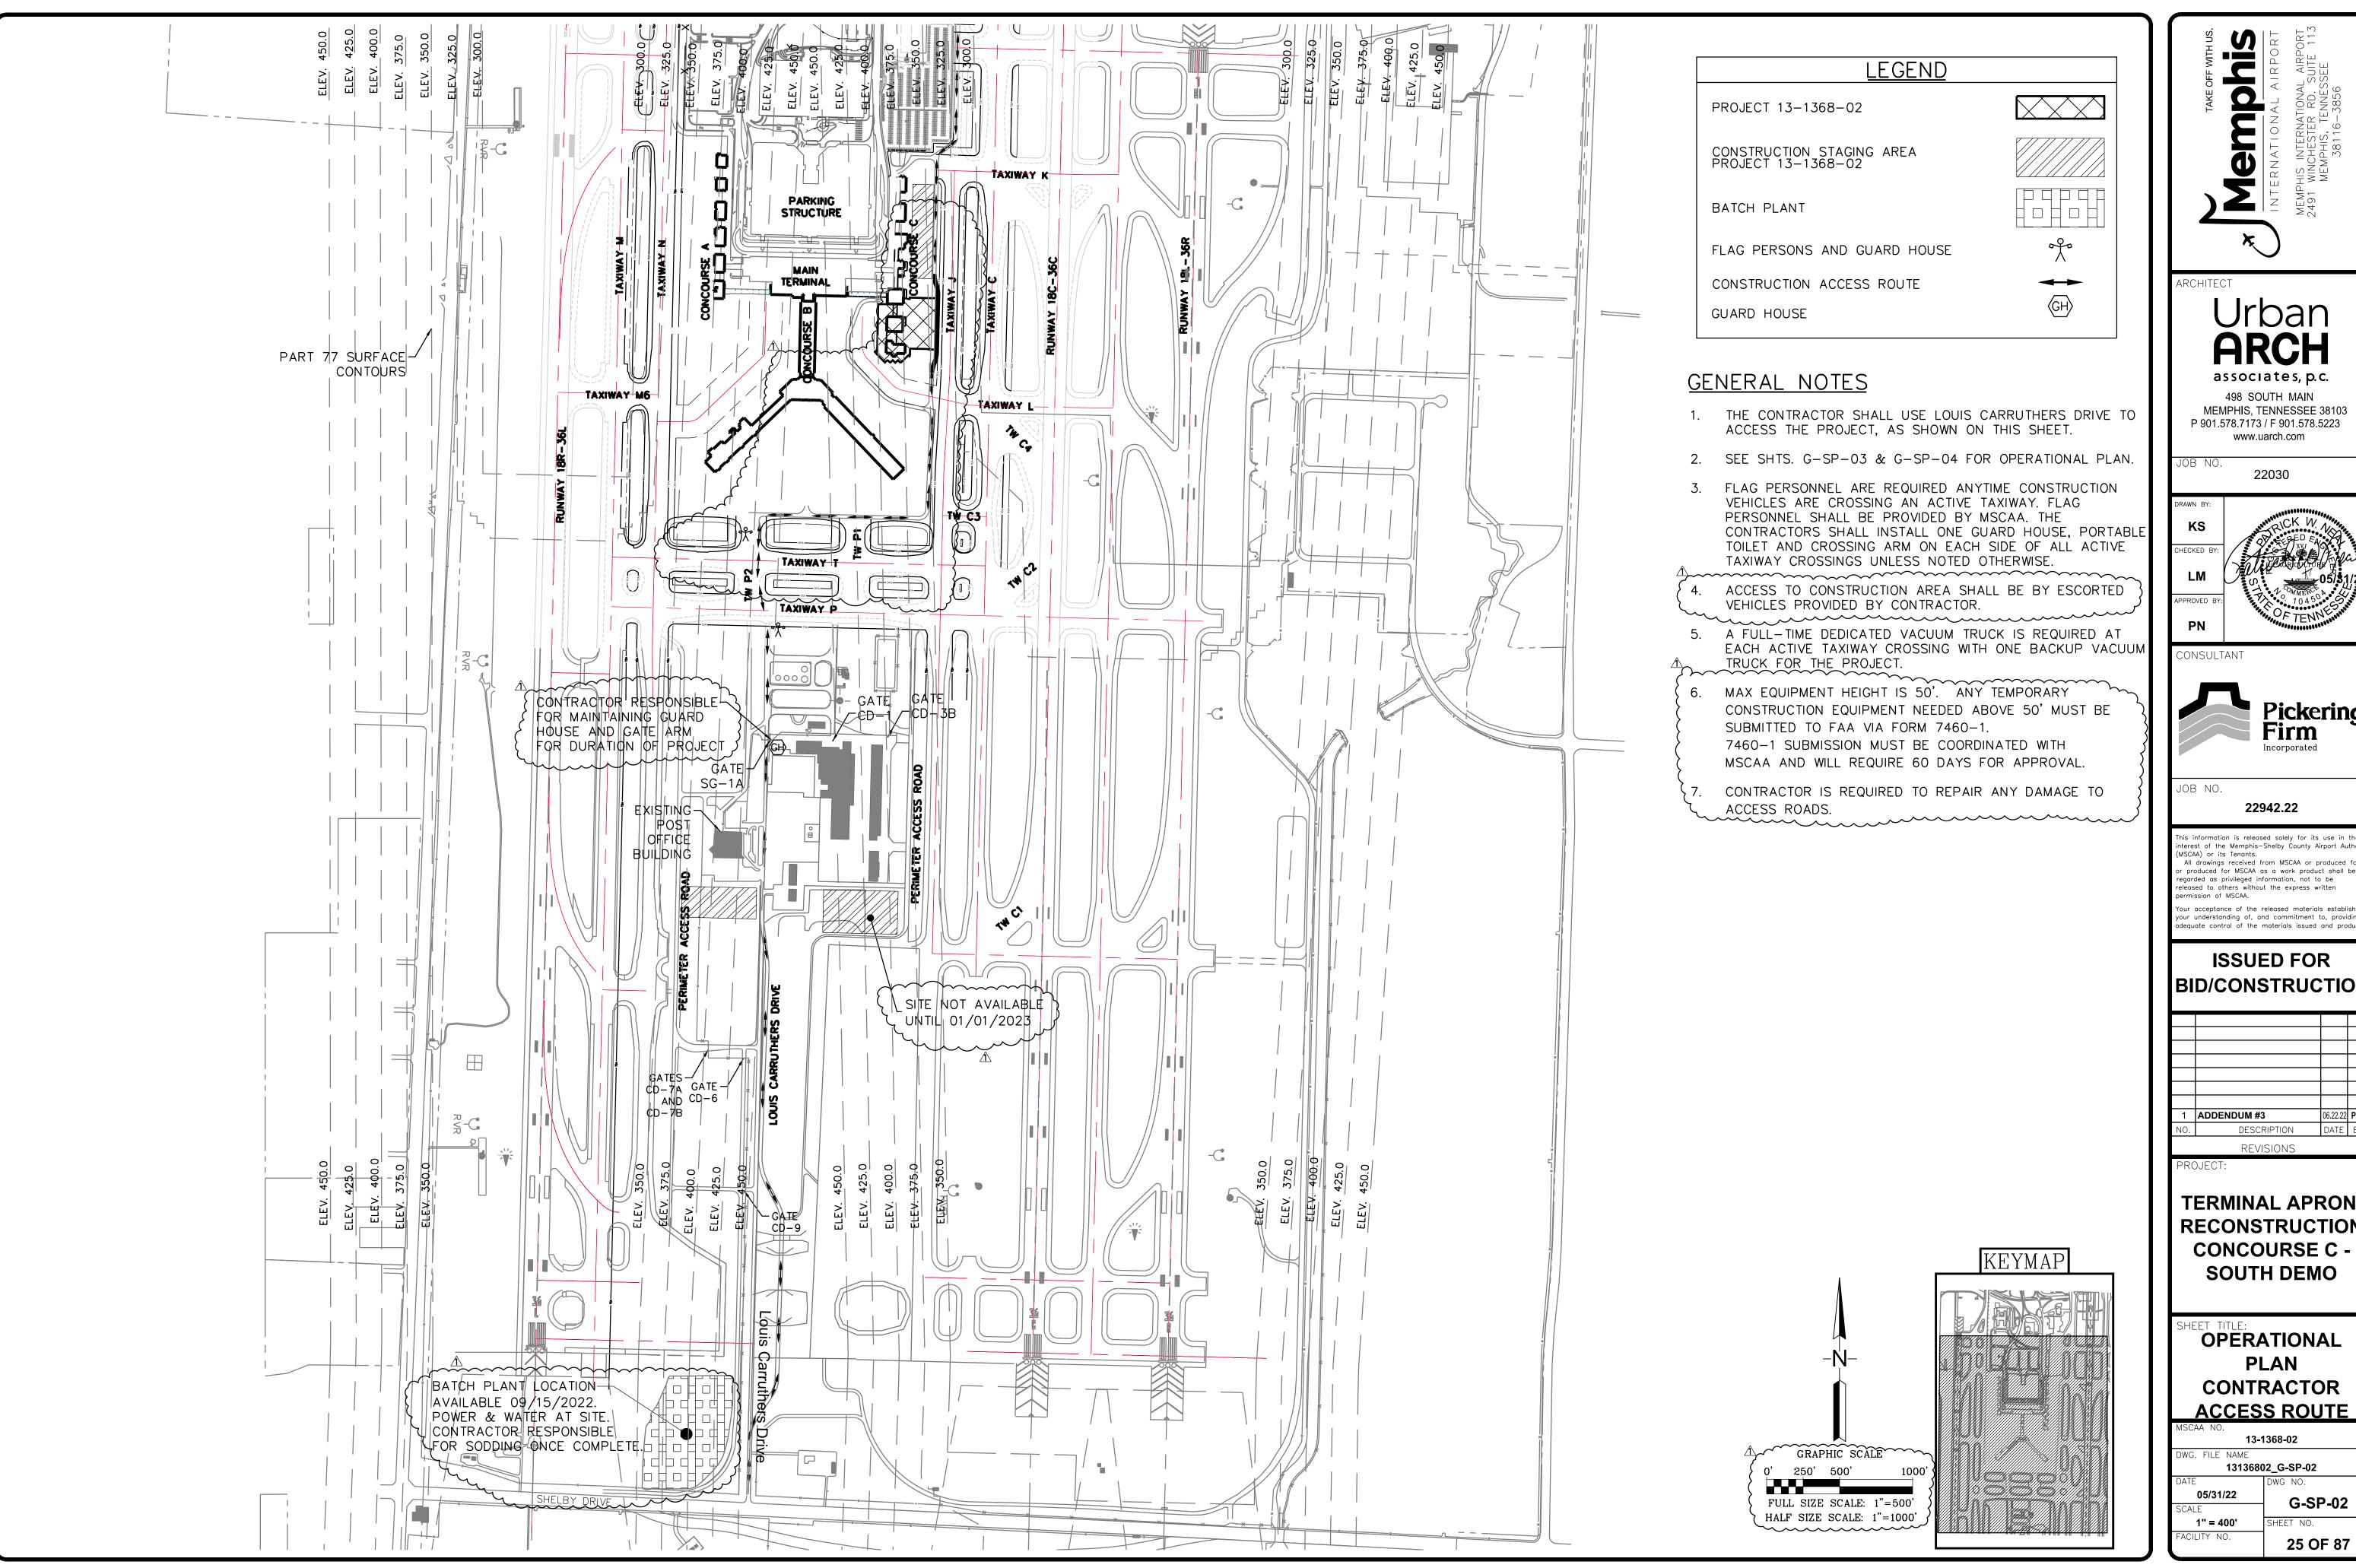

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1 ADDENDUM #3 DESCRIPTION


REVISIONS


**TERMINAL APRON** RECONSTRUCTION CONCOURSE C -**SOUTH DEMO** 

**OPERATIONAL PLAN** CONTRACTOR

> 13-1368-02 13136802\_G-SP-02

05/31/22 G-SP-02 1" = 400' ACILITY NO. 25 OF 87

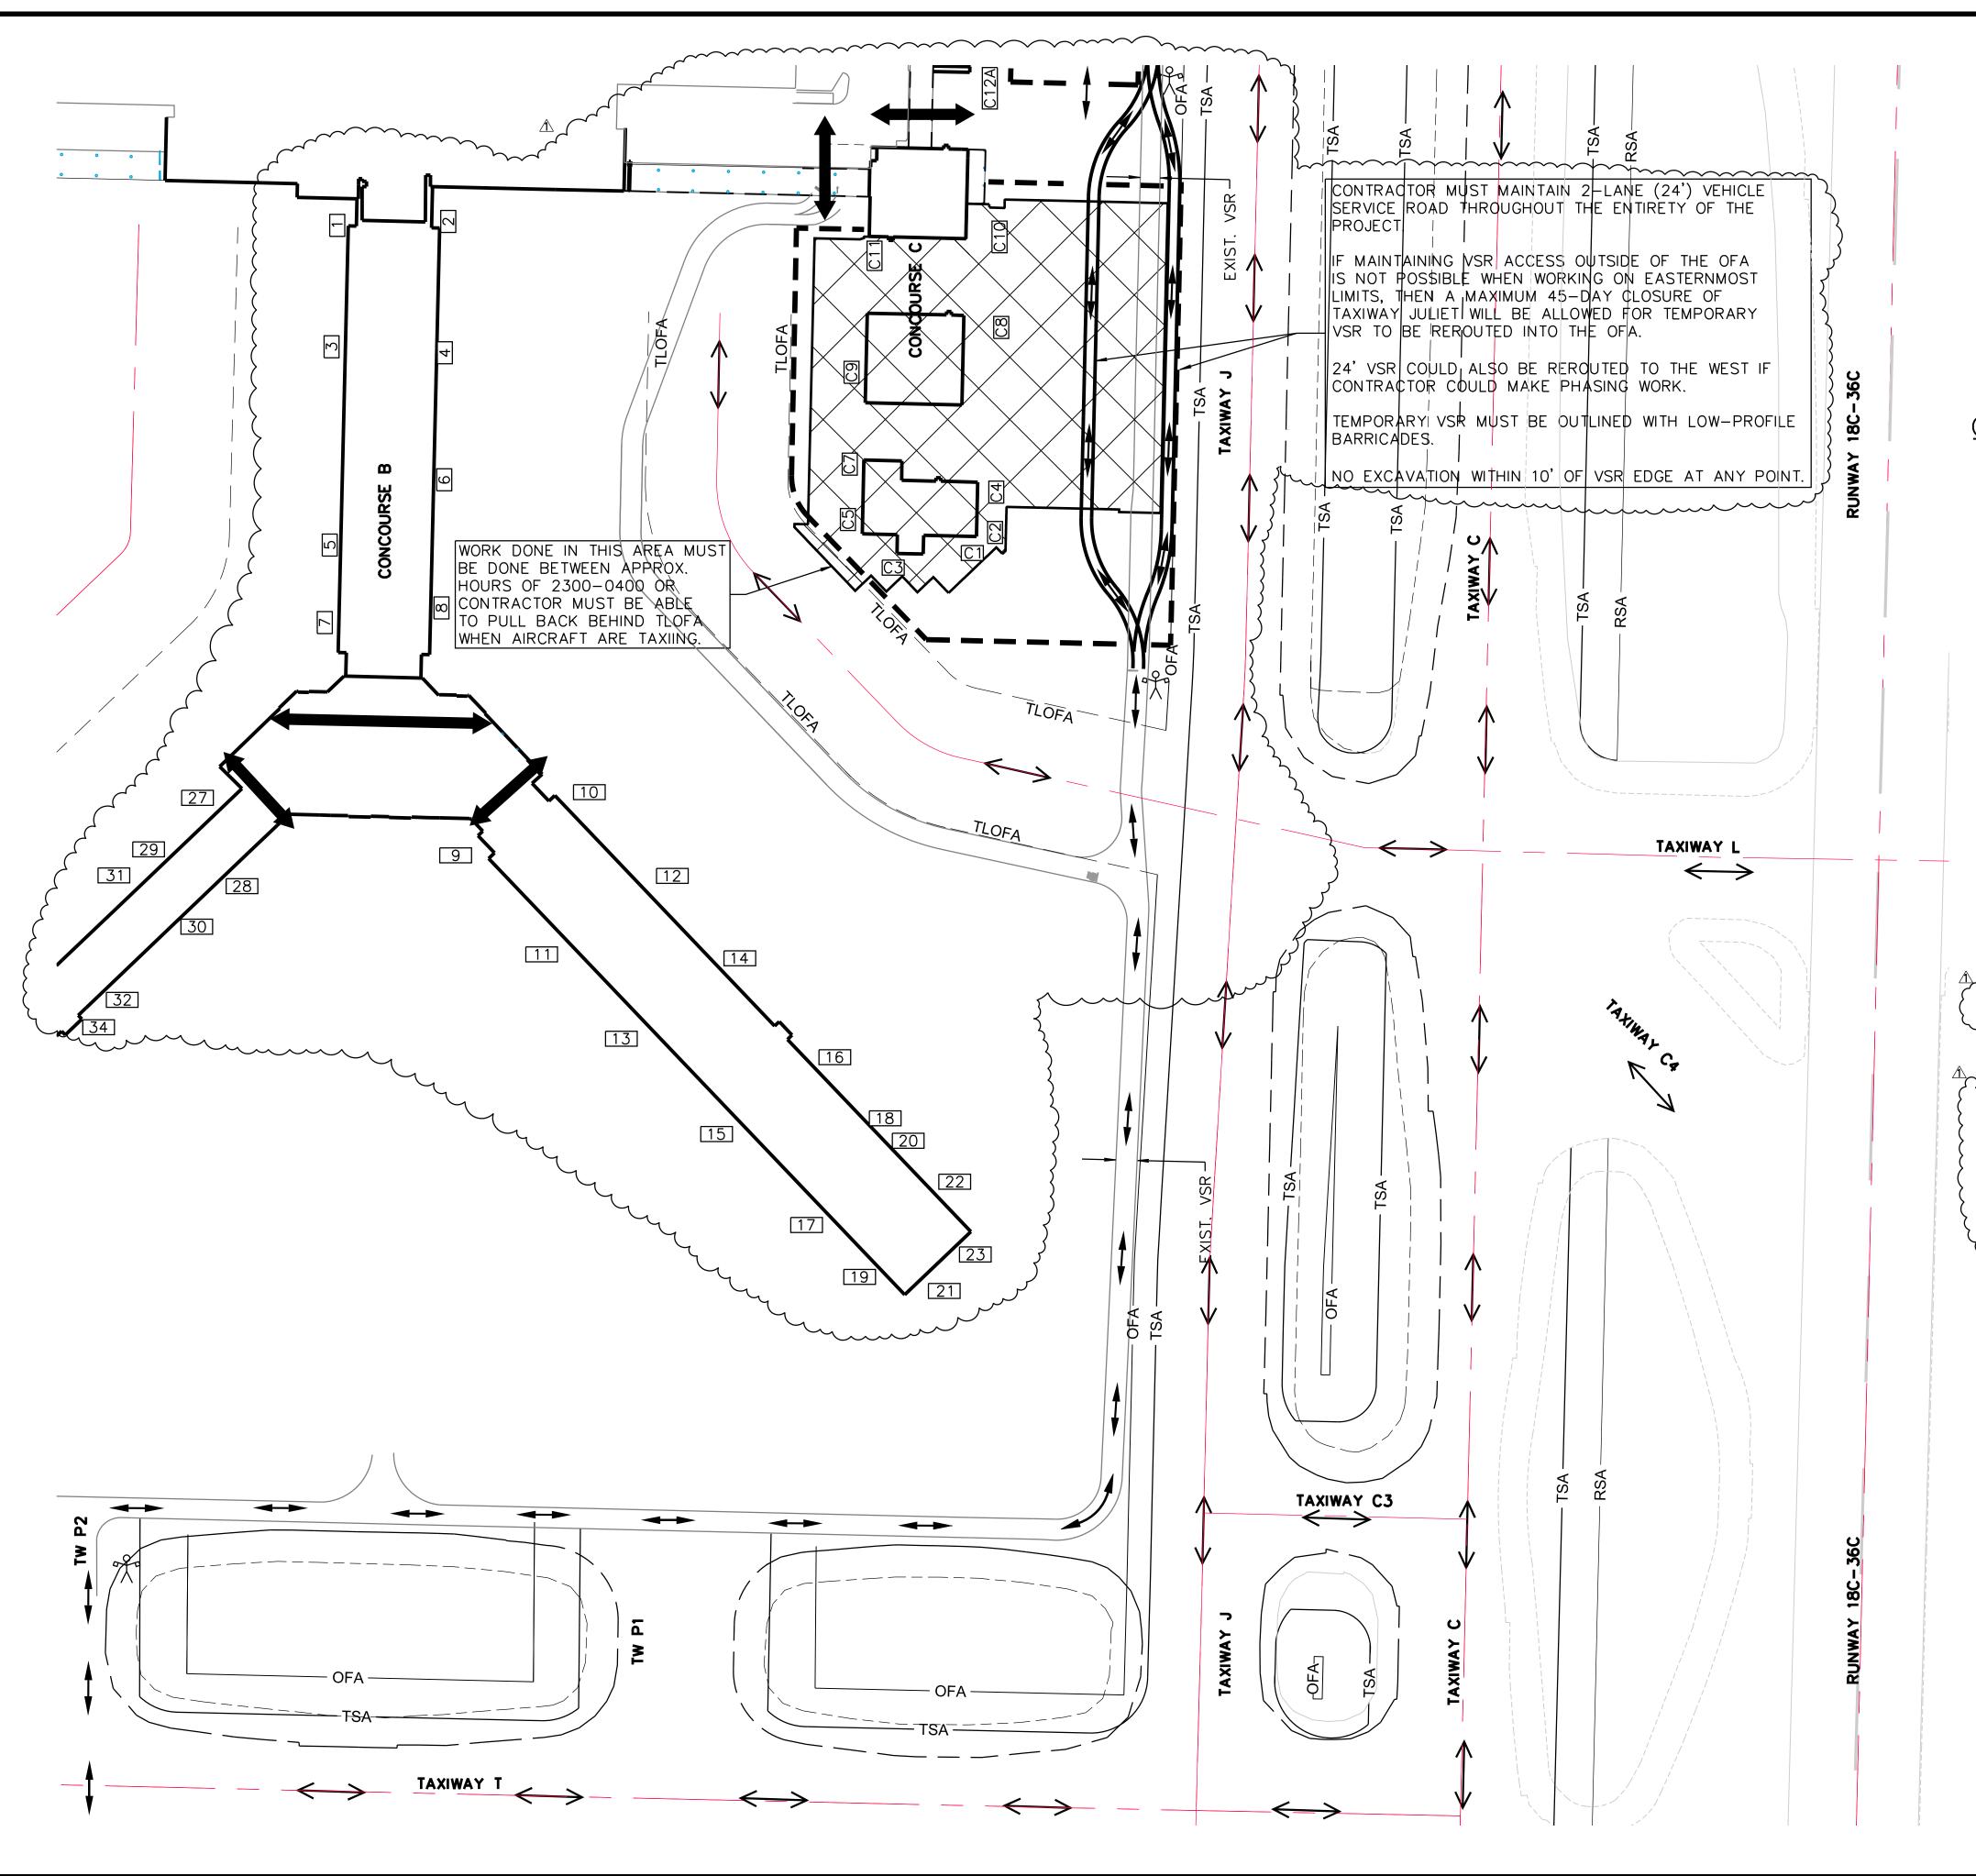

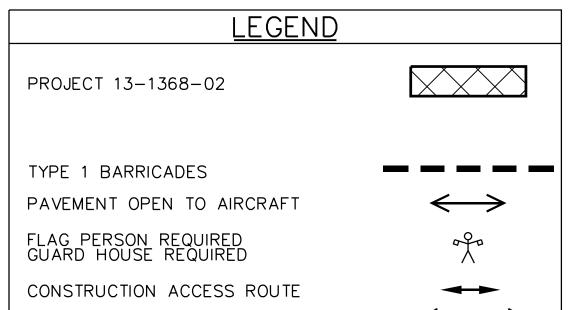


## OPERATIONAL PLAN NOTES

EXISTING GSE ROUTES - OPEN

- SEE SHEET G-SP-02 FOR HAUL ROUTE TO CONTRACTOR STAGING AREA.
- SEE SHEET G-SP-05 FOR OPERATIONAL DETAILS AND NOTES.
- 3. ALL TAXIWAY OR TAXILANE CLOSURES NEED TO BE APPROVED BY THE PROGRAM MANAGER AND AIRPORT OPERATIONS IN ADVANCE.
- CONTRACTOR SHALL PROVIDE ACCESS TO ALL CONCOURSE APRONS FOR EMERGENCY EQUIPMENT AND GROUND SERVICE EQUIPMENT DURING CONSTRUCTION (24' MINIMUM WIDTH).
- TYPE I BARRICADES MUST BE PLACED ALONG THE EDGE OF AN ACTIVE TAXIWAY WHEN THE DROP OFF EXCEEDS 3" AND THE TAXIWAY IS OPEN TO AIR OPERATIONS.
- FLAG PERSONNEL ARE REQUIRED ANYTIME CONSTRUCTION VEHICLES ARE CROSSING AN ACTIVE TAXIWAY, FLAG PERSONNEL SHALL BE PROVIDED BY MSCAA. THE CONTRACTOR SHALL INSTALL ONE GUARD HOUSE, PORTABLE TOILET AND CROSSING ARM ON EACH SIDE OF ALL ACTIVE TAXIWAY CROSSINGS UNLESS NOTED OTHERWISE.
- 7. A FULL-TIME DEDICATED VACUUM TRUCK IS REQUIRED AT EACH ACTIVE TAXIWAY CROSSING WITH ONE BACKUP VACUUM TRUCK FOR THE PROJECT.
- ACCESS TO CONSTRUCTION AREA SHALL BE BY ESCORTED VEHICLES PROVIDED BY CONTRACTOR.
- TAXIWAY LIGHTS ON TAXIWAYS OPEN TO AIRCRAFT OPERATIONS MUST REMAIN ENERGIZED AT ALL TIMES.
- 10. MAX EQUIPMENT HEIGHT IS 50'. ANY TEMPORARY CONSTRUCTION EQUIPMENT NEEDED ABOVE 50' MUST BE SUBMITTED TO FAA VIA FORM 7460-1. 7460-1 SUBMISSION MUST BE COORDINATED WITH MSCAA AND WILL REQUIRE 60 DAYS FOR APPROVAL.

11. CONTRACTOR IS REQUIRED TO REPAIR ANY DAMAGE TO ACCESS ROADS.

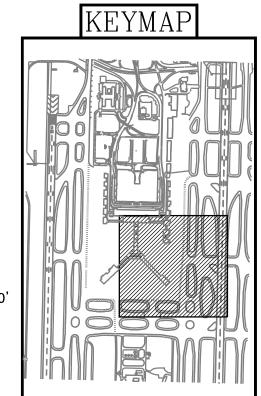



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DESCRIPTION

TERMINAL APRON RECONSTRUCTION **CONCOURSE C -SOUTH DEMO** 

REVISIONS


SHEET TITLE:

**OPERATIONAL PLAN** SHEET 1 OF 2

13-1368-02 13136802 G-SP-03

05/31/22 G-SP-03 1" = 100' 26 OF 87

GRAPHIC SCALE 0' 50' 100' FULL SIZE SCALE: 1"=100' HALF SIZE SCALE: 1"=200'

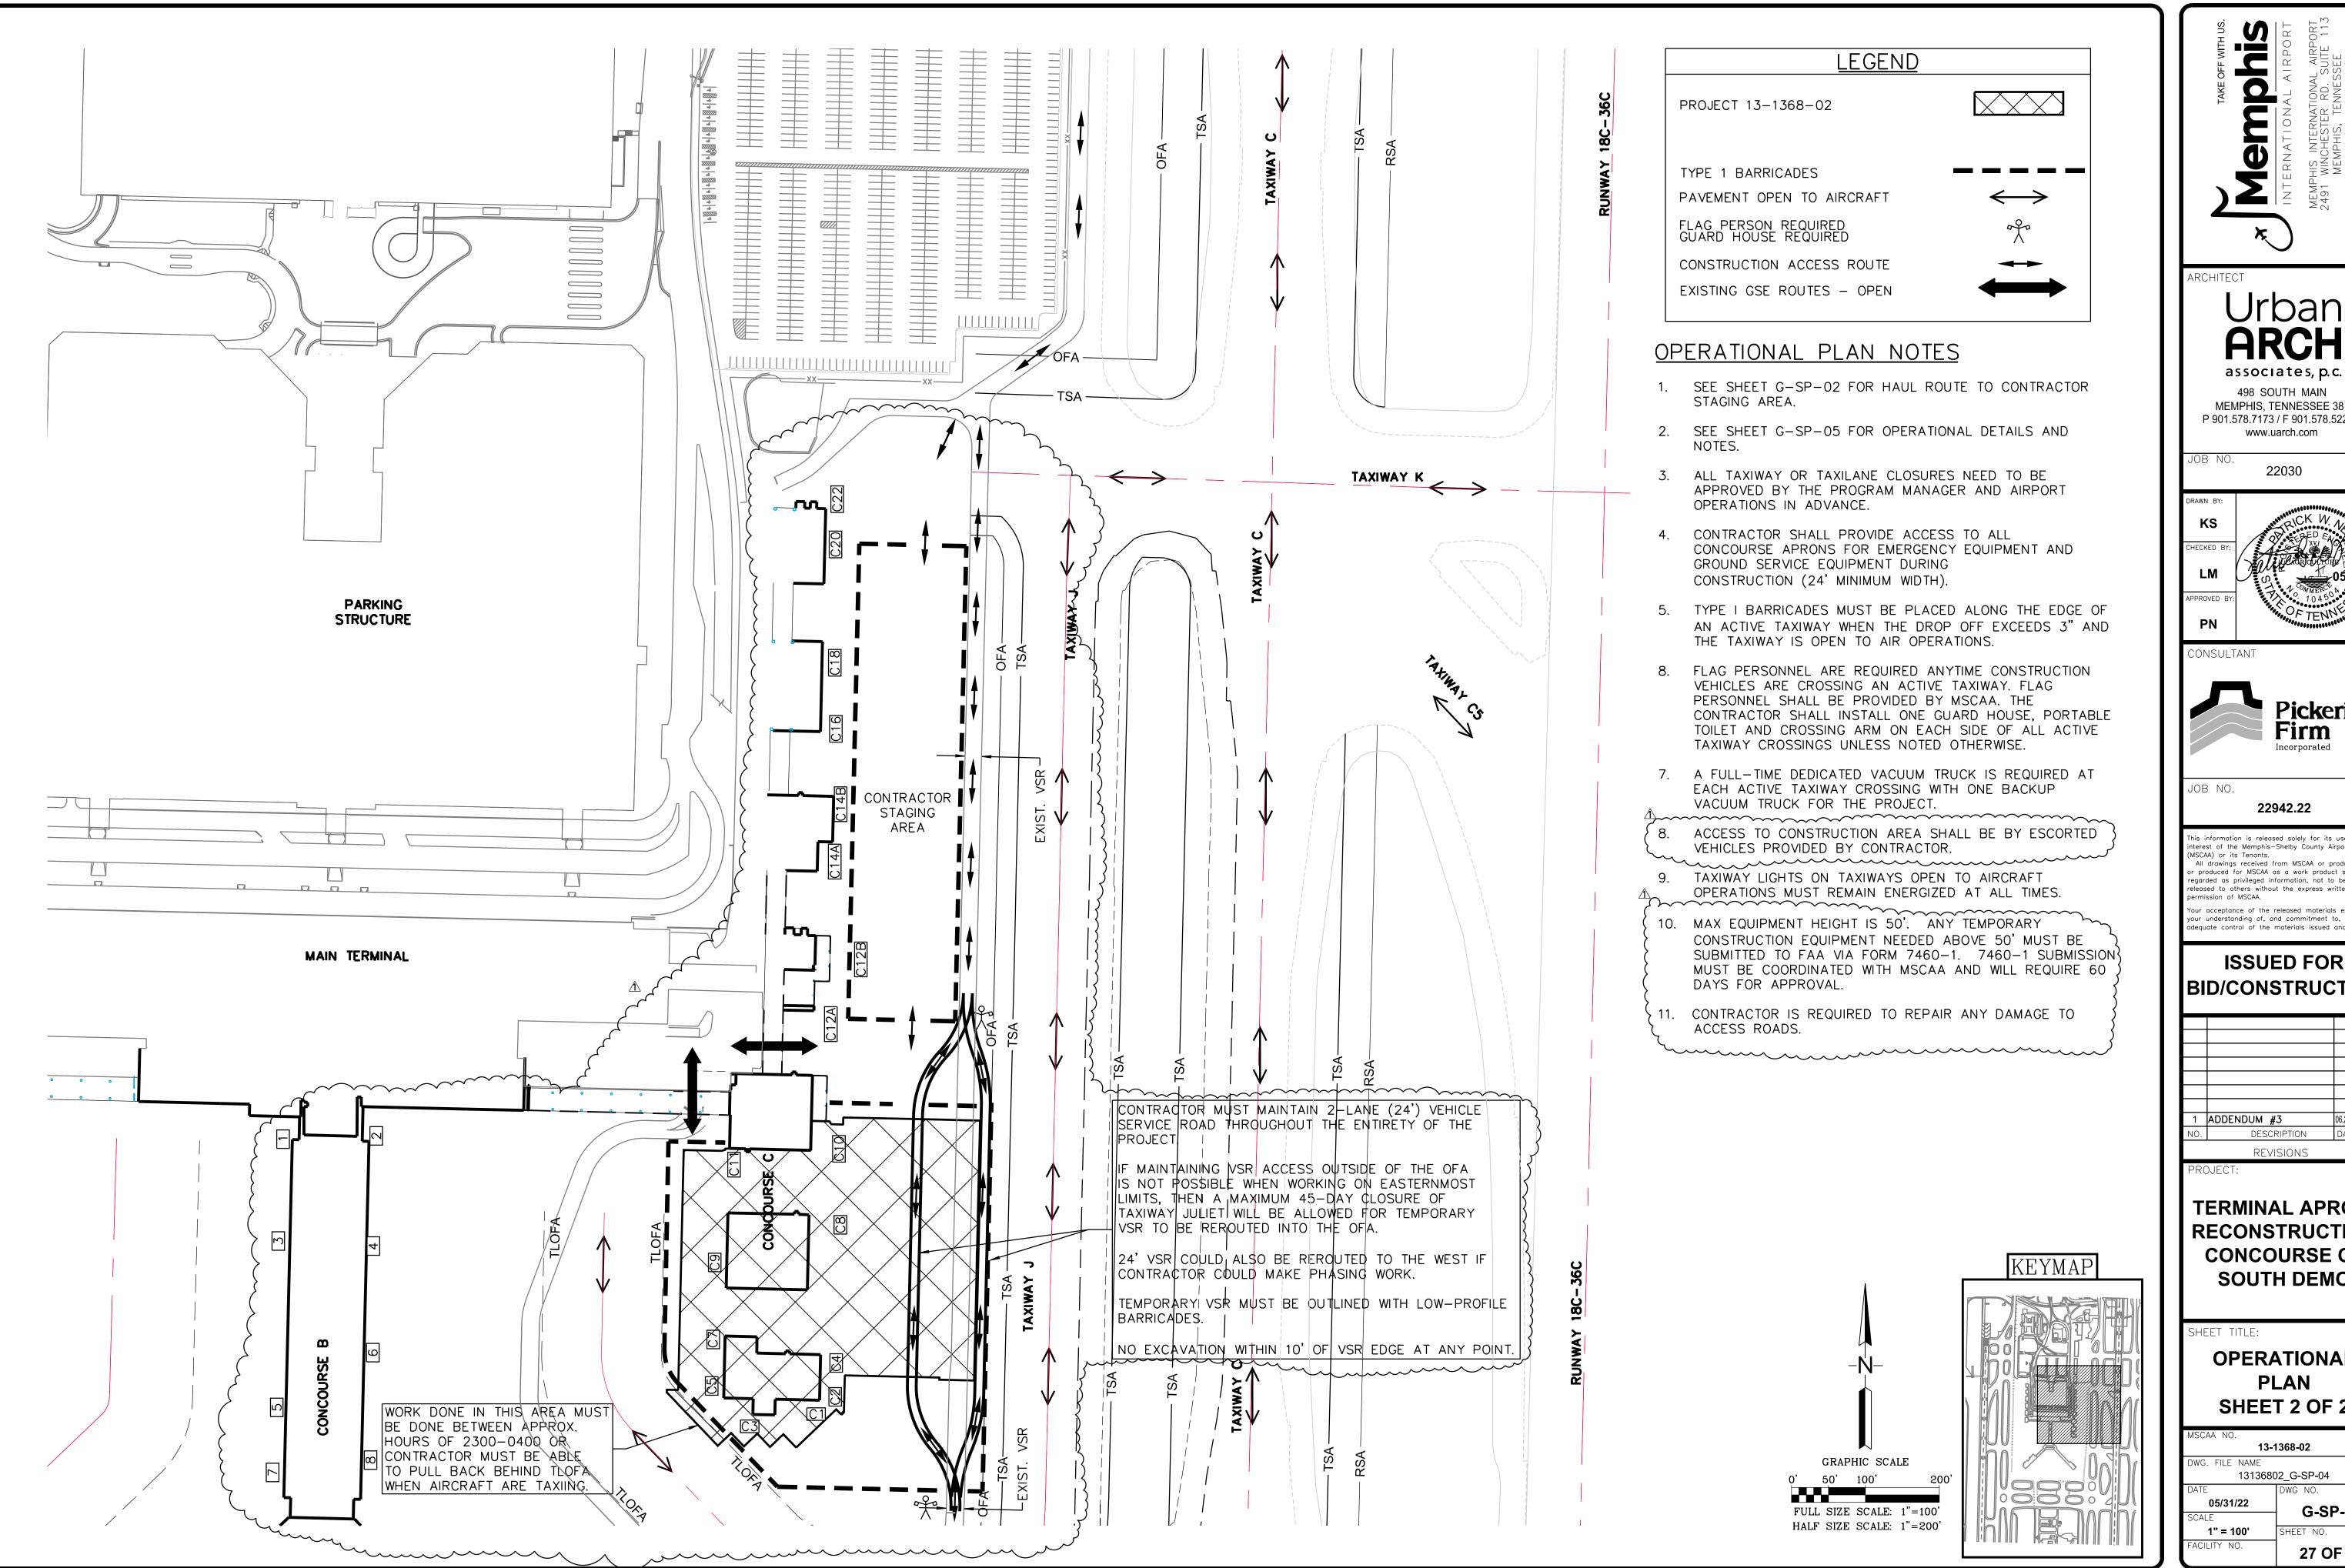

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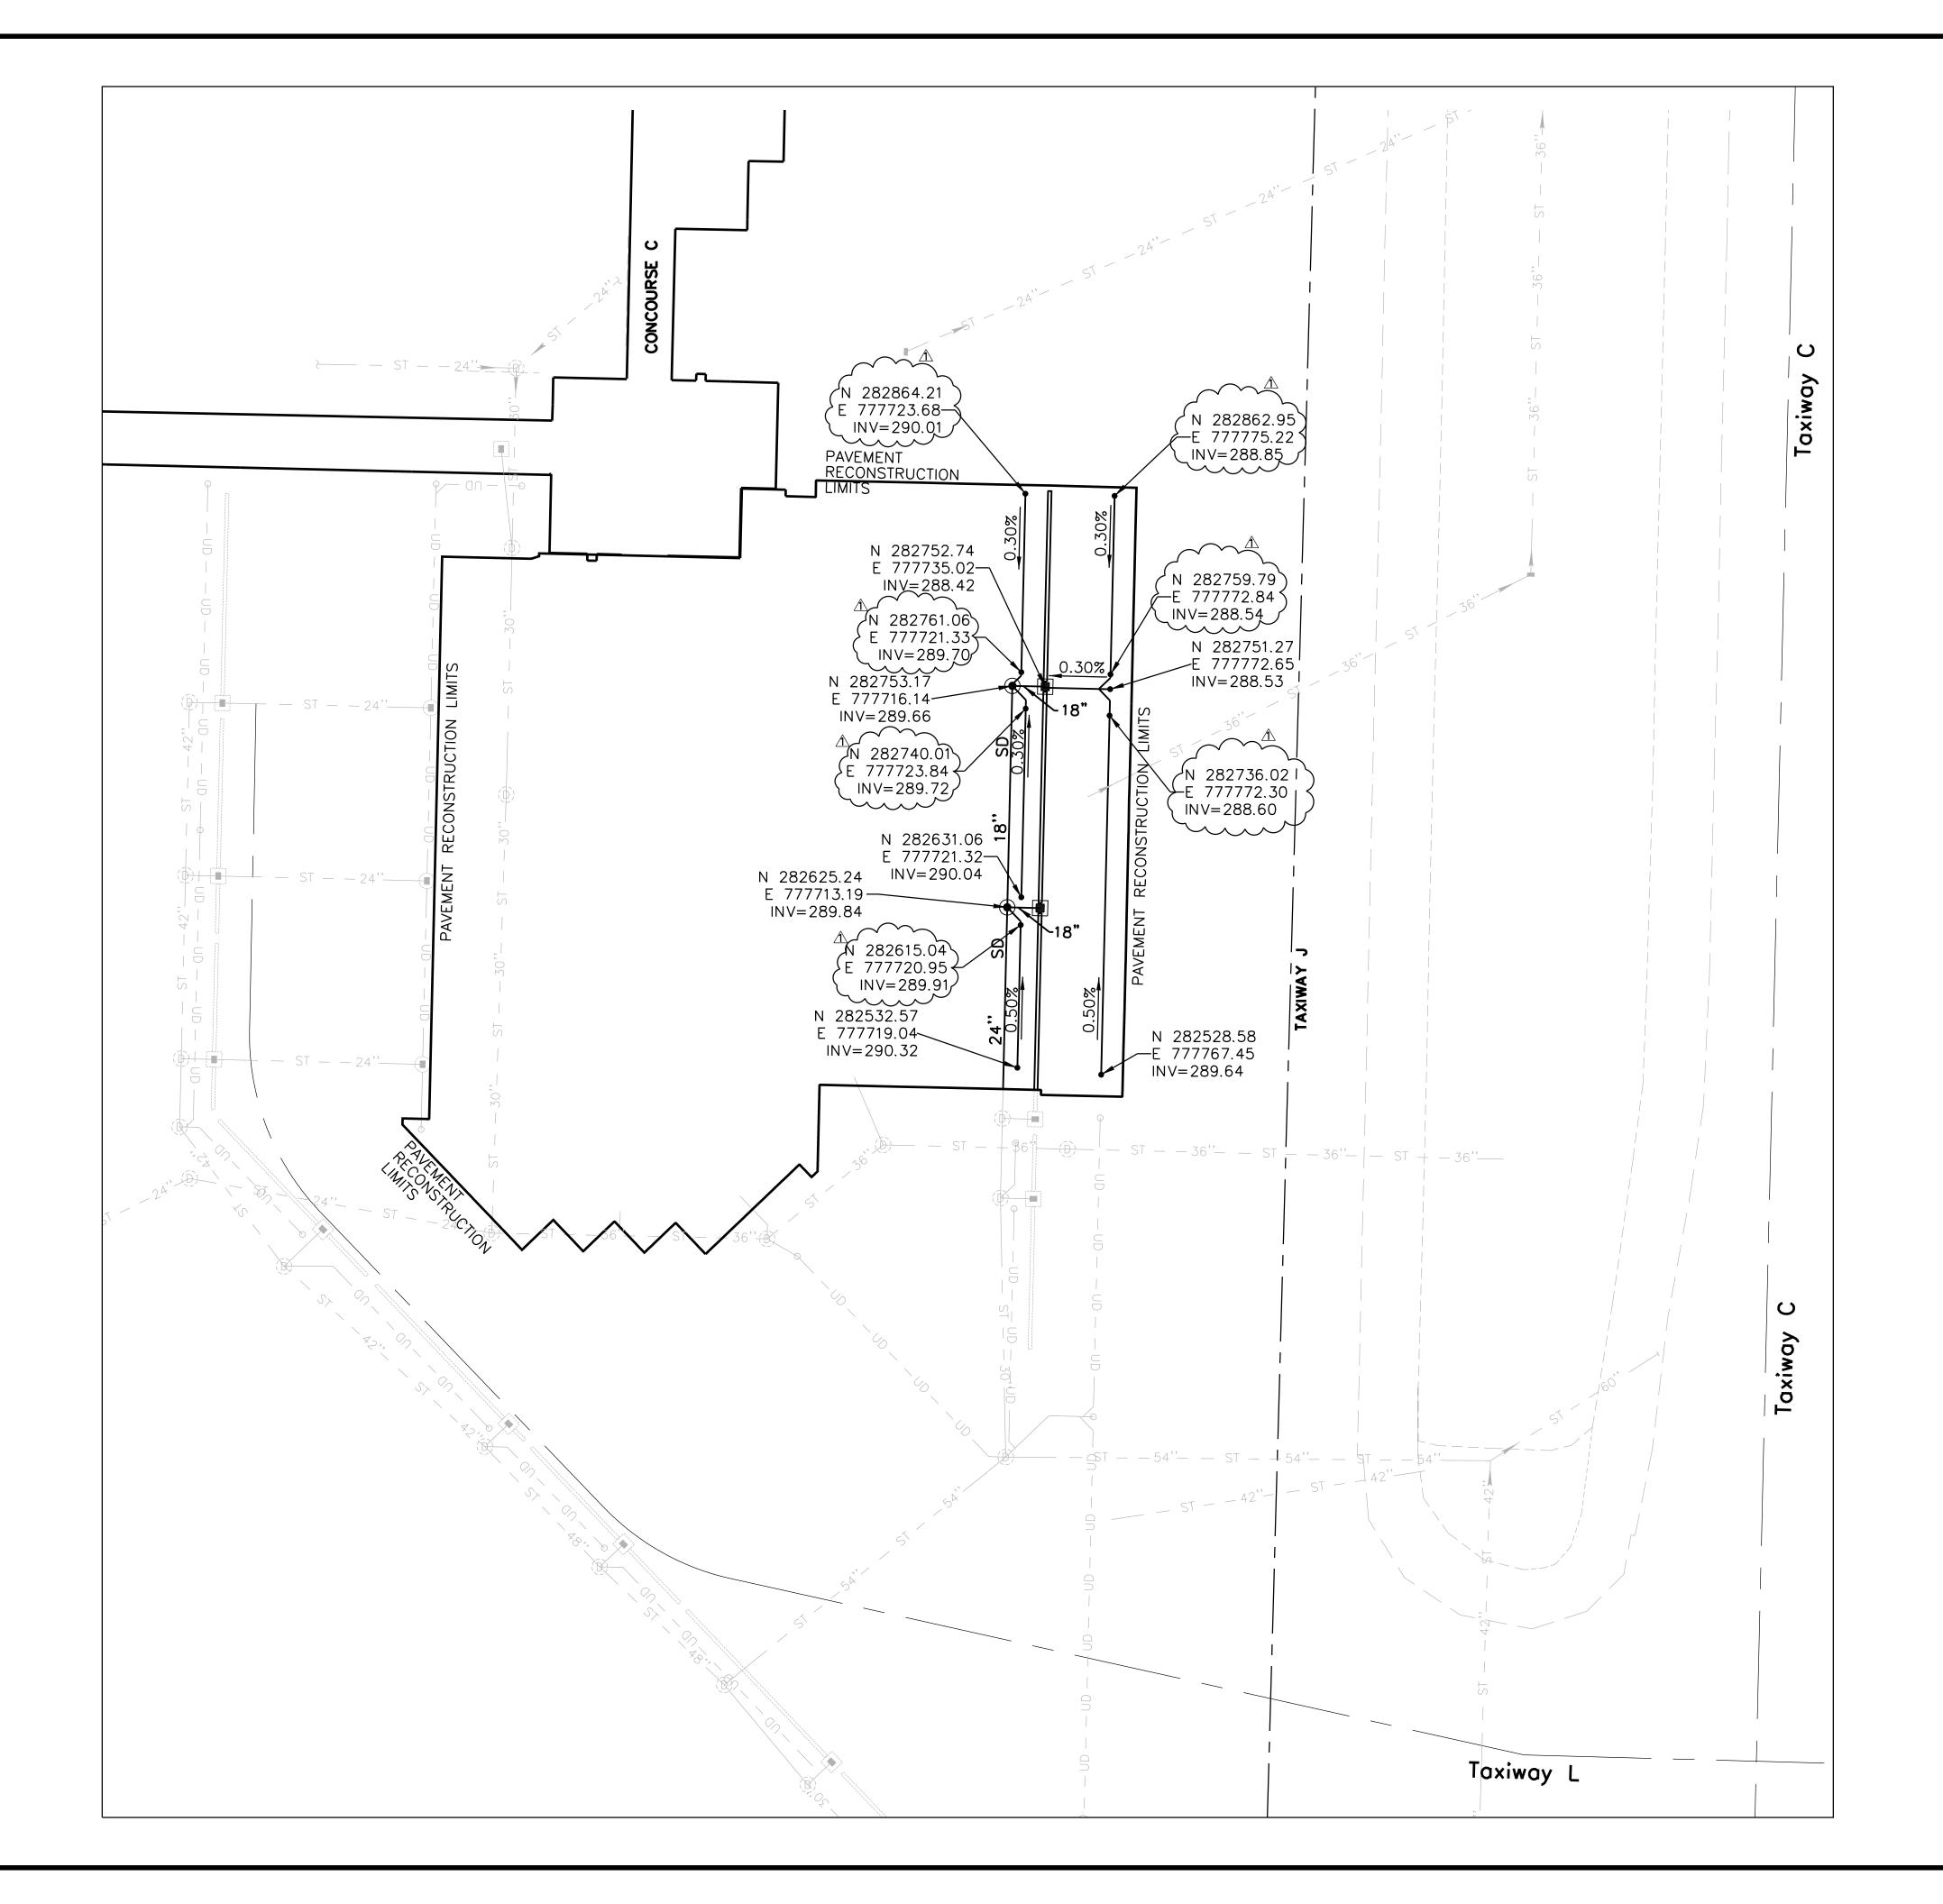
DESCRIPTION

**TERMINAL APRON** RECONSTRUCTION **CONCOURSE C -SOUTH DEMO** 

> **OPERATIONAL PLAN** SHEET 2 OF 2

13-1368-02 13136802 G-SP-04

G-SP-04 27 OF 87





4" DIAMETER PERFORATED UNDERDRAIN PIPE

PROPOSED UNDERDRAIN CLEAN OUT

## UNDERDRAIN NOTES

- 1. MAINTAIN GRADE CONTROL TO ENSURE POSITIVE GRAVITY DRAINAGE AT ALL LOCATIONS.
- 2. PUMP OR BALE OUT ACCUMULATED WATER IN UNDERDRAIN TRENCHES. NO STANDING WATER WILL BE ALLOWED IN TRENCHES; DURING CONSTRUCTION, ENSURE POSITIVE DRAINAGE OUTFALLS ARE AVAILABLE FROM ALL TRENCHES.
- 3. VERIFY ELEVATIONS OF ALL EXISTING AND PROPOSED UTILITY CROSSINGS PRIOR TO CONSTRUCTION. RESOLVE CONFLICTS PRIOR TO CONSTRUCTION OF EACH OUTLET SYSTEM.
- 4. NO TACK COAT, PRIME COAT OR BITUMINOUS CURE COAT FROM PAVING OPERATIONS WILL BE ALLOWED ON TOP OF THE TRENCH, PROTECT UNDERDRAIN TRENCH DURING PAVING CONSTRUCTION.
- 5. ALL UNDERDRAIN WORK SHALL BE COMPLETED PRIOR TO P-304 CEMENT TREATED AGGREGATE BASE CONSTRUCTION.
- 6. PRIOR TO CONSTRUCTION, STAKE OUT THE UNDERDRAIN SYSTEM IN THE FIELD FOR PROGRAM MANAGER APPROVAL.
- 7. ALL OUTFALL UNDERDRAIN PIPES SHALL BE CONSTRUCTED PRIOR TO THE ADJACENT UNDERDRAIN PIPE NETWORK BENEATH PAVEMENTS.
- 8. WHERE CLEARANCE FROM TOP OF UNDERDRAIN PIPE TO FINISHED GRADE IS LESS THAN 2 FEET, SURROUND WITH P-610 STRUCTURAL CONCRETE TO THE REQUIRED BEDDING DEPTH AND WIDTH AND TO 6 INCHES OVER TOP OF PIPE. COST OF ENCASEMENT SHALL BE INCIDENTAL TO THE COST OF THE OUTFALL PIPE.
- 9. DURING AND AFTER UNDERDRAIN PIPE AND BACKFILL INSTALLATION, PROTECT THE UNDERDRAIN TRENCH SUCH THAT NO FINES OR EARTH MATERIAL ENTER SAME PRIOR TO OVERLYING AGGREGATE BASE COURSE CONSTRUCTION.
- 10. FOR UNDERDRAIN TIES TO DRAINAGE STRUCTURES SEE DETAIL 3, ON SHEET C-UD-02.

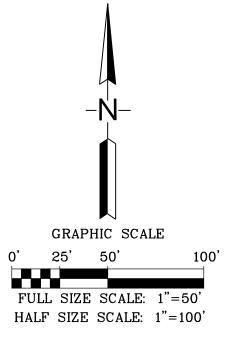

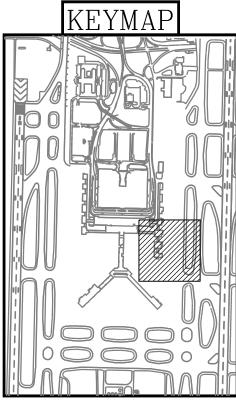

**LEGEND** 

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DESCRIPTION

REVISIONS

**TERMINAL APRON** RECONSTRUCTION **CONCOURSE C-SOUTH DEMO** 

SHEET TITLE:

**PAVEMENT** UNDERDRAIN PLAN

13-1368-02 13136802\_C-UD-01

05/31/22 C-UD-01 58 OF 87