CONSTRUCTION PLANS

FOR THE

CHARLES BAKER AIRPORT - PAVEMENT RECONSTRUCTION


AT

CHARLES BAKER AIRPORT
MEMPHIS, SHELBY COUNTY, TENNESSEE


MSCAA PROJECT NUMBER: 18-1420-01


MEMPHIS-SHELBY COUNTY AIRPORT AUTHORITY (MSCAA)

TERRY BLUE, PRESIDENT AND CEO MARSHALL STEVENS, VICE PRESIDENT OF OPERATIONS/COO BRIAN TENKHOFF, DIRECTOR OF DEVELOPMENT

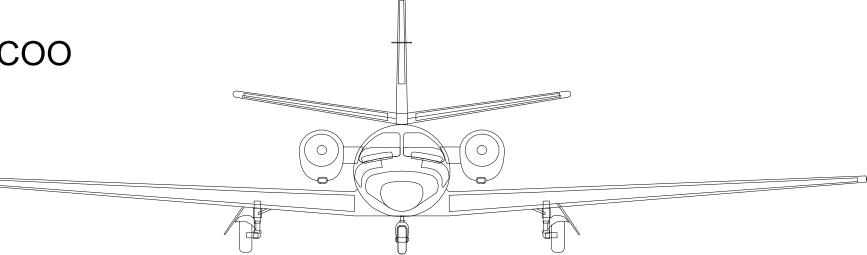

PROJECT SITE

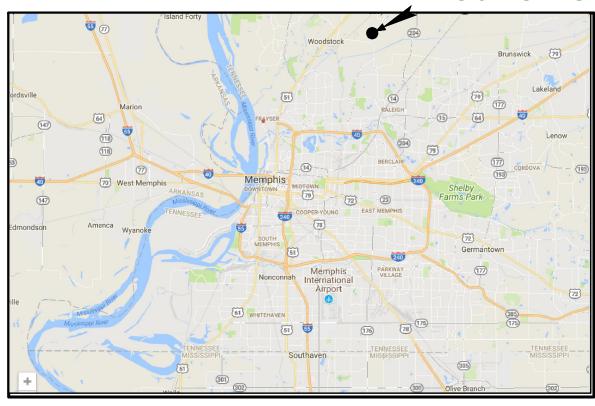

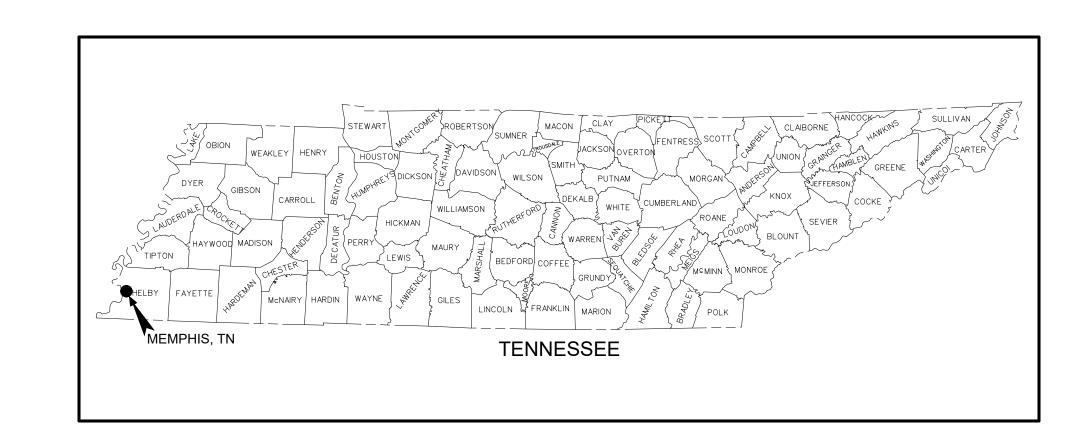


VICINITY MAP

NOT TO SCALE

LOCATION MAP

NOT TO SCALE



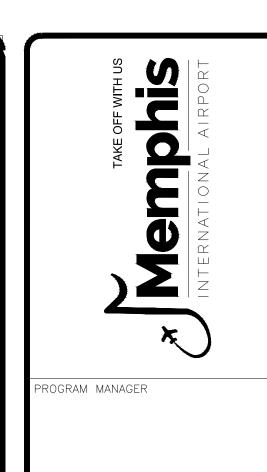

BARGE DESIGN SOLUTIONS, INC.
65 GERMANTOWN CT, SUITE 100
MEMPHIS, TN 38018

33276-02

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REVISIONS
DATE DESCRIPTION

ISSUED FOR BID

18-1420-01

CHARLES BAKER
PAVEMENT
RECONSTRUCTION

SHEET TITLE

COVER SHEET

DWG. FILE NAME

3327602-01C-CS-01.DWG

03/11/2024 SHEET NO.
CALE SHEET NO.
SHEET NO.
SHEET NO.

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PROGRAM MANAGER

BARGE DESIGN SOLUTIONS BARGE DESIGN SOLUTIONS, INC.

65 GERMANTOWN CT, SUITE 100 MEMPHIS, TN 38018

33276-02

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18-1420-01

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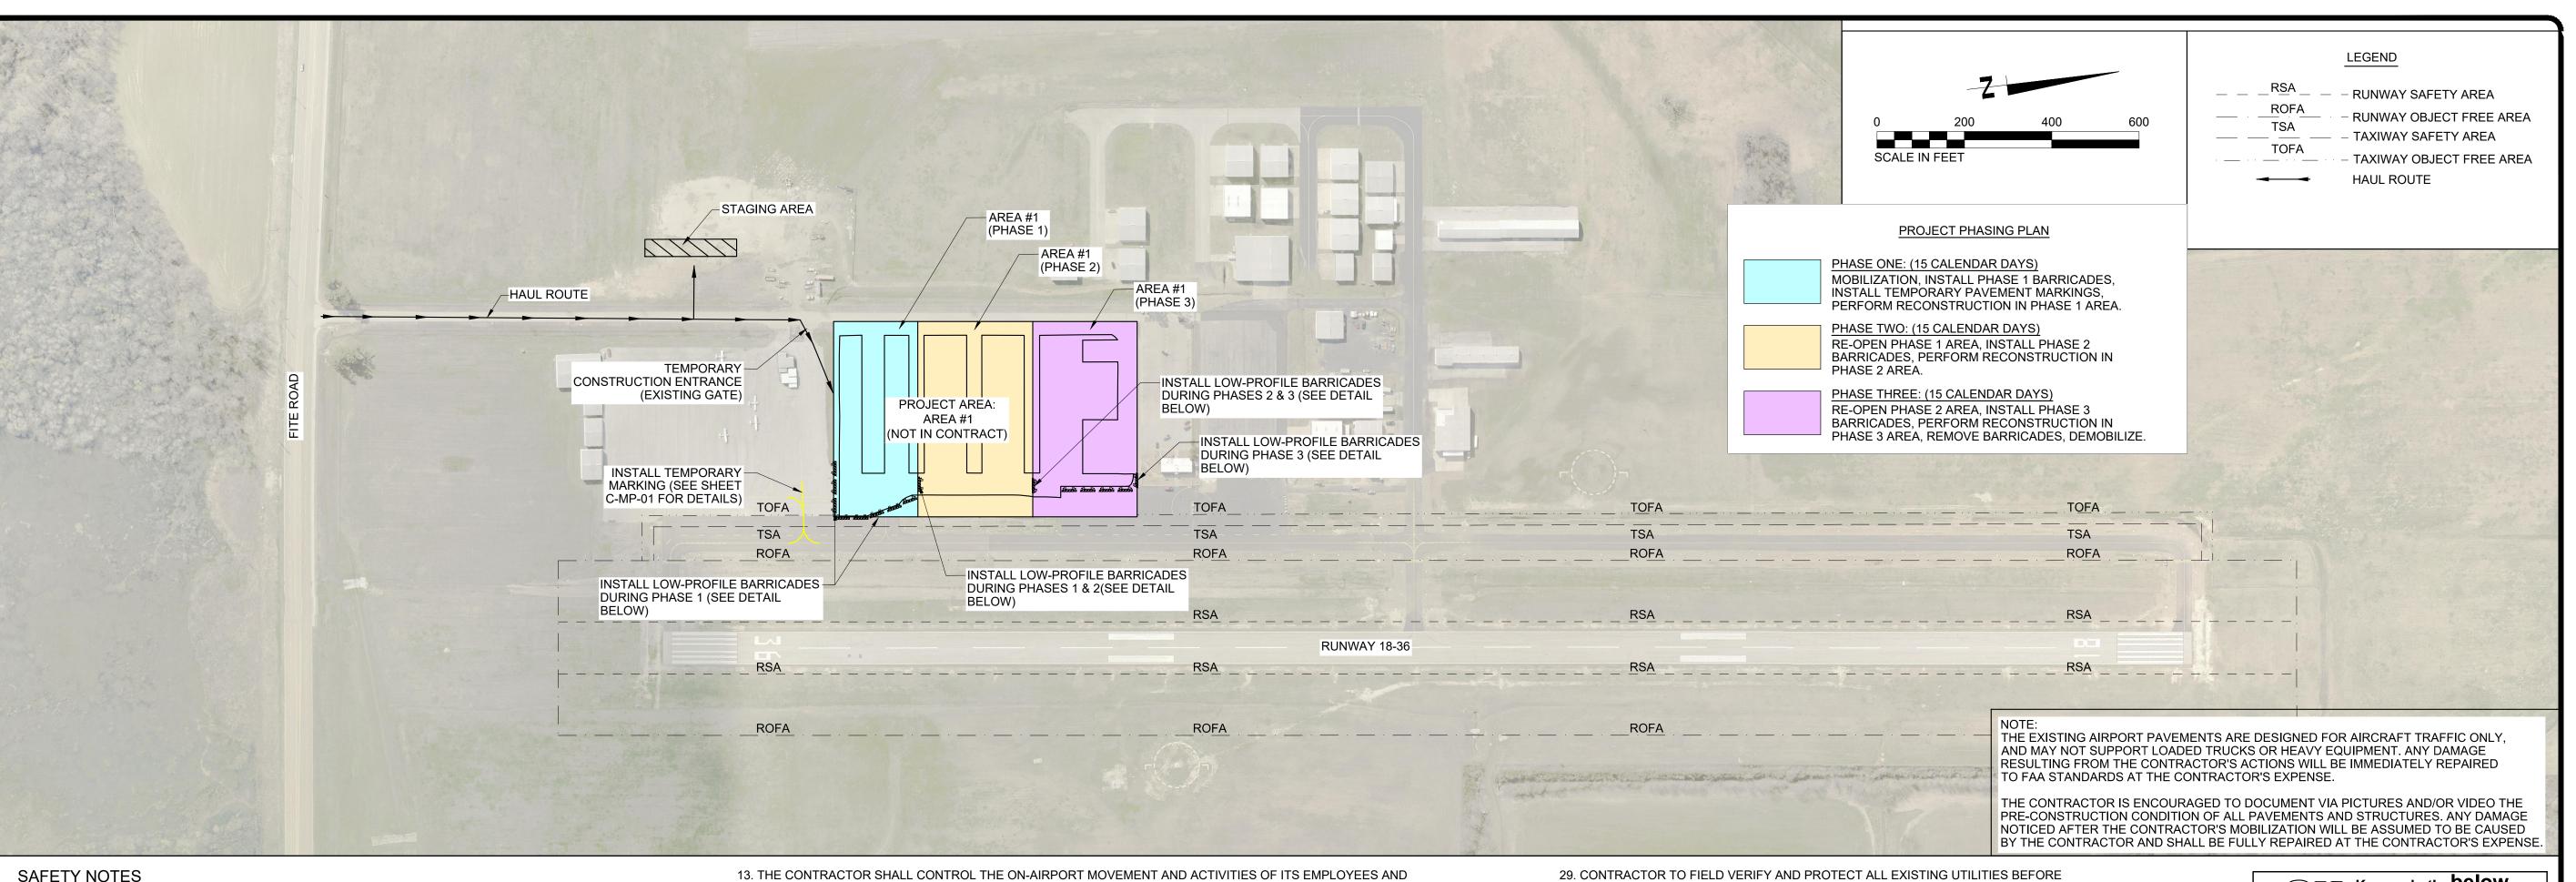
INDEX OF DRAWINGS

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3327602-02C-CS-02.DWG

03/11/2024 C-CS-02

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- 2. AIRPORT OPERATION SAFETY AREAS ARE DEFINED AS FOLLOWS:
- 2.1. RUNWAY 18-36 RSA 60 FEET FROM THE CENTERLINE OF PAVEMENT AND 240 FEET
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- 2.4. TAXIWAY OBJECT FREE AREA 62' FROM CENTERLINE OF PAVEMENT. (TOFA) 2.4. TAXILANE OBJECT FREE AREA - 55' FROM CENTERLINE OF PAVEMENT. (TLOFA)
- 3. NO SEPARATE MEASUREMENT OR PAYMENT WILL BE MADE FOR RADIOS, CONSTRUCTION OF AND MAINTENANCE OF HAUL ROUTES AND CONSTRUCTION ENTRANCE, ETC. AS INCLUDED IN THESE NOTES. ALL COSTS ASSOCIATED WITH THESE ITEMS MUST BE INCLUDED IN THE CONTRACT BID PRICES WHICH WOULD MOST LIKELY INCLUDE THEM.
- 4. THE CONTRACTOR AND PERSONNEL SHALL NOT, AT ANY TIME, BE ON THE RUNWAY, TAXIWAYS, OR MAIN APRON UNLESS THE AIRPORT MANAGER GIVES PRIOR APPROVAL.
- 5. THE CONTRACTOR SHALL TAKE EXTREME CAUTION AROUND ALL EXISTING AIRPORT EQUIPMENT.
- 6. THE CONSTRUCTION ENTRANCE, STAGING AREA, EMPLOYEE PARKING, STOCKPILE AREA, WASTE AREA, AND BORROW AREA SHALL BE COORDINATED WITH THE AIRPORT MANAGER.
- 7. THE CONTRACTOR SHALL HAVE AN INDIVIDUAL ON 24-HOUR CALL FOR EMERGENCY MAINTENANCE OF AIRPORT HAZARD LIGHTING. BARRICADES, AND OTHER EMERGENCIES WHICH MAY ARISE AS A RESULT OF WORK.
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- SAFETY ON AIRPORTS DURING CONSTRUCTION" 9.3. ADVISORY CIRCULAR NUMBER 150/5210-5-2 (LATEST EDITION), "PAINTING, MARKING, AND LIGHTING OF VEHICLES USED ON AN AIRPORT"
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- 11. AIRCRAFT OPERATIONS SHALL, AT ALL TIMES, HAVE PRIORITY OVER ALL VEHICLES, EQUIPMENT, AND PERSONNEL. THE CONTRACTOR SHALL EMPLOY STRICT MEASURES TO PREVENT ANY CONFLICT BETWEEN CONTRACTOR PERSONNEL AND AIRCRAFT ON ANY ACTIVE AIRFIELD PAVEMENT. THE CONTRACTOR SHALL REMAIN CLEAR OF ACTIVE RUNWAYS AND TAXIWAYS.
- 12. ALL CONTRACTOR VEHICLES, INCLUDING HAULING VEHICLES, THAT ARE AUTHORIZED TO OPERATE ON THE AIRPORT WITHIN THE DESIGNATED LIMITS OF CONSTRUCTION OR HAUL ROUTES AS DEFINED HEREIN, SHALL BE EQUIPPED WITH ROTATING OR FLASHING AMBER LIGHTS. WHEN OPERATING DURING PERIODS OF DARKNESS OR LIMITED VISIBILITY, CONTRACTOR'S VEHICLE SHALL BE EQUIPPED WITH SUCH ROTATING OR FLASHING AMBER LIGHTS, AND HAULING VEHICLES NOT SO EQUIPPED SHALL BE ESCORTED BY A VEHICLE SO EQUIPPED.

- SUBCONTRACTORS.
- 14. OPEN-FLAME WELDING OR TORCH-CUTTING OPERATIONS ARE PROHIBITED UNLESS ADEQUATE FIRE AND SAFETY PRECAUTIONS HAVE BEEN APPROVED BY THE OWNER.
- 15. OPEN TRENCHES. EXCAVATIONS AND STOCKPILED MATERIALS AT THE CONSTRUCTION SITE SHALL BE PROMINENTLY MARKED WITH ORANGE CONSTRUCTION FENCING WITH BARRELS AND WITH FLASHING AMBER LIGHT UNITS (ACCEPTABLE TO THE OWNER) DURING HOURS OF RESTRICTED VISIBILITY OR DARKNESS.
- 16. STOCKPILED MATERIAL SHALL BE CONSTRAINED IN A MANNER TO PREVENT MOVEMENT AS A RESULT OF AIRCRAFT OR WIND.
- 17. ALL VEHICLES BELONGING TO THE FOREMAN AND SUPERINTENDENT SHALL CONTAIN RADIOS CAPABLE OF TRANSMITTING AND RECEIVING THE UNICOM/CTAF FREQUENCY OF 122.80 MHZ. NORMAL RADIO COMMUNICATIONS BETWEEN CONTRACTOR
- 18. ALL CONSTRUCTION TRAFFIC WHICH CROSSES AIRPORT OPERATIONAL SAFETY AREAS MUST BE CONTROLLED BY FLAGMEN. ALL FLAGMEN CONTROLLING CONSTRUCTION TRAFFIC ACROSS AIRPORT OPERATIONAL AREAS SHALL ALSO BE EQUIPPED WITH A RADIO WHICH WILL OPERATE ON THE UNICOM/CTAF FREQUENCY OF 122.80 MHZ.
- 19. CONTRACTOR TO PROVIDE A MINIMUM OF TWO (2) RADIOS CAPABLE OF OPERATING ON 122.80 MHZ ON THE PROJECT SITE FOR CONTRACTOR USE AT ALL TIMES DURING CONSTRUCTION.
- 20. ANY DAMAGE TO THE EXISTING AIRPORT LIGHTING SYSTEM CAUSED BY CONSTRUCTION OPERATIONS SHALL BE IMMEDIATELY NOTED TO THE OWNER AND REPAIRED BY THE CONTRACTOR AT THE CONTRACTOR'S EXPENSE AND TO THE OWNER'S SPECIFICATIONS.
- 21. DEBRIS, WASTE, AND LOOSE MATERIAL CAPABLE OF CAUSING DAMAGE TO AIRCRAFT LANDING GEAR, PROPELLERS AND ROTORS, OR OF BEING INGESTED BY JET ENGINES SHALL NOT BE LEFT ON ACTIVE AIRCRAFT MOVEMENT AREAS. MATERIAL DROPPED WITHIN THESE AREAS SHALL BE REMOVED CONTINUOUSLY DURING WORKING HOURS.
- 22. THE CONTRACTOR SHALL FURNISH AND INSTALL TEMPORARY REFLECTORIZED SIGNS TO CLEARLY MARK THE DESIGNATED ACCESS ROUTES TO AFFECTED AREAS OF AIRPORT PROPERTY. CONTRACTOR SHALL CONTROL ACCESS TO THE WORKING AREA BY CONSTRUCTION VEHICLES AS DELINEATED ON THIS PLAN. THE COST OF THIS WORK SHALL BE INCIDENTAL TO THE MOBILIZATION LINE ITEM.
- 23. THE CONTRACTOR SHALL BE RESPONSIBLE FOR INFORMING ALL PERSONS UNDER THEIR CONTROL THAT UNAUTHORIZED CONSTRUCTION PERSONNEL FOUND IN RESTRICTED AREAS OF THE AIRPORT SHOWN ON THE SAFETY PLAN ARE SUBJECT TO ARREST FOR A PUNISHABLE FEDERAL OFFENSE AND WILL PROMPTLY AND PERMANENTLY BE REMOVED FROM THE JOB. ALL AREAS INSIDE THE PERIMETER FENCE ARE RESTRICTED. PERSONNEL ARE ONLY AUTHORIZED IN CONSTRUCTION AREAS.
- 24. THE CONTRACTOR SHALL PERFORM CONSTRUCTION OPERATIONS AS NECESSARY TO MINIMIZE ATTRACTION TO BIRDS CAUSED BY PONDED WATER AND GRASS SEED.
- 25. THE CONTRACTOR SHALL PROVIDE, INSTALL, AND MAINTAIN FLASHING LIGHTS AND BARRICADES ALONG AIRCRAFT APRON EDGES OR WHERE TEMPORARY PAVEMENT CLOSURES OR AIRCRAFT LIMITATIONS ARE REQUIRED. BARRICADES SHALL BE PLACED END-TO-END ON CENTER OR AS NOTED ALONG THE AFFECTED PAVEMENT EDGE OR ACROSS THE PAVEMENT OF A CLOSED TAXIWAY. THE CONTRACTOR SHALL DAILY MAINTAIN THE LIGHTS AND BARRICADES IN AN OPERABLE CONDITION FOR THE DURATION OF THE PROJECT. THE CONTRACTOR SHALL FURNISH THE OWNER A CONTACT NUMBER FOR 24- HOUR MAINTENANCE OF LIGHTS AND BARRICADES. THE COST FOR BARRICADES AND LIGHTS SHALL BE INCLUDED IN THE "AIRFIELD BARRICADES" PAY ITEM.
- 26. THE CONTRACTOR SHALL COMPLY WITH ALL SECURITY REQUIREMENTS SPECIFIED HEREIN. THE CONTRACTOR SHALL DESIGNATE IN WRITING TO THE OWNER THE NAME OF ITS "CONTRACTOR SECURITY OFFICER". THE CONTRACTOR'S SECURITY OFFICER SHALL BE RESPONSIBLE FOR BRIEFING ALL CONTRACTOR PERSONNEL ON THESE REQUIREMENTS.
- 27. THE CONTRACTOR'S SECURITY OFFICER SHALL BE RESPONSIBLE FOR BRIEFING ALL CONTRACTOR PERSONNEL ON THESE REQUIREMENTS. CONTRACTOR EMPLOYEES SHALL ATTEND THE OWNER'S SECURITY TRAINING SESSION AND SHALL BE BRIEFED ON THESE REQUIREMENTS PRIOR TO WORKING IN THE CONSTRUCTION AREAS.
- 28. THE CONTRACTOR SHALL ACQUAINT THEIR SUPERVISORS AND EMPLOYEES WITH THE AIRPORT ACTIVITIES AND OPERATIONS THAT ARE INHERENT AT THIS AIRPORT AND SHALL CONDUCT THEIR CONSTRUCTION ACTIVITIES TO CONFORM TO ALL ROUTINE AND EMERGENCY AIR TRAFFIC REQUIREMENTS AND TO THE GUIDELINES ON SAFETY.

- CONSTRUCTION WORK BEGINS.
- 30. ALL LOCATIONS USED FOR HAUL ROUTES, STAGING AREAS, EMPLOYEE PARKING, AND MATERIAL STORAGE SHALL BE RESTORED TO ORIGINAL CONDITION WHEN ALL CONSTRUCTION IS COMPLETED.
- 31. THE CONTRACTOR IS ENCOURAGED TO DOCUMENT VIA PICTURES OR VIDEO THE PRECONSTRUCTION CONDITION OF ALL AIRPORT PAVEMENTS AND STRUCTURES. ANY DAMAGE NOTICED AFTER THE CONTRACTOR'S MOBILIZATION WILL BE ASSUMED TO BE CAUSED BY THE CONTRACTOR TO BE FULLY REPAIRED AT THE CONTRACTOR'S EXPENSE.
- 32. SUFFICIENT SWEEPERS AND CLEAN UP EQUIPMENT SHALL BE PROVIDED IN ORDER THAT ALL LOOSE MATERIAL, DEBRIS, AND MUD CAN BE REMOVED FROM ALL AIRPORT OPERATIONS AREAS ON A
- CONTINUOUS BASIS. 33. GATES AT CONSTRUCTION ENTRANCES SHALL REMAIN CLOSED AND LOCKED AT ALL TIMES WHEN THE ENTRANCE IS NOT IN USE BY CONSTRUCTION PERSONNEL. GATES TO BE MANNED BY CONTRACTOR
- 34. CONTRACTOR SHALL SUBMIT MSCAA & FAA UTILITY LOCATE REQUEST FORM PRIOR TO EXECUTION.
- 35. CONTRACTOR SHALL PREPARE A SAFETY PLAN COMPLIANCE DOCUMENT (SPCD) THAT DETAIL HOW THE CONTRACTOR WILL COMPLY WITH THE CONSTRUCTION SAFETY & PHASING PLAN (CSPP). THE SPCD MUST BE APPROVED BY THE AIRPORT OPERATOR PRIOR TO THE ISSUANCE OF A NOTICE TO



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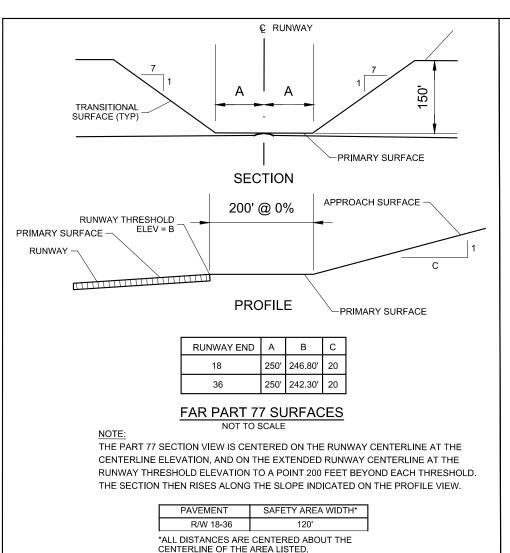
LOCAL EMERGENCY PHONE NUMBERS EMERGENCY: 911 MILLINGTON POLICE DEPT: (901) 872-3333 FIRE DEPARTMENT: (901) 873-5800 AIRPORT: (901) 358-0028 MEDICAL: (901) 516-5200

UTILITY CONTACTS

LIQUIDATED DAMAGES \$2,000 PER CALENDAR DAY


MLGW: (901) 528-4270

CONTRACT TIME 45 CALENDAR DAYS



SAFETY AREA DIMENSIONS

PERSONNEL WHEN OPEN.

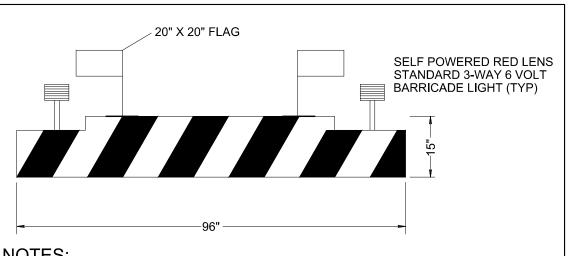

NOTES:

- 1. BARRICADES INTENDED FOR SHORT TERM CLOSURE OF AIRCRAFT ROUTES.
- 2. BARRICADE SHALL BE EQUIPPED WITH RED FLASHING LIGHTS THAT ARE SECURELY FASTENED TO THE BARRICADE TO AVOID JET INGESTION.
- 3. BARRICADES SHALL BE SPACED A MAXIMUM OF 8 FT FROM END TO END.
- 4. BARRICADES SHALL CONFORM TO AC 150/5370-2, LATEST EDITION.
- 5. BARRICADES SHALL BE NEUBERT AERO CORP. (NAC) AB811 OR EQUIVALENT AS APPROVED BY THE ENGINEER.
- 7. CONTRACTOR TO FURNISH, INSTALL, AND MAINTAIN BARRICADES THROUGHOUT

6. FILL BARRICADE BASE WITH WATER OR SAND TO ADD ADDITIONAL WEIGHT.

THE DURATION OF THE PROJECT. 8. BARRICADES SHALL BE PAID FOR UNDER C-105-6.2.

8' SAFETY BARRICADE

N.T.S.

ROGRAM MANAGER

BARGE BARGE DESIGN SOLUTIONS, INC

65 GERMANTOWN CT, SUITE 100

MEMPHIS, TN 38018 33276-02

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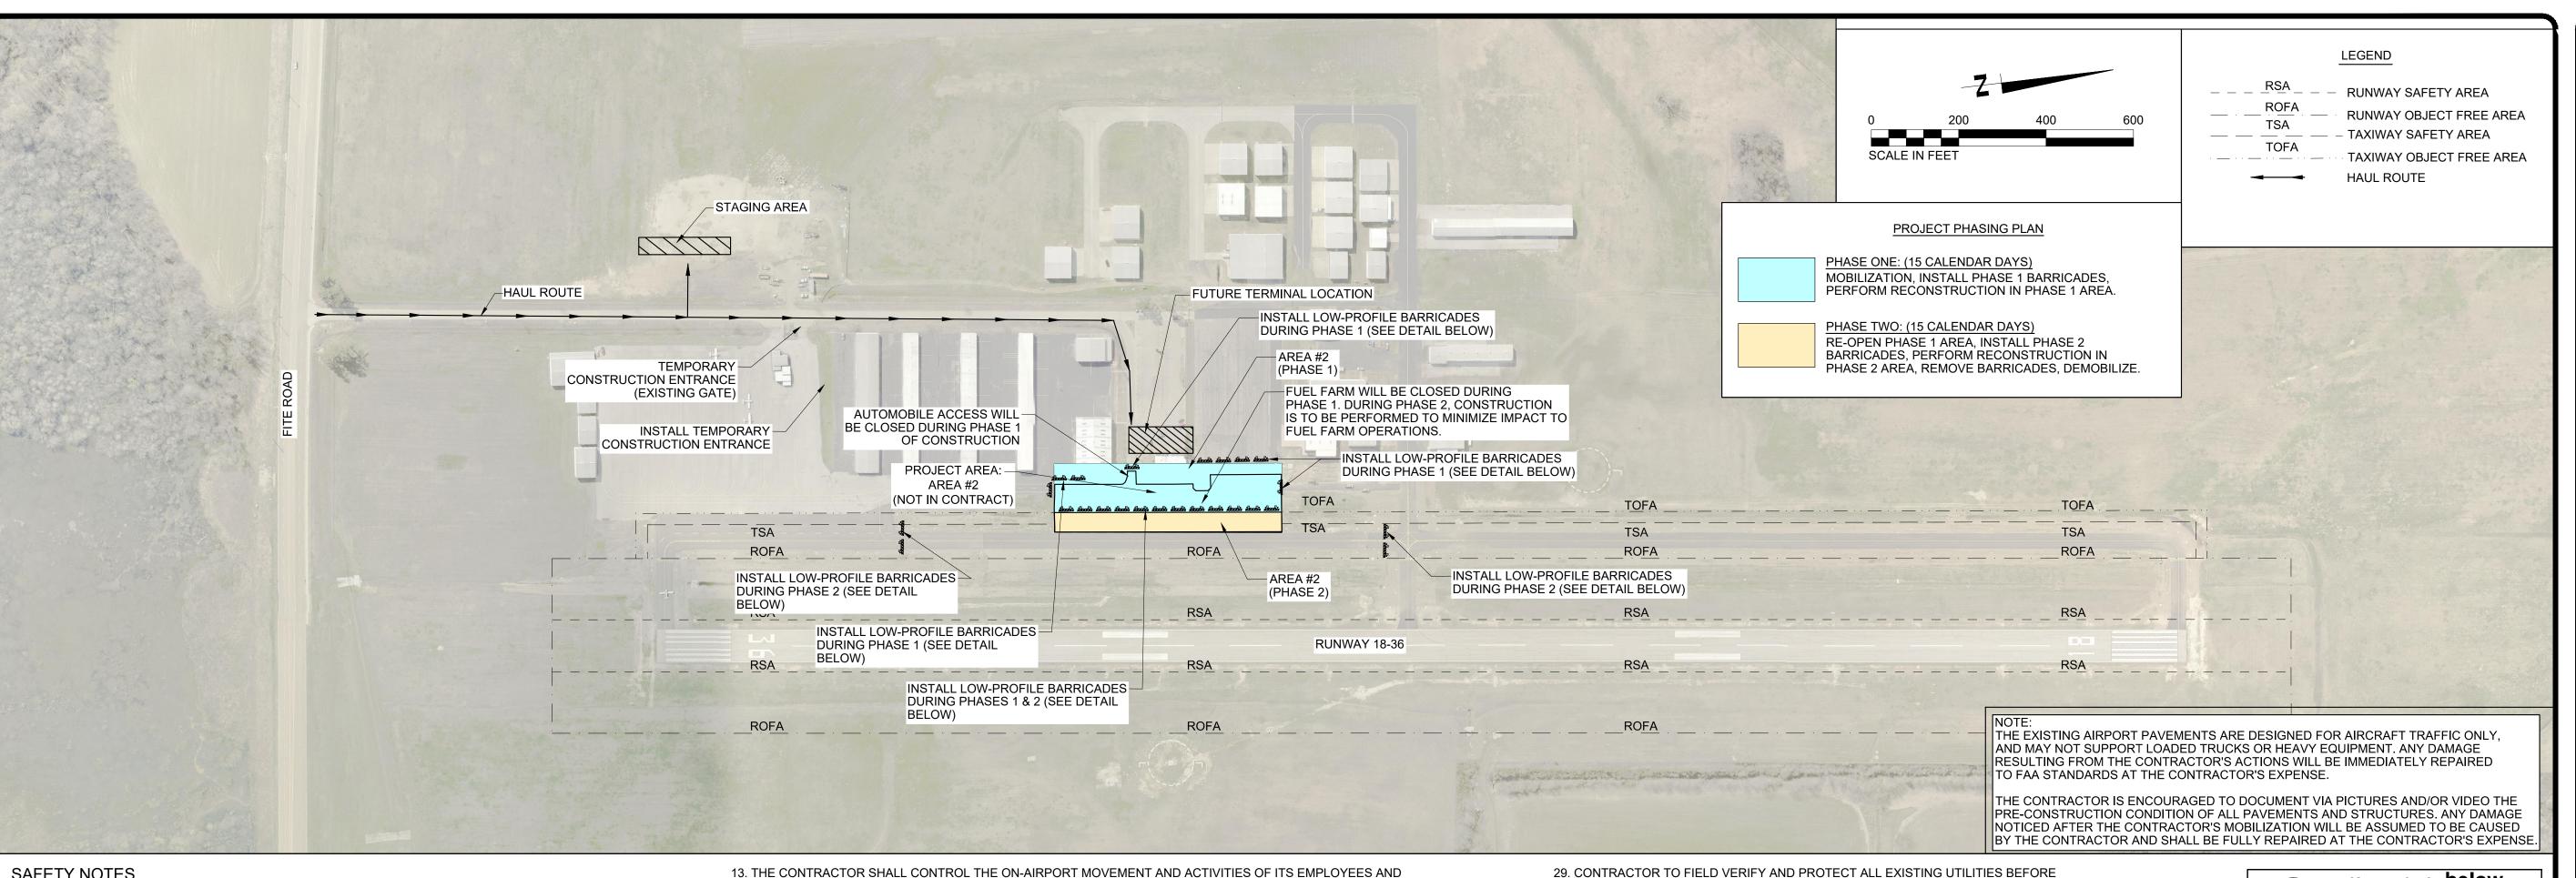
CHARLES BAKER PAVEMENT RECONSTRUCTION

SHEET TITLE:

CONSTRUCTION SAFETY & PHASING PLAN (AREA 1)

DWG. FILE NAME 3327602-11C-SF-01.DWG

C-SF-01 03/11/2024 "=200"



BEYOND RUNWAY END. (RSA)

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- 13. THE CONTRACTOR SHALL CONTROL THE ON-AIRPORT MOVEMENT AND ACTIVITIES OF ITS EMPLOYEES AND SUBCONTRACTORS.
- 14. OPEN-FLAME WELDING OR TORCH-CUTTING OPERATIONS ARE PROHIBITED UNLESS ADEQUATE FIRE AND SAFETY PRECAUTIONS HAVE BEEN APPROVED BY THE OWNER.
- 15. OPEN TRENCHES. EXCAVATIONS AND STOCKPILED MATERIALS AT THE CONSTRUCTION SITE SHALL BE PROMINENTLY MARKED WITH ORANGE CONSTRUCTION FENCING WITH BARRELS AND WITH FLASHING AMBER LIGHT UNITS (ACCEPTABLE TO THE OWNER) DURING HOURS OF RESTRICTED VISIBILITY OR DARKNESS.
- 16. STOCKPILED MATERIAL SHALL BE CONSTRAINED IN A MANNER TO PREVENT MOVEMENT AS A RESULT OF AIRCRAFT OR WIND.
- 17. ALL VEHICLES BELONGING TO THE FOREMAN AND SUPERINTENDENT SHALL CONTAIN RADIOS CAPABLE OF TRANSMITTING AND RECEIVING THE UNICOM/CTAF FREQUENCY OF 122.80 MHZ. NORMAL RADIO COMMUNICATIONS BETWEEN CONTRACTOR
- 18. ALL CONSTRUCTION TRAFFIC WHICH CROSSES AIRPORT OPERATIONAL SAFETY AREAS MUST BE CONTROLLED BY FLAGMEN. ALL FLAGMEN CONTROLLING CONSTRUCTION TRAFFIC ACROSS AIRPORT OPERATIONAL AREAS SHALL ALSO BE EQUIPPED WITH A RADIO WHICH WILL OPERATE ON THE UNICOM/CTAF FREQUENCY OF 122.80 MHZ.
- 19. CONTRACTOR TO PROVIDE A MINIMUM OF TWO (2) RADIOS CAPABLE OF OPERATING ON 122.80 MHZ ON THE PROJECT SITE FOR CONTRACTOR USE AT ALL TIMES DURING CONSTRUCTION.
- 20. ANY DAMAGE TO THE EXISTING AIRPORT LIGHTING SYSTEM CAUSED BY CONSTRUCTION OPERATIONS SHALL BE IMMEDIATELY NOTED TO THE OWNER AND REPAIRED BY THE CONTRACTOR AT THE CONTRACTOR'S EXPENSE AND TO THE OWNER'S SPECIFICATIONS.
- 21. DEBRIS, WASTE, AND LOOSE MATERIAL CAPABLE OF CAUSING DAMAGE TO AIRCRAFT LANDING GEAR, PROPELLERS AND ROTORS, OR OF BEING INGESTED BY JET ENGINES SHALL NOT BE LEFT ON ACTIVE AIRCRAFT MOVEMENT AREAS. MATERIAL DROPPED WITHIN THESE AREAS SHALL BE REMOVED CONTINUOUSLY DURING WORKING HOURS.
- 22. THE CONTRACTOR SHALL FURNISH AND INSTALL TEMPORARY REFLECTORIZED SIGNS TO CLEARLY MARK THE DESIGNATED ACCESS ROUTES TO AFFECTED AREAS OF AIRPORT PROPERTY. CONTRACTOR SHALL CONTROL ACCESS TO THE WORKING AREA BY CONSTRUCTION VEHICLES AS DELINEATED ON THIS PLAN. THE COST OF THIS WORK SHALL BE INCIDENTAL TO THE MOBILIZATION LINE ITEM.
- 23. THE CONTRACTOR SHALL BE RESPONSIBLE FOR INFORMING ALL PERSONS UNDER THEIR CONTROL THAT UNAUTHORIZED CONSTRUCTION PERSONNEL FOUND IN RESTRICTED AREAS OF THE AIRPORT SHOWN ON THE SAFETY PLAN ARE SUBJECT TO ARREST FOR A PUNISHABLE FEDERAL OFFENSE AND WILL PROMPTLY AND PERMANENTLY BE REMOVED FROM THE JOB. ALL AREAS INSIDE THE PERIMETER FENCE ARE RESTRICTED. PERSONNEL ARE ONLY AUTHORIZED IN CONSTRUCTION AREAS.
- 24. THE CONTRACTOR SHALL PERFORM CONSTRUCTION OPERATIONS AS NECESSARY TO MINIMIZE ATTRACTION TO BIRDS CAUSED BY PONDED WATER AND GRASS SEED.
- 25. THE CONTRACTOR SHALL PROVIDE, INSTALL, AND MAINTAIN FLASHING LIGHTS AND BARRICADES ALONG AIRCRAFT APRON EDGES OR WHERE TEMPORARY PAVEMENT CLOSURES OR AIRCRAFT LIMITATIONS ARE REQUIRED. BARRICADES SHALL BE PLACED END-TO-END ON CENTER OR AS NOTED ALONG THE AFFECTED PAVEMENT EDGE OR ACROSS THE PAVEMENT OF A CLOSED TAXIWAY. THE CONTRACTOR SHALL DAILY MAINTAIN THE LIGHTS AND BARRICADES IN AN OPERABLE CONDITION FOR THE DURATION OF THE PROJECT. THE CONTRACTOR SHALL FURNISH THE OWNER A CONTACT NUMBER FOR 24- HOUR MAINTENANCE OF LIGHTS AND BARRICADES. THE COST FOR BARRICADES AND LIGHTS SHALL BE INCLUDED IN THE "AIRFIELD BARRICADES" PAY ITEM.
- 26. THE CONTRACTOR SHALL COMPLY WITH ALL SECURITY REQUIREMENTS SPECIFIED HEREIN. THE CONTRACTOR SHALL DESIGNATE IN WRITING TO THE OWNER THE NAME OF ITS "CONTRACTOR SECURITY OFFICER". THE CONTRACTOR'S SECURITY OFFICER SHALL BE RESPONSIBLE FOR BRIEFING ALL CONTRACTOR PERSONNEL ON THESE REQUIREMENTS.
- 27. THE CONTRACTOR'S SECURITY OFFICER SHALL BE RESPONSIBLE FOR BRIEFING ALL CONTRACTOR PERSONNEL ON THESE REQUIREMENTS. CONTRACTOR EMPLOYEES SHALL ATTEND THE OWNER'S SECURITY TRAINING SESSION AND SHALL BE BRIEFED ON THESE REQUIREMENTS PRIOR TO WORKING IN THE CONSTRUCTION AREAS.
- 28. THE CONTRACTOR SHALL ACQUAINT THEIR SUPERVISORS AND EMPLOYEES WITH THE AIRPORT ACTIVITIES AND OPERATIONS THAT ARE INHERENT AT THIS AIRPORT AND SHALL CONDUCT THEIR CONSTRUCTION ACTIVITIES TO CONFORM TO ALL ROUTINE AND EMERGENCY AIR TRAFFIC REQUIREMENTS AND TO THE GUIDELINES ON SAFETY.

- 29. CONTRACTOR TO FIELD VERIFY AND PROTECT ALL EXISTING UTILITIES BEFORE CONSTRUCTION WORK BEGINS.
- 30. ALL LOCATIONS USED FOR HAUL ROUTES, STAGING AREAS, EMPLOYEE PARKING, AND MATERIAL STORAGE SHALL BE RESTORED TO ORIGINAL CONDITION WHEN ALL CONSTRUCTION IS COMPLETED.
- 31. THE CONTRACTOR IS ENCOURAGED TO DOCUMENT VIA PICTURES OR VIDEO THE PRECONSTRUCTION CONDITION OF ALL AIRPORT PAVEMENTS AND STRUCTURES. ANY DAMAGE NOTICED AFTER THE CONTRACTOR'S MOBILIZATION WILL BE ASSUMED TO BE CAUSED BY THE CONTRACTOR TO BE FULLY REPAIRED AT THE CONTRACTOR'S EXPENSE.
- 32. SUFFICIENT SWEEPERS AND CLEAN UP EQUIPMENT SHALL BE PROVIDED IN ORDER THAT ALL LOOSE MATERIAL, DEBRIS, AND MUD CAN BE REMOVED FROM ALL AIRPORT OPERATIONS AREAS ON A CONTINUOUS BASIS.
- 33. GATES AT CONSTRUCTION ENTRANCES SHALL REMAIN CLOSED AND LOCKED AT ALL TIMES WHEN THE ENTRANCE IS NOT IN USE BY CONSTRUCTION PERSONNEL. GATES TO BE MANNED BY CONTRACTOR PERSONNEL WHEN OPEN.
- 34. CONTRACTOR SHALL SUBMIT MSCAA & FAA UTILITY LOCATE REQUEST FORM PRIOR TO EXECUTION.
- 35. CONTRACTOR SHALL PREPARE A SAFETY PLAN COMPLIANCE DOCUMENT (SPCD) THAT DETAIL HOW THE CONTRACTOR WILL COMPLY WITH THE CONSTRUCTION SAFETY & PHASING PLAN (CSPP). THE SPCD MUST BE APPROVED BY THE AIRPORT OPERATOR PRIOR TO THE ISSUANCE OF A NOTICE TO



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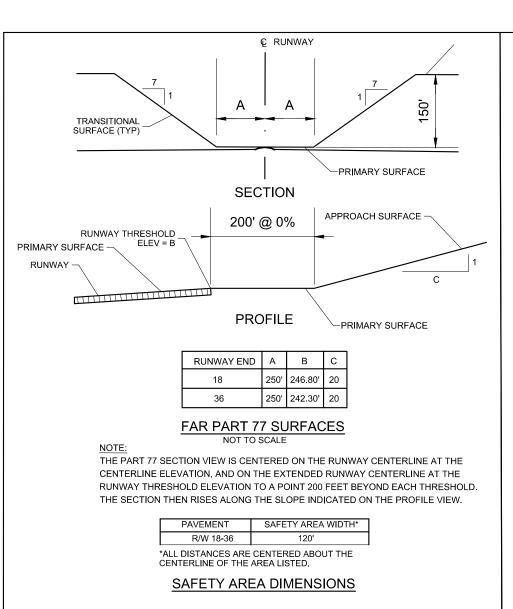
LOCAL EMERGENCY PHONE NUMBERS EMERGENCY: 911 MILLINGTON POLICE DEPT: (901) 872-3333 FIRE DEPARTMENT: (901) 873-5800 AIRPORT: (901) 358-0028 MEDICAL: (901) 516-5200


UTILITY CONTACTS

LIQUIDATED DAMAGES \$2,000 PER CALENDAR DAY

MLGW: (901) 528-4270

CONTRACT TIME 30 CALENDAR DAYS



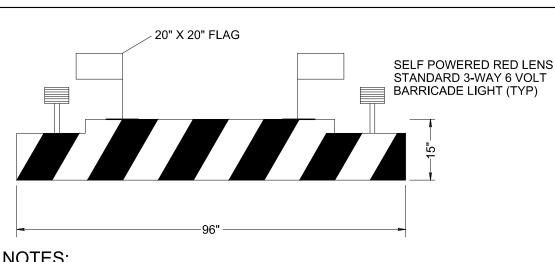

NOTES:

- 1. BARRICADES INTENDED FOR SHORT TERM CLOSURE OF AIRCRAFT ROUTES.
- 2. BARRICADE SHALL BE EQUIPPED WITH RED FLASHING LIGHTS THAT ARE SECURELY FASTENED TO THE BARRICADE TO AVOID JET INGESTION.
- 3. BARRICADES SHALL BE SPACED A MAXIMUM OF 8 FT FROM END TO END.
- 4. BARRICADES SHALL CONFORM TO AC 150/5370-2, LATEST EDITION.
- 5. BARRICADES SHALL BE NEUBERT AERO CORP. (NAC) AB811 OR EQUIVALENT
- AS APPROVED BY THE ENGINEER. 6. FILL BARRICADE BASE WITH WATER OR SAND TO ADD ADDITIONAL WEIGHT.
- 7. CONTRACTOR TO FURNISH, INSTALL, AND MAINTAIN BARRICADES THROUGHOUT
- THE DURATION OF THE PROJECT. 8. BARRICADES SHALL BE PAID FOR UNDER C-105-6.2.

8' SAFETY BARRICADE

N.T.S.

ROGRAM MANAGER

BARGE BARGE DESIGN SOLUTIONS, INC

65 GERMANTOWN CT, SUITE 100

33276-02

MEMPHIS, TN 38018

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NOT IN CONTRACT

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REVISIONS DESCRIPTION ISSUED FOR BID

MSCAA PROJ. NO. 18-1420-01

CHARLES BAKER

PAVEMENT RECONSTRUCTION


SHEET TITLE:

CONSTRUCTION SAFETY & PHASING PLAN (AREA 2)

DWG. FILE NAME 3327602-12C-SF-02.DWG

03/11/2024 "=200"

C-SF-02

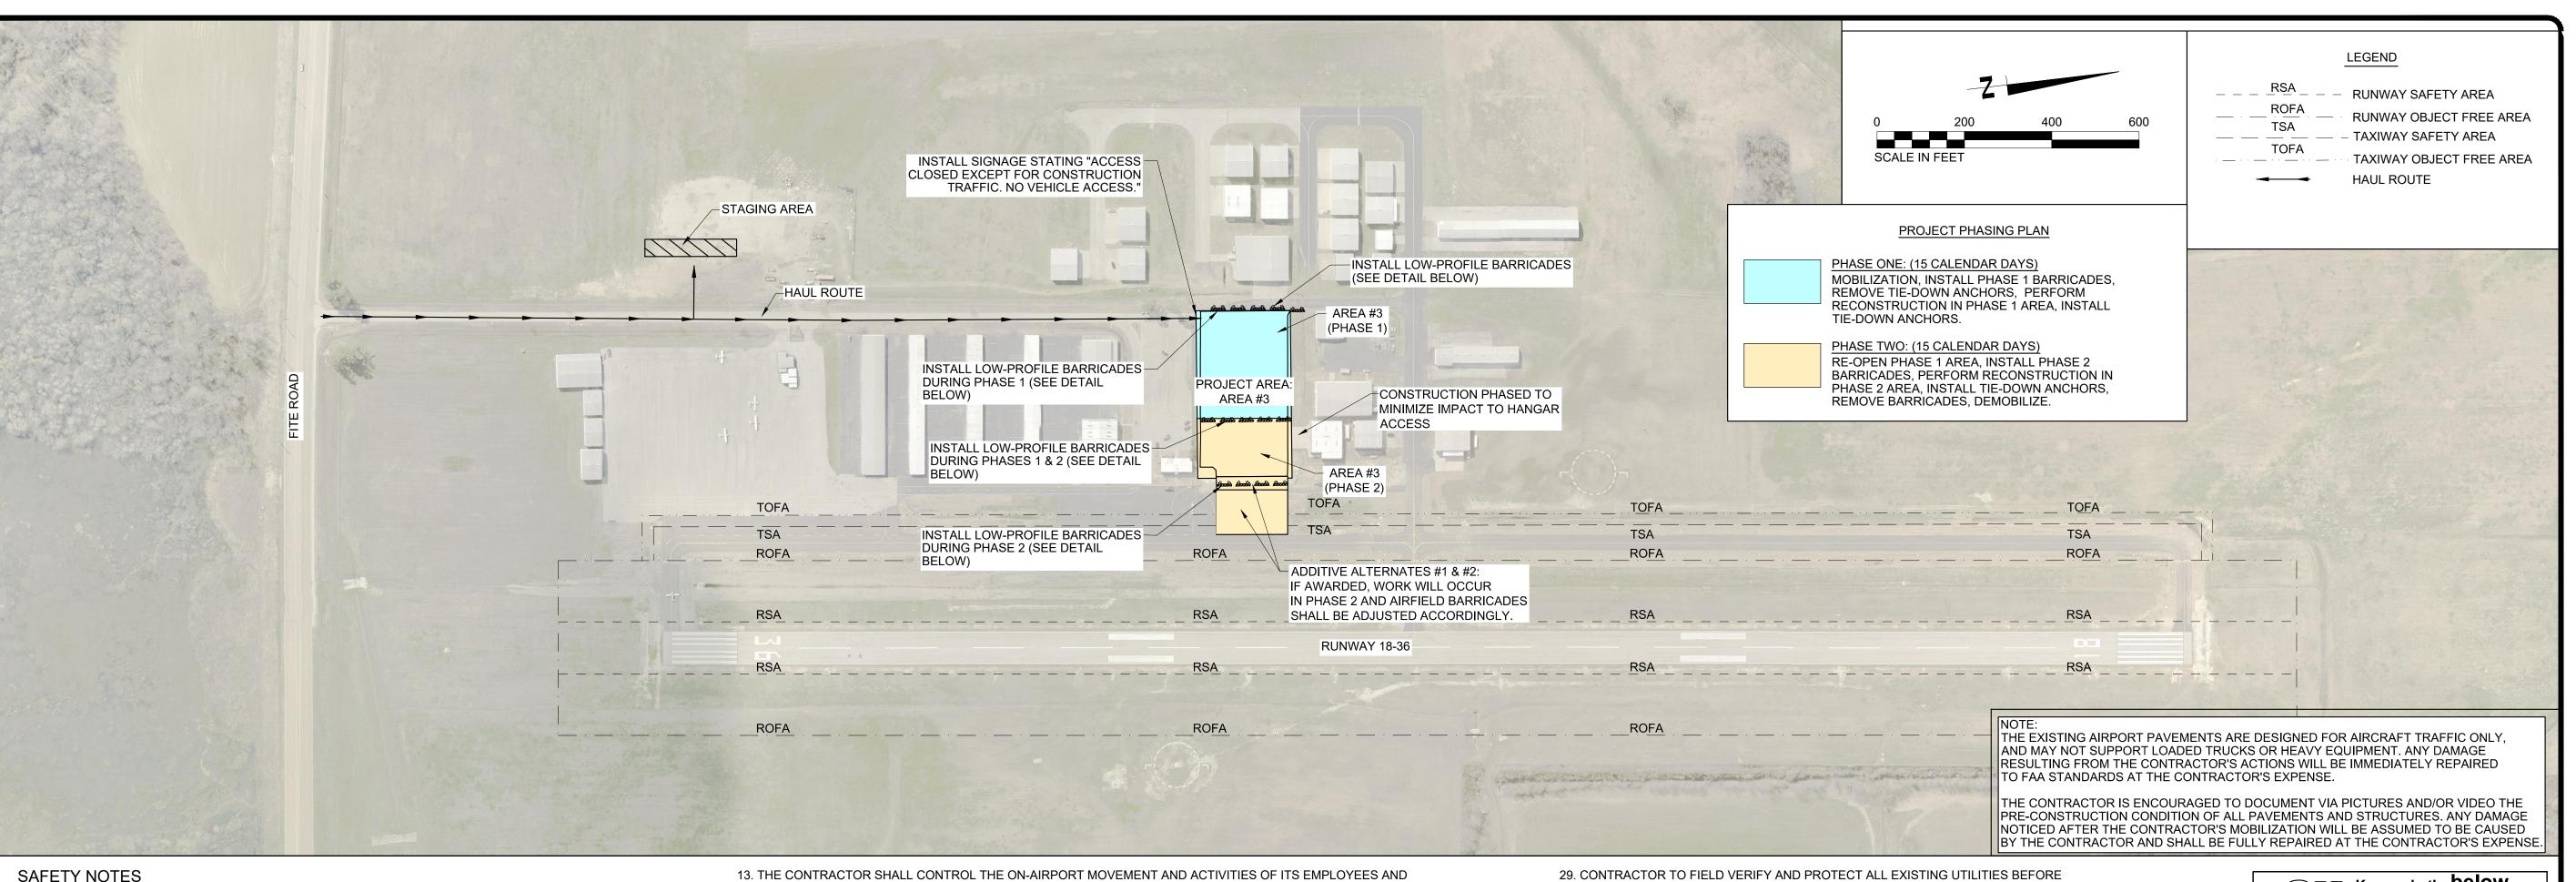

- 1. IT SHALL BE THE RESPONSIBILITY OF THE CONTRACTOR TO NOTIFY THE ENGINEER AND THE OWNER NO LESS THAN TWO (2) DAYS PRIOR TO ENTERING THE CONSTRUCTION SITE FOR ANY PURPOSE SO THAT THEY MAY PUBLISH "NOTICES TO AIR MISSIONS" (NOTAM) OF THE CONSTRUCTION ACTIVITIES.
- 2. AIRPORT OPERATION SAFETY AREAS ARE DEFINED AS FOLLOWS:
- 2.1. RUNWAY 18-36 RSA 60 FEET FROM THE CENTERLINE OF PAVEMENT AND 240 FEET
- BEYOND RUNWAY END. (RSA) 2.2. RUNWAY 18-36 OFA - 200 FEET FROM THE CENTERLINE OF PAVEMENT AND 240 FEET BEYOND RUNWAY END. (ROFA)
- 2.3. TAXIWAY SAFETY AREA 39.5' FROM CENTERLINE OF PAVEMENT. (TSA)
- 2.4. TAXIWAY OBJECT FREE AREA 62' FROM CENTERLINE OF PAVEMENT. (TOFA) 2.4. TAXILANE OBJECT FREE AREA - 55' FROM CENTERLINE OF PAVEMENT. (TLOFA)
- 3. NO SEPARATE MEASUREMENT OR PAYMENT WILL BE MADE FOR RADIOS, CONSTRUCTION OF AND MAINTENANCE OF HAUL ROUTES AND CONSTRUCTION ENTRANCE, ETC. AS INCLUDED IN THESE NOTES. ALL COSTS ASSOCIATED WITH THESE ITEMS MUST BE INCLUDED IN THE CONTRACT BID PRICES WHICH WOULD MOST LIKELY INCLUDE THEM.
- 4. THE CONTRACTOR AND PERSONNEL SHALL NOT, AT ANY TIME, BE ON THE RUNWAY, TAXIWAYS, OR MAIN APRON UNLESS THE AIRPORT MANAGER GIVES PRIOR APPROVAL.
- 5. THE CONTRACTOR SHALL TAKE EXTREME CAUTION AROUND ALL EXISTING AIRPORT EQUIPMENT.
- 6. THE CONSTRUCTION ENTRANCE, STAGING AREA, EMPLOYEE PARKING, STOCKPILE AREA, WASTE AREA, AND BORROW AREA SHALL BE COORDINATED WITH THE AIRPORT MANAGER.
- 7. THE CONTRACTOR SHALL HAVE AN INDIVIDUAL ON 24-HOUR CALL FOR EMERGENCY MAINTENANCE OF AIRPORT HAZARD LIGHTING. BARRICADES, AND OTHER EMERGENCIES WHICH MAY ARISE AS A RESULT OF WORK.
- 8. THE CONTRACTOR'S PERSONNEL AND EQUIPMENT SHALL NOT BE PERMITTED OUTSIDE THE CONSTRUCTION WORK LIMITS WITHOUT BEING ESCORTED BY THE OWNER-APPROVED ESCORT.
- 9. IT SHALL BE THE RESPONSIBILITY OF THE CONTRACTOR TO REVIEW THE SAFETY PROVISIONS INCORPORATED IN THE FOLLOWING FEDERAL AVIATION ADMINISTRATION (FAA) DOCUMENTS, WHICH ARE AVAILABLE FOR REVIEW BY DOWNLOADING THE DOCUMENTS ON LINE AT HTTP://WWW.FAA.GOV:
- 9.1. ADVISORY CIRCULAR NUMBER 150/5370-10 (LATEST EDITION), "STANDARDS FOR SPECIFYING CONSTRUCTION OF AIRPORTS"
- 9.2. ADVISORY CIRCULAR NUMBER 150/5370-2 (LATEST EDITION), "OPERATIONAL
- SAFETY ON AIRPORTS DURING CONSTRUCTION" 9.3. ADVISORY CIRCULAR NUMBER 150/5210-5-2 (LATEST EDITION), "PAINTING, MARKING, AND LIGHTING OF VEHICLES USED ON AN AIRPORT"
- 10. THE CONTRACTOR SHALL BE REQUIRED TO MINIMIZE DUST CREATED BY CONSTRUCTION ACTIVITIES USING WATER OR OTHER DEVICES. ANY COST ASSOCIATED WITH DUST CONTROL SHALL BE CONSIDERED INCIDENTAL TO THE PROJECT. IN THE EVENT DUST WHICH IS CREATED BY CONSTRUCTION ACTIVITIES BECOMES A HAZARD TO AIRFIELD OPERATIONS AND/OR AIRCRAFT NAVIGATION, CONSTRUCTION ACTIVITIES WILL BE SHUT DOWN. THIS SHUTDOWN TIME WILL NOT BE A BASIS FOR CLAIMS FOR ADDITIONAL CONTRACT TIME OR COMPENSATION.
- 11. AIRCRAFT OPERATIONS SHALL, AT ALL TIMES, HAVE PRIORITY OVER ALL VEHICLES, EQUIPMENT, AND PERSONNEL. THE CONTRACTOR SHALL EMPLOY STRICT MEASURES TO PREVENT ANY CONFLICT BETWEEN CONTRACTOR PERSONNEL AND AIRCRAFT ON ANY ACTIVE AIRFIELD PAVEMENT. THE CONTRACTOR SHALL REMAIN CLEAR OF ACTIVE RUNWAYS AND TAXIWAYS.
- 12. ALL CONTRACTOR VEHICLES, INCLUDING HAULING VEHICLES, THAT ARE AUTHORIZED TO OPERATE ON THE AIRPORT WITHIN THE DESIGNATED LIMITS OF CONSTRUCTION OR HAUL ROUTES AS DEFINED HEREIN, SHALL BE EQUIPPED WITH ROTATING OR FLASHING AMBER LIGHTS. WHEN OPERATING DURING PERIODS OF DARKNESS OR LIMITED VISIBILITY, CONTRACTOR'S VEHICLE SHALL BE EQUIPPED WITH SUCH ROTATING OR FLASHING AMBER LIGHTS, AND HAULING VEHICLES NOT SO EQUIPPED SHALL BE ESCORTED BY A VEHICLE SO EQUIPPED.

- SUBCONTRACTORS.
- 14. OPEN-FLAME WELDING OR TORCH-CUTTING OPERATIONS ARE PROHIBITED UNLESS ADEQUATE FIRE AND SAFETY PRECAUTIONS HAVE BEEN APPROVED BY THE OWNER.
- 15. OPEN TRENCHES. EXCAVATIONS AND STOCKPILED MATERIALS AT THE CONSTRUCTION SITE SHALL BE PROMINENTLY MARKED WITH ORANGE CONSTRUCTION FENCING WITH BARRELS AND WITH FLASHING AMBER LIGHT UNITS (ACCEPTABLE TO THE OWNER) DURING HOURS OF RESTRICTED VISIBILITY OR DARKNESS.
- 16. STOCKPILED MATERIAL SHALL BE CONSTRAINED IN A MANNER TO PREVENT MOVEMENT AS A RESULT OF AIRCRAFT OR WIND.
- 17. ALL VEHICLES BELONGING TO THE FOREMAN AND SUPERINTENDENT SHALL CONTAIN RADIOS CAPABLE OF TRANSMITTING AND RECEIVING THE UNICOM/CTAF FREQUENCY OF 122.80 MHZ. NORMAL RADIO COMMUNICATIONS BETWEEN CONTRACTOR
- 18. ALL CONSTRUCTION TRAFFIC WHICH CROSSES AIRPORT OPERATIONAL SAFETY AREAS MUST BE CONTROLLED BY FLAGMEN. ALL FLAGMEN CONTROLLING CONSTRUCTION TRAFFIC ACROSS AIRPORT OPERATIONAL AREAS SHALL ALSO BE EQUIPPED WITH A RADIO WHICH WILL OPERATE ON THE UNICOM/CTAF FREQUENCY OF 122.80 MHZ.
- 19. CONTRACTOR TO PROVIDE A MINIMUM OF TWO (2) RADIOS CAPABLE OF OPERATING ON 122.80 MHZ ON THE PROJECT SITE FOR CONTRACTOR USE AT ALL TIMES DURING CONSTRUCTION.
- 20. ANY DAMAGE TO THE EXISTING AIRPORT LIGHTING SYSTEM CAUSED BY CONSTRUCTION OPERATIONS SHALL BE IMMEDIATELY NOTED TO THE OWNER AND REPAIRED BY THE CONTRACTOR AT THE CONTRACTOR'S EXPENSE AND TO THE OWNER'S SPECIFICATIONS.
- 21. DEBRIS, WASTE, AND LOOSE MATERIAL CAPABLE OF CAUSING DAMAGE TO AIRCRAFT LANDING GEAR, PROPELLERS AND ROTORS, OR OF BEING INGESTED BY JET ENGINES SHALL NOT BE LEFT ON ACTIVE AIRCRAFT MOVEMENT AREAS. MATERIAL DROPPED WITHIN THESE AREAS SHALL BE REMOVED CONTINUOUSLY DURING WORKING HOURS.
- 22. THE CONTRACTOR SHALL FURNISH AND INSTALL TEMPORARY REFLECTORIZED SIGNS TO CLEARLY MARK THE DESIGNATED ACCESS ROUTES TO AFFECTED AREAS OF AIRPORT PROPERTY. CONTRACTOR SHALL CONTROL ACCESS TO THE WORKING AREA BY CONSTRUCTION VEHICLES AS DELINEATED ON THIS PLAN. THE COST OF THIS WORK SHALL BE INCIDENTAL TO THE MOBILIZATION LINE ITEM.
- 23. THE CONTRACTOR SHALL BE RESPONSIBLE FOR INFORMING ALL PERSONS UNDER THEIR CONTROL THAT UNAUTHORIZED CONSTRUCTION PERSONNEL FOUND IN RESTRICTED AREAS OF THE AIRPORT SHOWN ON THE SAFETY PLAN ARE SUBJECT TO ARREST FOR A PUNISHABLE FEDERAL OFFENSE AND WILL PROMPTLY AND PERMANENTLY BE REMOVED FROM THE JOB. ALL AREAS INSIDE THE PERIMETER FENCE ARE RESTRICTED. PERSONNEL ARE ONLY AUTHORIZED IN CONSTRUCTION AREAS.
- 24. THE CONTRACTOR SHALL PERFORM CONSTRUCTION OPERATIONS AS NECESSARY TO MINIMIZE ATTRACTION TO BIRDS CAUSED BY PONDED WATER AND GRASS SEED.
- 25. THE CONTRACTOR SHALL PROVIDE, INSTALL, AND MAINTAIN FLASHING LIGHTS AND BARRICADES ALONG AIRCRAFT APRON EDGES OR WHERE TEMPORARY PAVEMENT CLOSURES OR AIRCRAFT LIMITATIONS ARE REQUIRED. BARRICADES SHALL BE PLACED END-TO-END ON CENTER OR AS NOTED ALONG THE AFFECTED PAVEMENT EDGE OR ACROSS THE PAVEMENT OF A CLOSED TAXIWAY. THE CONTRACTOR SHALL DAILY MAINTAIN THE LIGHTS AND BARRICADES IN AN OPERABLE CONDITION FOR THE DURATION OF THE PROJECT. THE CONTRACTOR SHALL FURNISH THE OWNER A CONTACT NUMBER FOR 24- HOUR MAINTENANCE OF LIGHTS AND BARRICADES. THE COST FOR BARRICADES AND LIGHTS SHALL BE INCLUDED IN THE "AIRFIELD BARRICADES" PAY ITEM.
- 26. THE CONTRACTOR SHALL COMPLY WITH ALL SECURITY REQUIREMENTS SPECIFIED HEREIN. THE CONTRACTOR SHALL DESIGNATE IN WRITING TO THE OWNER THE NAME OF ITS "CONTRACTOR SECURITY OFFICER". THE CONTRACTOR'S SECURITY OFFICER SHALL BE RESPONSIBLE FOR BRIEFING ALL CONTRACTOR PERSONNEL ON THESE REQUIREMENTS.
- 27. THE CONTRACTOR'S SECURITY OFFICER SHALL BE RESPONSIBLE FOR BRIEFING ALL CONTRACTOR PERSONNEL ON THESE REQUIREMENTS. CONTRACTOR EMPLOYEES SHALL ATTEND THE OWNER'S SECURITY TRAINING SESSION AND SHALL BE BRIEFED ON THESE REQUIREMENTS PRIOR TO WORKING IN THE CONSTRUCTION AREAS.
- 28. THE CONTRACTOR SHALL ACQUAINT THEIR SUPERVISORS AND EMPLOYEES WITH THE AIRPORT ACTIVITIES AND OPERATIONS THAT ARE INHERENT AT THIS AIRPORT AND SHALL CONDUCT THEIR CONSTRUCTION ACTIVITIES TO CONFORM TO ALL ROUTINE AND EMERGENCY AIR TRAFFIC REQUIREMENTS AND TO THE GUIDELINES ON SAFETY.

- CONSTRUCTION WORK BEGINS.
- 30. ALL LOCATIONS USED FOR HAUL ROUTES, STAGING AREAS, EMPLOYEE PARKING, AND MATERIAL STORAGE SHALL BE RESTORED TO ORIGINAL CONDITION WHEN ALL CONSTRUCTION IS COMPLETED.
- 31. THE CONTRACTOR IS ENCOURAGED TO DOCUMENT VIA PICTURES OR VIDEO THE PRECONSTRUCTION CONDITION OF ALL AIRPORT PAVEMENTS AND STRUCTURES. ANY DAMAGE NOTICED AFTER THE CONTRACTOR'S MOBILIZATION WILL BE ASSUMED TO BE CAUSED BY THE CONTRACTOR TO BE FULLY REPAIRED AT THE CONTRACTOR'S EXPENSE.
- 32. SUFFICIENT SWEEPERS AND CLEAN UP EQUIPMENT SHALL BE PROVIDED IN ORDER THAT ALL LOOSE MATERIAL, DEBRIS, AND MUD CAN BE REMOVED FROM ALL AIRPORT OPERATIONS AREAS ON A CONTINUOUS BASIS.
- 33. GATES AT CONSTRUCTION ENTRANCES SHALL REMAIN CLOSED AND LOCKED AT ALL TIMES WHEN THE ENTRANCE IS NOT IN USE BY CONSTRUCTION PERSONNEL. GATES TO BE MANNED BY CONTRACTOR
- 34. CONTRACTOR SHALL SUBMIT MSCAA & FAA UTILITY LOCATE REQUEST FORM PRIOR TO EXECUTION.
- 35. CONTRACTOR SHALL PREPARE A SAFETY PLAN COMPLIANCE DOCUMENT (SPCD) THAT DETAIL HOW THE CONTRACTOR WILL COMPLY WITH THE CONSTRUCTION SAFETY & PHASING PLAN (CSPP). THE SPCD MUST BE APPROVED BY THE AIRPORT OPERATOR PRIOR TO THE ISSUANCE OF A NOTICE TO



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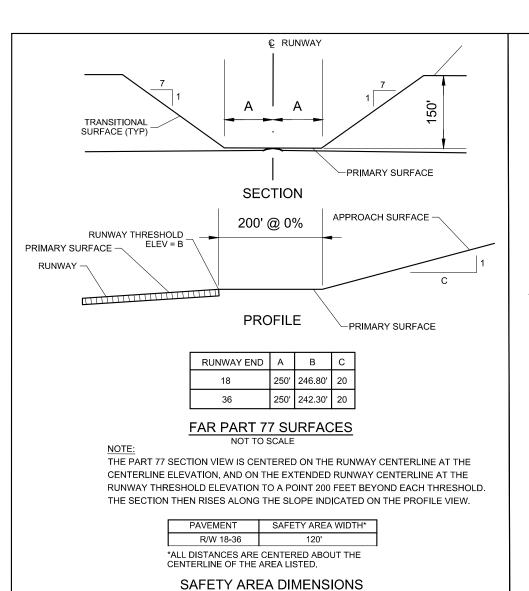
UTILITY CONTACTS

LIQUIDATED DAMAGES


\$2,000 PER CALENDAR DAY

MLGW: (901) 528-4270

CONTRACT TIME 30 CALENDAR DAYS



PERSONNEL WHEN OPEN.

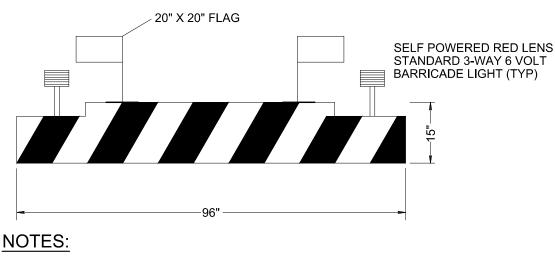

- 1. BARRICADES INTENDED FOR SHORT TERM CLOSURE OF AIRCRAFT ROUTES.
- 2. BARRICADE SHALL BE EQUIPPED WITH RED FLASHING LIGHTS THAT ARE SECURELY FASTENED TO THE BARRICADE TO AVOID JET INGESTION.
- 3. BARRICADES SHALL BE SPACED A MAXIMUM OF 8 FT FROM END TO END.
- 4. BARRICADES SHALL CONFORM TO AC 150/5370-2, LATEST EDITION.
- 5. BARRICADES SHALL BE NEUBERT AERO CORP. (NAC) AB811 OR EQUIVALENT AS APPROVED BY THE ENGINEER.
- 6. FILL BARRICADE BASE WITH WATER OR SAND TO ADD ADDITIONAL WEIGHT.
- 7. CONTRACTOR TO FURNISH, INSTALL, AND MAINTAIN BARRICADES THROUGHOUT THE DURATION OF THE PROJECT.

8. BARRICADES SHALL BE PAID FOR UNDER C-105-6.2.

8' SAFETY BARRICADE

N.T.S.



ROGRAM MANAGER

BARGE BARGE DESIGN SOLUTIONS, INC

65 GERMANTOWN CT, SUITE 100

MEMPHIS, TN 38018

33276-02 **JEM**

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> > REVISIONS

DESCRIPTION ISSUED FOR BID MSCAA PROJ. NO.

18-1420-01

CHARLES BAKER PAVEMENT RECONSTRUCTION

SHEET TITLE:


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CONSTRUCTION SAFETY & PHASING PLAN (AREA 3)

DWG. FILE NAME 3327602-13C-SF-03.DWG

03/11/2024

C-SF-03

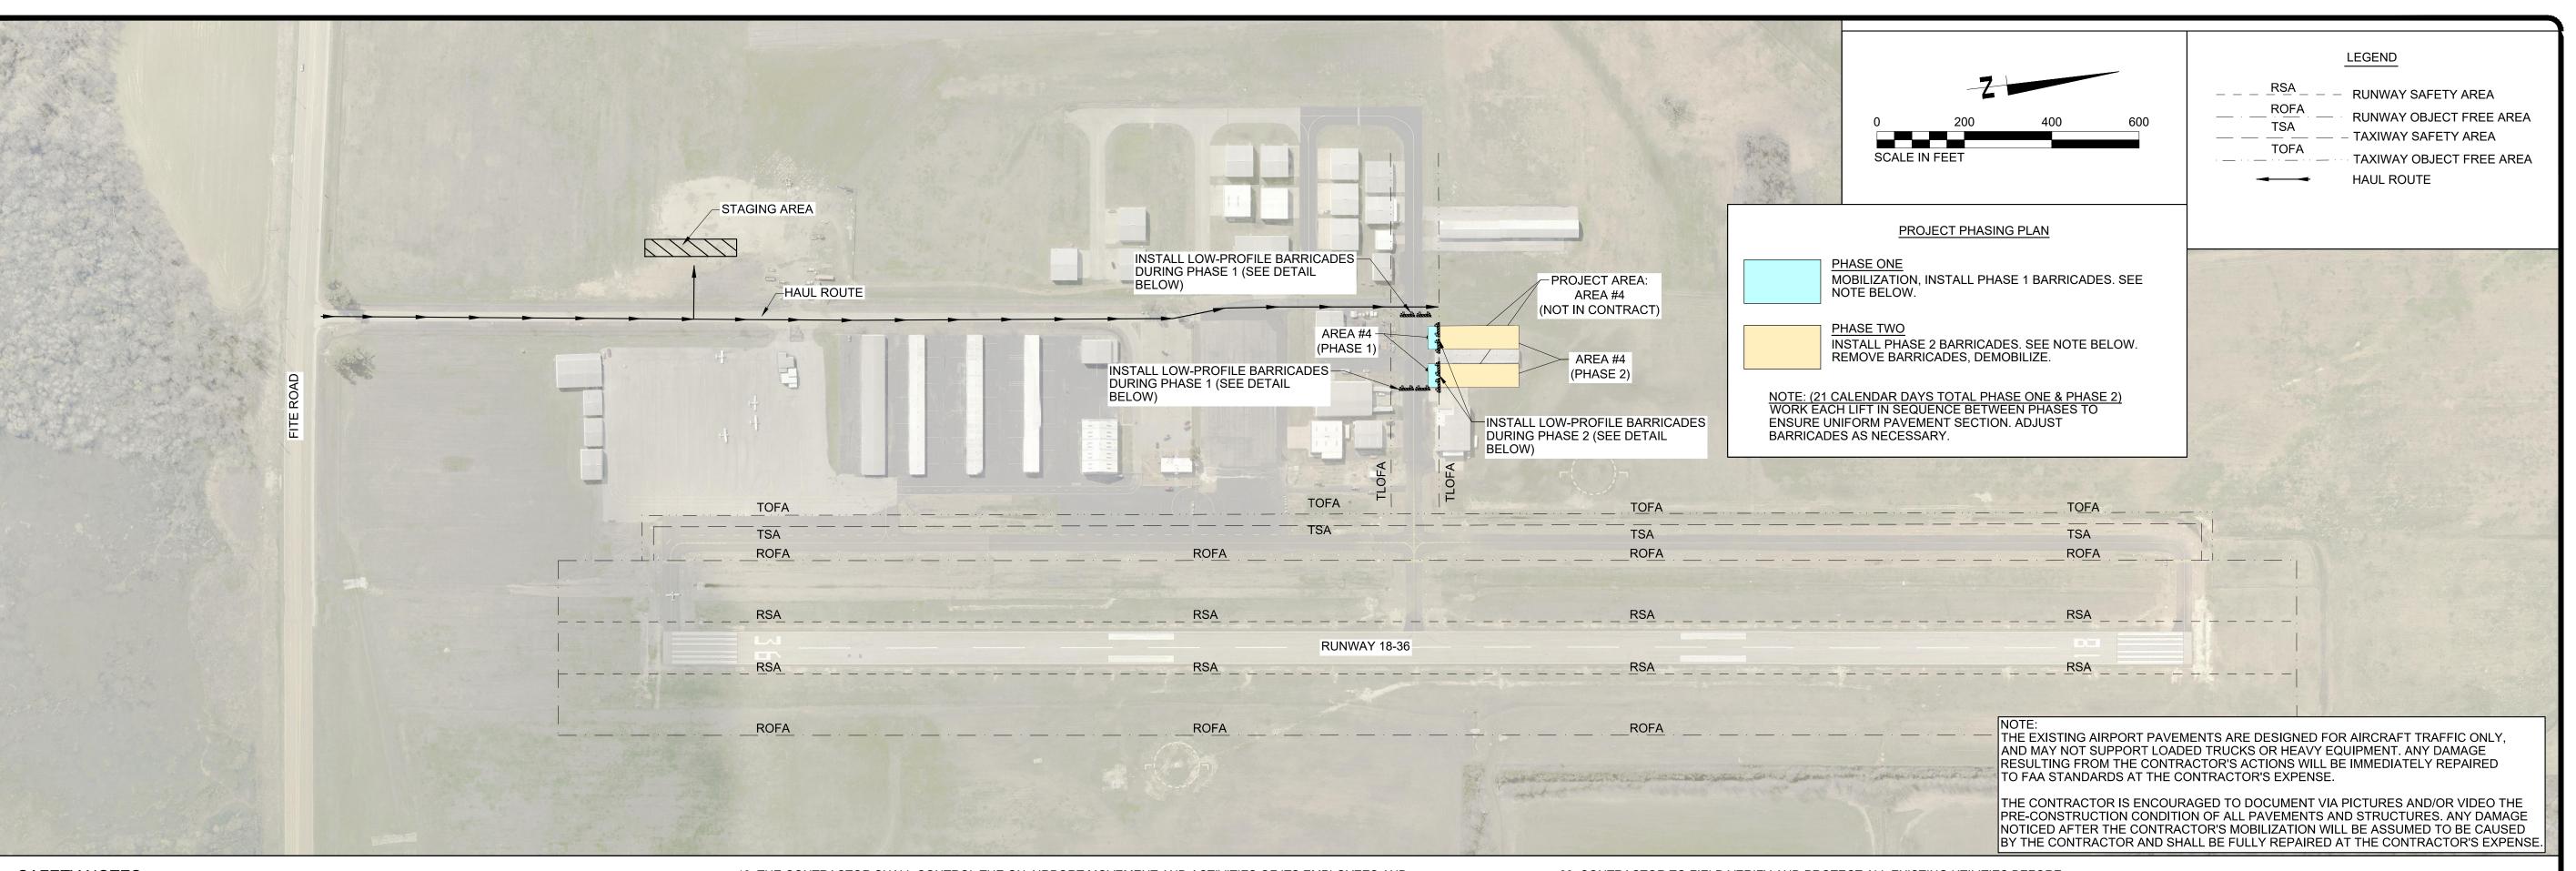

- 1. IT SHALL BE THE RESPONSIBILITY OF THE CONTRACTOR TO NOTIFY THE ENGINEER AND THE OWNER NO LESS THAN TWO (2) DAYS PRIOR TO ENTERING THE CONSTRUCTION SITE FOR ANY PURPOSE SO THAT THEY MAY PUBLISH "NOTICES TO AIR MISSIONS" (NOTAM) OF THE CONSTRUCTION ACTIVITIES.
- 2. AIRPORT OPERATION SAFETY AREAS ARE DEFINED AS FOLLOWS:
- 2.1. RUNWAY 18-36 RSA 60 FEET FROM THE CENTERLINE OF PAVEMENT AND 240 FEET
- BEYOND RUNWAY END. (RSA) 2.2. RUNWAY 18-36 OFA - 200 FEET FROM THE CENTERLINE OF PAVEMENT AND 240 FEET BEYOND RUNWAY END. (ROFA)
- 2.3. TAXIWAY SAFETY AREA 39.5' FROM CENTERLINE OF PAVEMENT. (TSA)
- 2.4. TAXIWAY OBJECT FREE AREA 62' FROM CENTERLINE OF PAVEMENT. (TOFA) 2.4. TAXILANE OBJECT FREE AREA - 55' FROM CENTERLINE OF PAVEMENT. (TLOFA)
- 3. NO SEPARATE MEASUREMENT OR PAYMENT WILL BE MADE FOR RADIOS, CONSTRUCTION OF AND MAINTENANCE OF HAUL ROUTES AND CONSTRUCTION ENTRANCE, ETC. AS INCLUDED IN THESE NOTES. ALL COSTS ASSOCIATED WITH THESE ITEMS MUST BE INCLUDED IN THE CONTRACT BID PRICES WHICH WOULD MOST LIKELY INCLUDE THEM.
- 4. THE CONTRACTOR AND PERSONNEL SHALL NOT, AT ANY TIME, BE ON THE RUNWAY, TAXIWAYS, OR MAIN APRON UNLESS THE AIRPORT MANAGER GIVES PRIOR APPROVAL.
- 5. THE CONTRACTOR SHALL TAKE EXTREME CAUTION AROUND ALL EXISTING AIRPORT EQUIPMENT.
- 6. THE CONSTRUCTION ENTRANCE, STAGING AREA, EMPLOYEE PARKING, STOCKPILE AREA, WASTE AREA, AND BORROW AREA SHALL BE COORDINATED WITH THE AIRPORT MANAGER.
- 7. THE CONTRACTOR SHALL HAVE AN INDIVIDUAL ON 24-HOUR CALL FOR EMERGENCY MAINTENANCE OF AIRPORT HAZARD LIGHTING. BARRICADES, AND OTHER EMERGENCIES WHICH MAY ARISE AS A RESULT OF WORK.
- 8. THE CONTRACTOR'S PERSONNEL AND EQUIPMENT SHALL NOT BE PERMITTED OUTSIDE THE CONSTRUCTION WORK LIMITS WITHOUT BEING ESCORTED BY THE OWNER-APPROVED ESCORT.
- 9. IT SHALL BE THE RESPONSIBILITY OF THE CONTRACTOR TO REVIEW THE SAFETY PROVISIONS INCORPORATED IN THE FOLLOWING FEDERAL AVIATION ADMINISTRATION (FAA) DOCUMENTS, WHICH ARE AVAILABLE FOR REVIEW BY DOWNLOADING THE DOCUMENTS ON LINE AT HTTP://WWW.FAA.GOV:
- 9.1. ADVISORY CIRCULAR NUMBER 150/5370-10 (LATEST EDITION), "STANDARDS FOR SPECIFYING CONSTRUCTION OF AIRPORTS"
- 9.2. ADVISORY CIRCULAR NUMBER 150/5370-2 (LATEST EDITION), "OPERATIONAL
- SAFETY ON AIRPORTS DURING CONSTRUCTION" 9.3. ADVISORY CIRCULAR NUMBER 150/5210-5-2 (LATEST EDITION), "PAINTING, MARKING, AND LIGHTING OF VEHICLES USED ON AN AIRPORT"
- 10. THE CONTRACTOR SHALL BE REQUIRED TO MINIMIZE DUST CREATED BY CONSTRUCTION ACTIVITIES USING WATER OR OTHER DEVICES. ANY COST ASSOCIATED WITH DUST CONTROL SHALL BE CONSIDERED INCIDENTAL TO THE PROJECT. IN THE EVENT DUST WHICH IS CREATED BY CONSTRUCTION ACTIVITIES BECOMES A HAZARD TO AIRFIELD OPERATIONS AND/OR AIRCRAFT NAVIGATION, CONSTRUCTION ACTIVITIES WILL BE SHUT DOWN. THIS SHUTDOWN TIME WILL NOT BE A BASIS FOR CLAIMS FOR ADDITIONAL CONTRACT TIME OR COMPENSATION.
- 11. AIRCRAFT OPERATIONS SHALL, AT ALL TIMES, HAVE PRIORITY OVER ALL VEHICLES, EQUIPMENT, AND PERSONNEL. THE CONTRACTOR SHALL EMPLOY STRICT MEASURES TO PREVENT ANY CONFLICT BETWEEN CONTRACTOR PERSONNEL AND AIRCRAFT ON ANY ACTIVE AIRFIELD PAVEMENT. THE CONTRACTOR SHALL REMAIN CLEAR OF ACTIVE RUNWAYS AND TAXIWAYS.
- 12. ALL CONTRACTOR VEHICLES, INCLUDING HAULING VEHICLES, THAT ARE AUTHORIZED TO OPERATE ON THE AIRPORT WITHIN THE DESIGNATED LIMITS OF CONSTRUCTION OR HAUL ROUTES AS DEFINED HEREIN, SHALL BE EQUIPPED WITH ROTATING OR FLASHING AMBER LIGHTS. WHEN OPERATING DURING PERIODS OF DARKNESS OR LIMITED VISIBILITY, CONTRACTOR'S VEHICLE SHALL BE EQUIPPED WITH SUCH ROTATING OR FLASHING AMBER LIGHTS, AND HAULING VEHICLES NOT SO EQUIPPED SHALL BE ESCORTED BY A VEHICLE SO EQUIPPED.

- 13. THE CONTRACTOR SHALL CONTROL THE ON-AIRPORT MOVEMENT AND ACTIVITIES OF ITS EMPLOYEES AND SUBCONTRACTORS.
- 14. OPEN-FLAME WELDING OR TORCH-CUTTING OPERATIONS ARE PROHIBITED UNLESS ADEQUATE FIRE AND SAFETY PRECAUTIONS HAVE BEEN APPROVED BY THE OWNER.
- 15. OPEN TRENCHES, EXCAVATIONS AND STOCKPILED MATERIALS AT THE CONSTRUCTION SITE SHALL BE PROMINENTLY MÅRKED WITH ORANGE CONSTRUCTION FENCING WITH BARRELS AND WITH FLASHING AMBER LIGHT UNITS (ACCEPTABLE TO THE OWNER) DURING HOURS OF RESTRICTED VISIBILITY OR DARKNESS.
- 16. STOCKPILED MATERIAL SHALL BE CONSTRAINED IN A MANNER TO PREVENT MOVEMENT AS A RESULT OF AIRCRAFT OR WIND.
- 17. ALL VEHICLES BELONGING TO THE FOREMAN AND SUPERINTENDENT SHALL CONTAIN RADIOS CAPABLE OF TRANSMITTING AND RECEIVING THE UNICOM/CTAF FREQUENCY OF 122.80 MHZ. NORMAL RADIO COMMUNICATIONS BETWEEN CONTRACTOR
- 18. ALL CONSTRUCTION TRAFFIC WHICH CROSSES AIRPORT OPERATIONAL SAFETY AREAS MUST BE CONTROLLED BY FLAGMEN. ALL FLAGMEN CONTROLLING CONSTRUCTION TRAFFIC ACROSS AIRPORT OPERATIONAL AREAS SHALL ALSO BE EQUIPPED WITH A RADIO WHICH WILL OPERATE ON THE UNICOM/CTAF FREQUENCY OF 122.80 MHZ.
- 19. CONTRACTOR TO PROVIDE A MINIMUM OF TWO (2) RADIOS CAPABLE OF OPERATING ON 122.80 MHZ ON THE PROJECT SITE FOR CONTRACTOR USE AT ALL TIMES DURING CONSTRUCTION.
- 20. ANY DAMAGE TO THE EXISTING AIRPORT LIGHTING SYSTEM CAUSED BY CONSTRUCTION OPERATIONS SHALL BE IMMEDIATELY NOTED TO THE OWNER AND REPAIRED BY THE CONTRACTOR AT THE CONTRACTOR'S EXPENSE AND TO THE OWNER'S SPECIFICATIONS.
- 21. DEBRIS, WASTE, AND LOOSE MATERIAL CAPABLE OF CAUSING DAMAGE TO AIRCRAFT LANDING GEAR, PROPELLERS AND ROTORS, OR OF BEING INGESTED BY JET ENGINES SHALL NOT BE LEFT ON ACTIVE AIRCRAFT MOVEMENT AREAS. MATERIAL DROPPED WITHIN THESE AREAS SHALL BE REMOVED CONTINUOUSLY DURING WORKING HOURS.
- 22. THE CONTRACTOR SHALL FURNISH AND INSTALL TEMPORARY REFLECTORIZED SIGNS TO CLEARLY MARK THE DESIGNATED ACCESS ROUTES TO AFFECTED AREAS OF AIRPORT PROPERTY. CONTRACTOR SHALL CONTROL ACCESS TO THE WORKING AREA BY CONSTRUCTION VEHICLES AS DELINEATED ON THIS PLAN. THE COST OF THIS WORK SHALL BE INCIDENTAL TO THE MOBILIZATION LINE ITEM.
- 23. THE CONTRACTOR SHALL BE RESPONSIBLE FOR INFORMING ALL PERSONS UNDER THEIR CONTROL THAT UNAUTHORIZED CONSTRUCTION PERSONNEL FOUND IN RESTRICTED AREAS OF THE AIRPORT SHOWN ON THE SAFETY PLAN ARE SUBJECT TO ARREST FOR A PUNISHABLE FEDERAL OFFENSE AND WILL PROMPTLY AND PERMANENTLY BE REMOVED FROM THE JOB. ALL AREAS INSIDE THE PERIMETER FENCE ARE RESTRICTED. PERSONNEL ARE ONLY AUTHORIZED IN CONSTRUCTION AREAS.
- 24. THE CONTRACTOR SHALL PERFORM CONSTRUCTION OPERATIONS AS NECESSARY TO MINIMIZE ATTRACTION TO BIRDS CAUSED BY PONDED WATER AND GRASS SEED.
- 25. THE CONTRACTOR SHALL PROVIDE, INSTALL, AND MAINTAIN FLASHING LIGHTS AND BARRICADES ALONG AIRCRAFT APRON EDGES OR WHERE TEMPORARY PAVEMENT CLOSURES OR AIRCRAFT LIMITATIONS ARE REQUIRED. BARRICADES SHALL BE PLACED END-TO-END ON CENTER OR AS NOTED ALONG THE AFFECTED PAVEMENT EDGE OR ACROSS THE PAVEMENT OF A CLOSED TAXIWAY. THE CONTRACTOR SHALL DAILY MAINTAIN THE LIGHTS AND BARRICADES IN AN OPERABLE CONDITION FOR THE DURATION OF THE PROJECT. THE CONTRACTOR SHALL FURNISH THE OWNER A CONTACT NUMBER FOR 24- HOUR MAINTENANCE OF LIGHTS AND BARRICADES. THE COST FOR BARRICADES AND LIGHTS SHALL BE INCLUDED IN THE "AIRFIELD BARRICADES" PAY ITEM.
- 26. THE CONTRACTOR SHALL COMPLY WITH ALL SECURITY REQUIREMENTS SPECIFIED HEREIN. THE CONTRACTOR SHALL DESIGNATE IN WRITING TO THE OWNER THE NAME OF ITS "CONTRACTOR SECURITY OFFICER". THE CONTRACTOR'S SECURITY OFFICER SHALL BE RESPONSIBLE FOR BRIEFING ALL CONTRACTOR PERSONNEL ON THESE REQUIREMENTS.
- 27. THE CONTRACTOR'S SECURITY OFFICER SHALL BE RESPONSIBLE FOR BRIEFING ALL CONTRACTOR PERSONNEL ON THESE REQUIREMENTS. CONTRACTOR EMPLOYEES SHALL ATTEND THE OWNER'S SECURITY TRAINING SESSION AND SHALL BE BRIEFED ON THESE REQUIREMENTS PRIOR TO WORKING IN THE CONSTRUCTION AREAS.
- 28. THE CONTRACTOR SHALL ACQUAINT THEIR SUPERVISORS AND EMPLOYEES WITH THE AIRPORT ACTIVITIES AND OPERATIONS THAT ARE INHERENT AT THIS AIRPORT AND SHALL CONDUCT THEIR CONSTRUCTION ACTIVITIES TO CONFORM TO ALL ROUTINE AND EMERGENCY AIR TRAFFIC REQUIREMENTS AND TO THE GUIDELINES ON SAFETY.

- 29. CONTRACTOR TO FIELD VERIFY AND PROTECT ALL EXISTING UTILITIES BEFORE CONSTRUCTION WORK BEGINS.
- 30. ALL LOCATIONS USED FOR HAUL ROUTES, STAGING AREAS, EMPLOYEE PARKING, AND MATERIAL STORAGE SHALL BE RESTORED TO ORIGINAL CONDITION WHEN ALL CONSTRUCTION IS COMPLETED.
- 31. THE CONTRACTOR IS ENCOURAGED TO DOCUMENT VIA PICTURES OR VIDEO THE PRECONSTRUCTION CONDITION OF ALL AIRPORT PAVEMENTS AND STRUCTURES. ANY DAMAGE NOTICED AFTER THE CONTRACTOR'S MOBILIZATION WILL BE ASSUMED TO BE CAUSED BY THE CONTRACTOR TO BE FULLY REPAIRED AT THE CONTRACTOR'S EXPENSE.
- 32. SUFFICIENT SWEEPERS AND CLEAN UP EQUIPMENT SHALL BE PROVIDED IN ORDER THAT ALL LOOSE MATERIAL, DEBRIS, AND MUD CAN BE REMOVED FROM ALL AIRPORT OPERATIONS AREAS ON A CONTINUOUS BASIS.
- 33. GATES AT CONSTRUCTION ENTRANCES SHALL REMAIN CLOSED AND LOCKED AT ALL TIMES WHEN THE ENTRANCE IS NOT IN USE BY CONSTRUCTION PERSONNEL. GATES TO BE MANNED BY CONTRACTOR

THE PART 77 SECTION VIEW IS CENTERED ON THE RUNWAY CENTERLINE AT THE

CENTERLINE ELEVATION, AND ON THE EXTENDED RUNWAY CENTERLINE AT THE

THE SECTION THEN RISES ALONG THE SLOPE INDICATED ON THE PROFILE VIEW.

R/W 18-36

CENTERLINE OF THE AREA LISTED.

*ALL DISTANCES ARE CENTERED ABOUT THE

SAFETY AREA DIMENSIONS

RUNWAY THRESHOLD ELEVATION TO A POINT 200 FEET BEYOND EACH THRESHOLD.

PERSONNEL WHEN OPEN.

- 34. CONTRACTOR SHALL SUBMIT MSCAA & FAA UTILITY LOCATE REQUEST FORM PRIOR TO EXECUTION.
- 35. CONTRACTOR SHALL PREPARE A SAFETY PLAN COMPLIANCE DOCUMENT (SPCD) THAT DETAIL HOW THE CONTRACTOR WILL COMPLY WITH THE CONSTRUCTION SAFETY & PHASING PLAN (CSPP). THE SPCD MUST BE APPROVED BY THE AIRPORT OPERATOR PRIOR TO THE ISSUANCE OF A NOTICE TO



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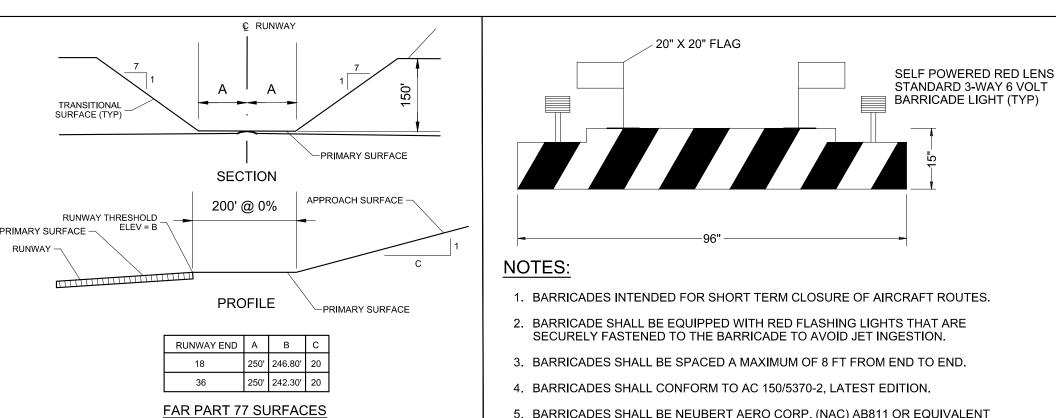
LOCAL EMERGENCY PHONE NUMBERS EMERGENCY: 911 MILLINGTON POLICE DEPT: (901) 872-3333 FIRE DEPARTMENT: (901) 873-5800 AIRPORT: (901) 358-0028 MEDICAL: (901) 516-5200

UTILITY CONTACTS

LIQUIDATED DAMAGES \$2,000 PER CALENDAR DAY

MLGW: (901) 528-4270

CONTRACT TIME 21 CALENDAR DAYS



- 5. BARRICADES SHALL BE NEUBERT AERO CORP. (NAC) AB811 OR EQUIVALENT AS APPROVED BY THE ENGINEER.
- 6. FILL BARRICADE BASE WITH WATER OR SAND TO ADD ADDITIONAL WEIGHT.
- 7. CONTRACTOR TO FURNISH, INSTALL, AND MAINTAIN BARRICADES THROUGHOUT THE DURATION OF THE PROJECT.
- 8. BARRICADES SHALL BE PAID FOR UNDER C-105-6.2.

8' SAFETY BARRICADE

N.T.S.

o Sirio

ROGRAM MANAGER

BARGE BARGE DESIGN SOLUTIONS, INC

65 GERMANTOWN CT, SUITE 100

MEMPHIS, TN 38018 33276-02

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REVISIONS DESCRIPTION ISSUED FOR BID

MSCAA PROJ. NO. 18-1420-01


CHARLES BAKER PAVEMENT RECONSTRUCTION

SHEET TITLE:

CONSTRUCTION SAFETY & PHASING PLAN (AREA 4)

DWG. FILE NAME 3327602-14C-SF-04.DWG

C-SF-04 03/11/2024 "=200"

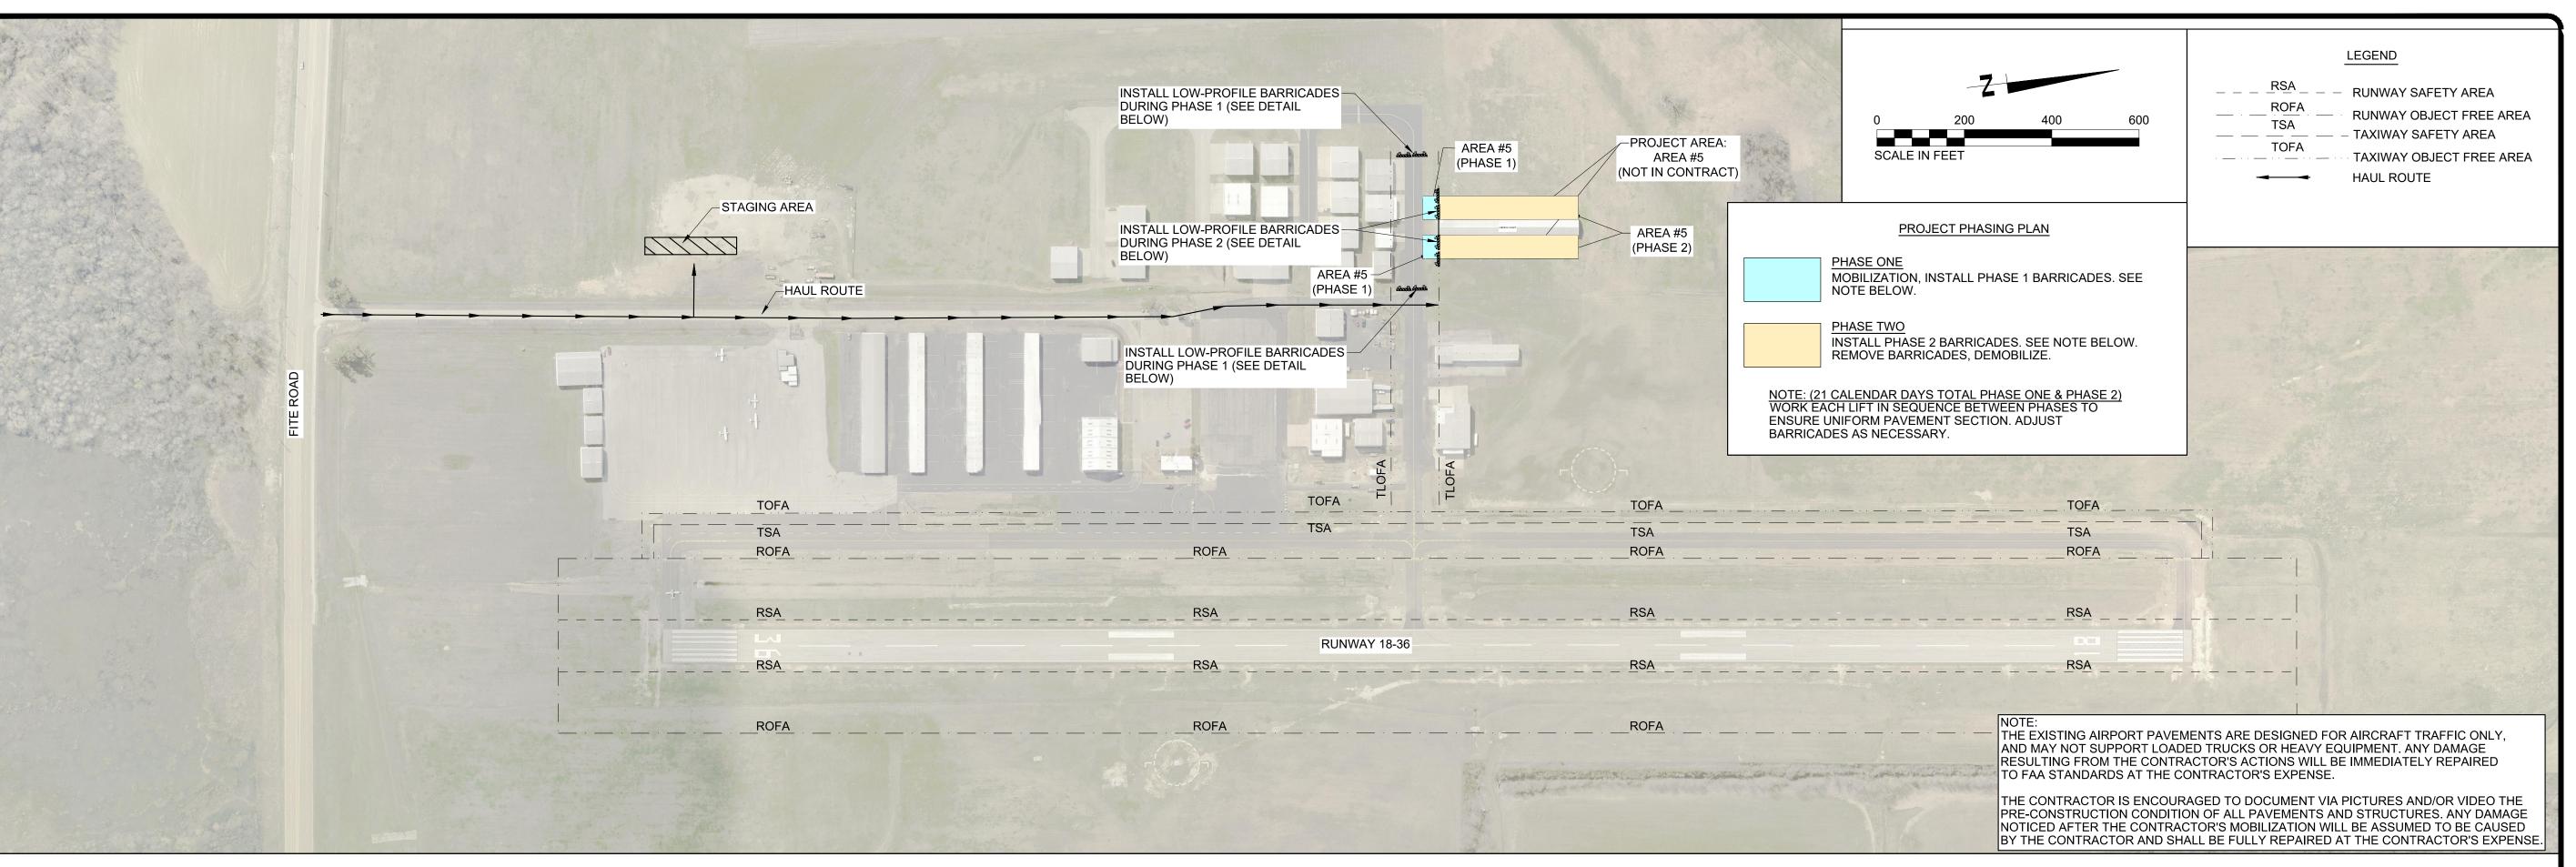

- 1. IT SHALL BE THE RESPONSIBILITY OF THE CONTRACTOR TO NOTIFY THE ENGINEER AND THE OWNER NO LESS THAN TWO (2) DAYS PRIOR TO ENTERING THE CONSTRUCTION SITE FOR ANY PURPOSE SO THAT THEY MAY PUBLISH "NOTICES TO AIR MISSIONS" (NOTAM) OF THE CONSTRUCTION ACTIVITIES.
- 2. AIRPORT OPERATION SAFETY AREAS ARE DEFINED AS FOLLOWS:
- 2.1. RUNWAY 18-36 RSA 60 FEET FROM THE CENTERLINE OF PAVEMENT AND 240 FEET
- BEYOND RUNWAY END. (RSA) 2.2. RUNWAY 18-36 OFA - 200 FEET FROM THE CENTERLINE OF PAVEMENT AND 240 FEET BEYOND RUNWAY END. (ROFA)
- 2.3. TAXIWAY SAFETY AREA 39.5' FROM CENTERLINE OF PAVEMENT. (TSA)
- 2.4. TAXIWAY OBJECT FREE AREA 62' FROM CENTERLINE OF PAVEMENT. (TOFA) 2.4. TAXILANE OBJECT FREE AREA - 55' FROM CENTERLINE OF PAVEMENT. (TLOFA)
- 3. NO SEPARATE MEASUREMENT OR PAYMENT WILL BE MADE FOR RADIOS, CONSTRUCTION OF AND MAINTENANCE OF HAUL ROUTES AND CONSTRUCTION ENTRANCE, ETC. AS INCLUDED IN THESE NOTES. ALL COSTS ASSOCIATED WITH THESE ITEMS MUST BE INCLUDED IN THE CONTRACT BID PRICES WHICH WOULD MOST LIKELY INCLUDE THEM.
- 4. THE CONTRACTOR AND PERSONNEL SHALL NOT, AT ANY TIME, BE ON THE RUNWAY, TAXIWAYS, OR MAIN APRON UNLESS THE AIRPORT MANAGER GIVES PRIOR APPROVAL.
- 5. THE CONTRACTOR SHALL TAKE EXTREME CAUTION AROUND ALL EXISTING AIRPORT EQUIPMENT.
- 6. THE CONSTRUCTION ENTRANCE, STAGING AREA, EMPLOYEE PARKING, STOCKPILE AREA, WASTE AREA, AND BORROW AREA SHALL BE COORDINATED WITH THE AIRPORT MANAGER.
- 7. THE CONTRACTOR SHALL HAVE AN INDIVIDUAL ON 24-HOUR CALL FOR EMERGENCY MAINTENANCE OF AIRPORT HAZARD LIGHTING. BARRICADES, AND OTHER EMERGENCIES WHICH MAY ARISE AS A RESULT OF WORK.
- 8. THE CONTRACTOR'S PERSONNEL AND EQUIPMENT SHALL NOT BE PERMITTED OUTSIDE THE CONSTRUCTION WORK LIMITS WITHOUT BEING ESCORTED BY THE OWNER-APPROVED ESCORT.
- 9. IT SHALL BE THE RESPONSIBILITY OF THE CONTRACTOR TO REVIEW THE SAFETY PROVISIONS INCORPORATED IN THE FOLLOWING FEDERAL AVIATION ADMINISTRATION (FAA) DOCUMENTS, WHICH ARE AVAILABLE FOR REVIEW BY DOWNLOADING THE DOCUMENTS ON LINE AT HTTP://WWW.FAA.GOV:
- 9.1. ADVISORY CIRCULAR NUMBER 150/5370-10 (LATEST EDITION), "STANDARDS FOR SPECIFYING CONSTRUCTION OF AIRPORTS"
- 9.2. ADVISORY CIRCULAR NUMBER 150/5370-2 (LATEST EDITION), "OPERATIONAL

SAFETY ON AIRPORTS DURING CONSTRUCTION"

- 9.3. ADVISORY CIRCULAR NUMBER 150/5210-5-2 (LATEST EDITION), "PAINTING, MARKING, AND LIGHTING OF VEHICLES USED ON AN AIRPORT"
- 10. THE CONTRACTOR SHALL BE REQUIRED TO MINIMIZE DUST CREATED BY CONSTRUCTION ACTIVITIES USING WATER OR OTHER DEVICES. ANY COST ASSOCIATED WITH DUST CONTROL SHALL BE CONSIDERED INCIDENTAL TO THE PROJECT. IN THE EVENT DUST WHICH IS CREATED BY CONSTRUCTION ACTIVITIES BECOMES A HAZARD TO AIRFIELD OPERATIONS AND/OR AIRCRAFT NAVIGATION, CONSTRUCTION ACTIVITIES WILL BE SHUT DOWN. THIS SHUTDOWN TIME WILL NOT BE A BASIS FOR CLAIMS FOR ADDITIONAL CONTRACT TIME OR COMPENSATION.
- 11. AIRCRAFT OPERATIONS SHALL, AT ALL TIMES, HAVE PRIORITY OVER ALL VEHICLES, EQUIPMENT, AND PERSONNEL. THE CONTRACTOR SHALL EMPLOY STRICT MEASURES TO PREVENT ANY CONFLICT BETWEEN CONTRACTOR PERSONNEL AND AIRCRAFT ON ANY ACTIVE AIRFIELD PAVEMENT. THE CONTRACTOR SHALL REMAIN CLEAR OF ACTIVE RUNWAYS AND TAXIWAYS.
- 12. ALL CONTRACTOR VEHICLES, INCLUDING HAULING VEHICLES, THAT ARE AUTHORIZED TO OPERATE ON THE AIRPORT WITHIN THE DESIGNATED LIMITS OF CONSTRUCTION OR HAUL ROUTES AS DEFINED HEREIN, SHALL BE EQUIPPED WITH ROTATING OR FLASHING AMBER LIGHTS. WHEN OPERATING DURING PERIODS OF DARKNESS OR LIMITED VISIBILITY, CONTRACTOR'S VEHICLE SHALL BE EQUIPPED WITH SUCH ROTATING OR FLASHING AMBER LIGHTS, AND HAULING VEHICLES NOT SO EQUIPPED SHALL BE ESCORTED BY A VEHICLE SO EQUIPPED.

- 13. THE CONTRACTOR SHALL CONTROL THE ON-AIRPORT MOVEMENT AND ACTIVITIES OF ITS EMPLOYEES AND SUBCONTRACTORS.
- 14. OPEN-FLAME WELDING OR TORCH-CUTTING OPERATIONS ARE PROHIBITED UNLESS ADEQUATE FIRE AND SAFETY PRECAUTIONS HAVE BEEN APPROVED BY THE OWNER.
- 15. OPEN TRENCHES, EXCAVATIONS AND STOCKPILED MATERIALS AT THE CONSTRUCTION SITE SHALL BE PROMINENTLY MARKED WITH ORANGE CONSTRUCTION FENCING WITH BARRELS AND WITH FLASHING AMBER LIGHT UNITS (ACCEPTABLE TO THE OWNER) DURING HOURS OF RESTRICTED VISIBILITY OR DARKNESS.
- 16. STOCKPILED MATERIAL SHALL BE CONSTRAINED IN A MANNER TO PREVENT MOVEMENT AS A RESULT OF AIRCRAFT OR WIND.
- 17. ALL VEHICLES BELONGING TO THE FOREMAN AND SUPERINTENDENT SHALL CONTAIN RADIOS CAPABLE OF TRANSMITTING AND RECEIVING THE UNICOM/CTAF FREQUENCY OF 122.80 MHZ. NORMAL RADIO COMMUNICATIONS BETWEEN CONTRACTOR
- 18. ALL CONSTRUCTION TRAFFIC WHICH CROSSES AIRPORT OPERATIONAL SAFETY AREAS MUST BE CONTROLLED BY FLAGMEN. ALL FLAGMEN CONTROLLING CONSTRUCTION TRAFFIC ACROSS AIRPORT OPERATIONAL AREAS SHALL ALSO BE EQUIPPED WITH A RADIO WHICH WILL OPERATE ON THE UNICOM/CTAF FREQUENCY OF 122.80 MHZ.
- 19. CONTRACTOR TO PROVIDE A MINIMUM OF TWO (2) RADIOS CAPABLE OF OPERATING ON 122.80 MHZ ON THE PROJECT SITE FOR CONTRACTOR USE AT ALL TIMES DURING CONSTRUCTION.
- 20. ANY DAMAGE TO THE EXISTING AIRPORT LIGHTING SYSTEM CAUSED BY CONSTRUCTION OPERATIONS SHALL BE IMMEDIATELY NOTED TO THE OWNER AND REPAIRED BY THE CONTRACTOR AT THE CONTRACTOR'S EXPENSE AND TO THE OWNER'S SPECIFICATIONS.
- 21. DEBRIS, WASTE, AND LOOSE MATERIAL CAPABLE OF CAUSING DAMAGE TO AIRCRAFT LANDING GEAR, PROPELLERS AND ROTORS, OR OF BEING INGESTED BY JET ENGINES SHALL NOT BE LEFT ON ACTIVE AIRCRAFT MOVEMENT AREAS. MATERIAL DROPPED WITHIN THESE AREAS SHALL BE REMOVED CONTINUOUSLY DURING WORKING HOURS.
- 22. THE CONTRACTOR SHALL FURNISH AND INSTALL TEMPORARY REFLECTORIZED SIGNS TO CLEARLY MARK THE DESIGNATED ACCESS ROUTES TO AFFECTED AREAS OF AIRPORT PROPERTY. CONTRACTOR SHALL CONTROL ACCESS TO THE WORKING AREA BY CONSTRUCTION VEHICLES AS DELINEATED ON THIS PLAN. THE COST OF THIS WORK SHALL BE INCIDENTAL TO THE MOBILIZATION LINE ITEM.
- 23. THE CONTRACTOR SHALL BE RESPONSIBLE FOR INFORMING ALL PERSONS UNDER THEIR CONTROL THAT UNAUTHORIZED CONSTRUCTION PERSONNEL FOUND IN RESTRICTED AREAS OF THE AIRPORT SHOWN ON THE SAFETY PLAN ARE SUBJECT TO ARREST FOR A PUNISHABLE FEDERAL OFFENSE AND WILL PROMPTLY AND PERMANENTLY BE REMOVED FROM THE JOB. ALL AREAS INSIDE THE PERIMETER FENCE ARE RESTRICTED. PERSONNEL ARE ONLY AUTHORIZED IN CONSTRUCTION AREAS.
- 24. THE CONTRACTOR SHALL PERFORM CONSTRUCTION OPERATIONS AS NECESSARY TO MINIMIZE ATTRACTION TO BIRDS CAUSED BY PONDED WATER AND GRASS SEED.
- 25. THE CONTRACTOR SHALL PROVIDE, INSTALL, AND MAINTAIN FLASHING LIGHTS AND BARRICADES ALONG AIRCRAFT APRON EDGES OR WHERE TEMPORARY PAVEMENT CLOSURES OR AIRCRAFT LIMITATIONS ARE REQUIRED. BARRICADES SHALL BE PLACED END-TO-END ON CENTER OR AS NOTED ALONG THE AFFECTED PAVEMENT EDGE OR ACROSS THE PAVEMENT OF A CLOSED TAXIWAY. THE CONTRACTOR SHALL DAILY MAINTAIN THE LIGHTS AND BARRICADES IN AN OPERABLE CONDITION FOR THE DURATION OF THE PROJECT. THE CONTRACTOR SHALL FURNISH THE OWNER A CONTACT NUMBER FOR 24- HOUR MAINTENANCE OF LIGHTS AND BARRICADES. THE COST FOR BARRICADES AND LIGHTS SHALL BE INCLUDED IN THE "AIRFIELD BARRICADES" PAY ITEM.
- 26. THE CONTRACTOR SHALL COMPLY WITH ALL SECURITY REQUIREMENTS SPECIFIED HEREIN. THE CONTRACTOR SHALL DESIGNATE IN WRITING TO THE OWNER THE NAME OF ITS "CONTRACTOR SECURITY OFFICER". THE CONTRACTOR'S SECURITY OFFICER SHALL BE RESPONSIBLE FOR BRIEFING ALL CONTRACTOR PERSONNEL ON THESE REQUIREMENTS.
- 27. THE CONTRACTOR'S SECURITY OFFICER SHALL BE RESPONSIBLE FOR BRIEFING ALL CONTRACTOR PERSONNEL ON THESE REQUIREMENTS. CONTRACTOR EMPLOYEES SHALL ATTEND THE OWNER'S SECURITY TRAINING SESSION AND SHALL BE BRIEFED ON THESE REQUIREMENTS PRIOR TO WORKING IN THE CONSTRUCTION AREAS.
- 28. THE CONTRACTOR SHALL ACQUAINT THEIR SUPERVISORS AND EMPLOYEES WITH THE AIRPORT ACTIVITIES AND OPERATIONS THAT ARE INHERENT AT THIS AIRPORT AND SHALL CONDUCT THEIR CONSTRUCTION ACTIVITIES TO CONFORM TO ALL ROUTINE AND EMERGENCY AIR TRAFFIC REQUIREMENTS AND TO THE GUIDELINES ON SAFETY.

- 29. CONTRACTOR TO FIELD VERIFY AND PROTECT ALL EXISTING UTILITIES BEFORE CONSTRUCTION WORK BEGINS.
- 30. ALL LOCATIONS USED FOR HAUL ROUTES, STAGING AREAS, EMPLOYEE PARKING, AND MATERIAL STORAGE SHALL BE RESTORED TO ORIGINAL CONDITION WHEN ALL CONSTRUCTION IS COMPLETED.
- 31. THE CONTRACTOR IS ENCOURAGED TO DOCUMENT VIA PICTURES OR VIDEO THE PRECONSTRUCTION CONDITION OF ALL AIRPORT PAVEMENTS AND STRUCTURES. ANY DAMAGE NOTICED AFTER THE CONTRACTOR'S MOBILIZATION WILL BE ASSUMED TO BE CAUSED BY THE CONTRACTOR TO BE FULLY REPAIRED AT THE CONTRACTOR'S EXPENSE.
- 32. SUFFICIENT SWEEPERS AND CLEAN UP EQUIPMENT SHALL BE PROVIDED IN ORDER THAT ALL LOOSE MATERIAL, DEBRIS, AND MUD CAN BE REMOVED FROM ALL AIRPORT OPERATIONS AREAS ON A
- CONTINUOUS BASIS. 33. GATES AT CONSTRUCTION ENTRANCES SHALL REMAIN CLOSED AND LOCKED AT ALL TIMES WHEN THE ENTRANCE IS NOT IN USE BY CONSTRUCTION PERSONNEL. GATES TO BE MANNED BY CONTRACTOR
- 34. CONTRACTOR SHALL SUBMIT MSCAA & FAA UTILITY LOCATE REQUEST FORM PRIOR TO EXECUTION.
- 35. CONTRACTOR SHALL PREPARE A SAFETY PLAN COMPLIANCE DOCUMENT (SPCD) THAT DETAIL HOW THE CONTRACTOR WILL COMPLY WITH THE CONSTRUCTION SAFETY & PHASING PLAN (CSPP). THE SPCD MUST BE APPROVED BY THE AIRPORT OPERATOR PRIOR TO THE ISSUANCE OF A NOTICE TO



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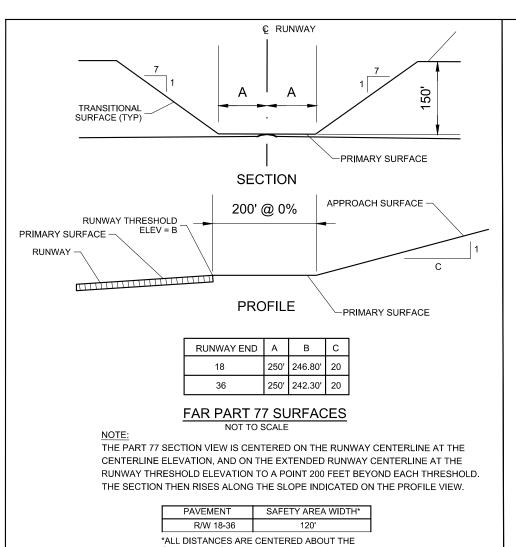
UTILITY CONTACTS

LIQUIDATED DAMAGES

\$2,000 PER CALENDAR DAY

MLGW: (901) 528-4270


CONTRACT TIME 21 CALENDAR DAYS



CENTERLINE OF THE AREA LISTED.

SAFETY AREA DIMENSIONS

PERSONNEL WHEN OPEN.

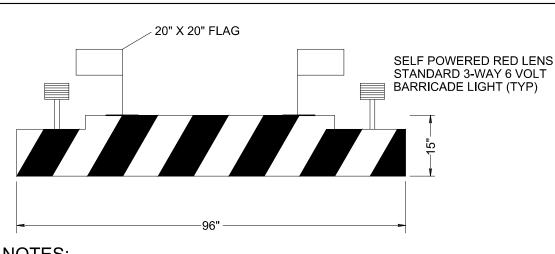

NOTES:

- 1. BARRICADES INTENDED FOR SHORT TERM CLOSURE OF AIRCRAFT ROUTES.
- 2. BARRICADE SHALL BE EQUIPPED WITH RED FLASHING LIGHTS THAT ARE SECURELY FASTENED TO THE BARRICADE TO AVOID JET INGESTION.
- 3. BARRICADES SHALL BE SPACED A MAXIMUM OF 8 FT FROM END TO END.
- 4. BARRICADES SHALL CONFORM TO AC 150/5370-2, LATEST EDITION.
- 5. BARRICADES SHALL BE NEUBERT AERO CORP. (NAC) AB811 OR EQUIVALENT AS APPROVED BY THE ENGINEER.

6. FILL BARRICADE BASE WITH WATER OR SAND TO ADD ADDITIONAL WEIGHT.

- 7. CONTRACTOR TO FURNISH, INSTALL, AND MAINTAIN BARRICADES THROUGHOUT
- THE DURATION OF THE PROJECT.
- 8. BARRICADES SHALL BE PAID FOR UNDER C-105-6.2.

8' SAFETY BARRICADE

N.T.S.



ROGRAM MANAGER

BARGE BARGE DESIGN SOLUTIONS, INC

65 GERMANTOWN CT, SUITE 100

33276-02

MEMPHIS, TN 38018

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MSCAA PROJ. NO.

18-1420-01

CHARLES BAKER PAVEMENT RECONSTRUCTION


SHEET TITLE:

CONSTRUCTION SAFETY & PHASING PLAN (AREA 5)

DWG. FILE NAME 3327602-15C-SF-05.DWG

03/11/2024

C-SF-05 "=200"

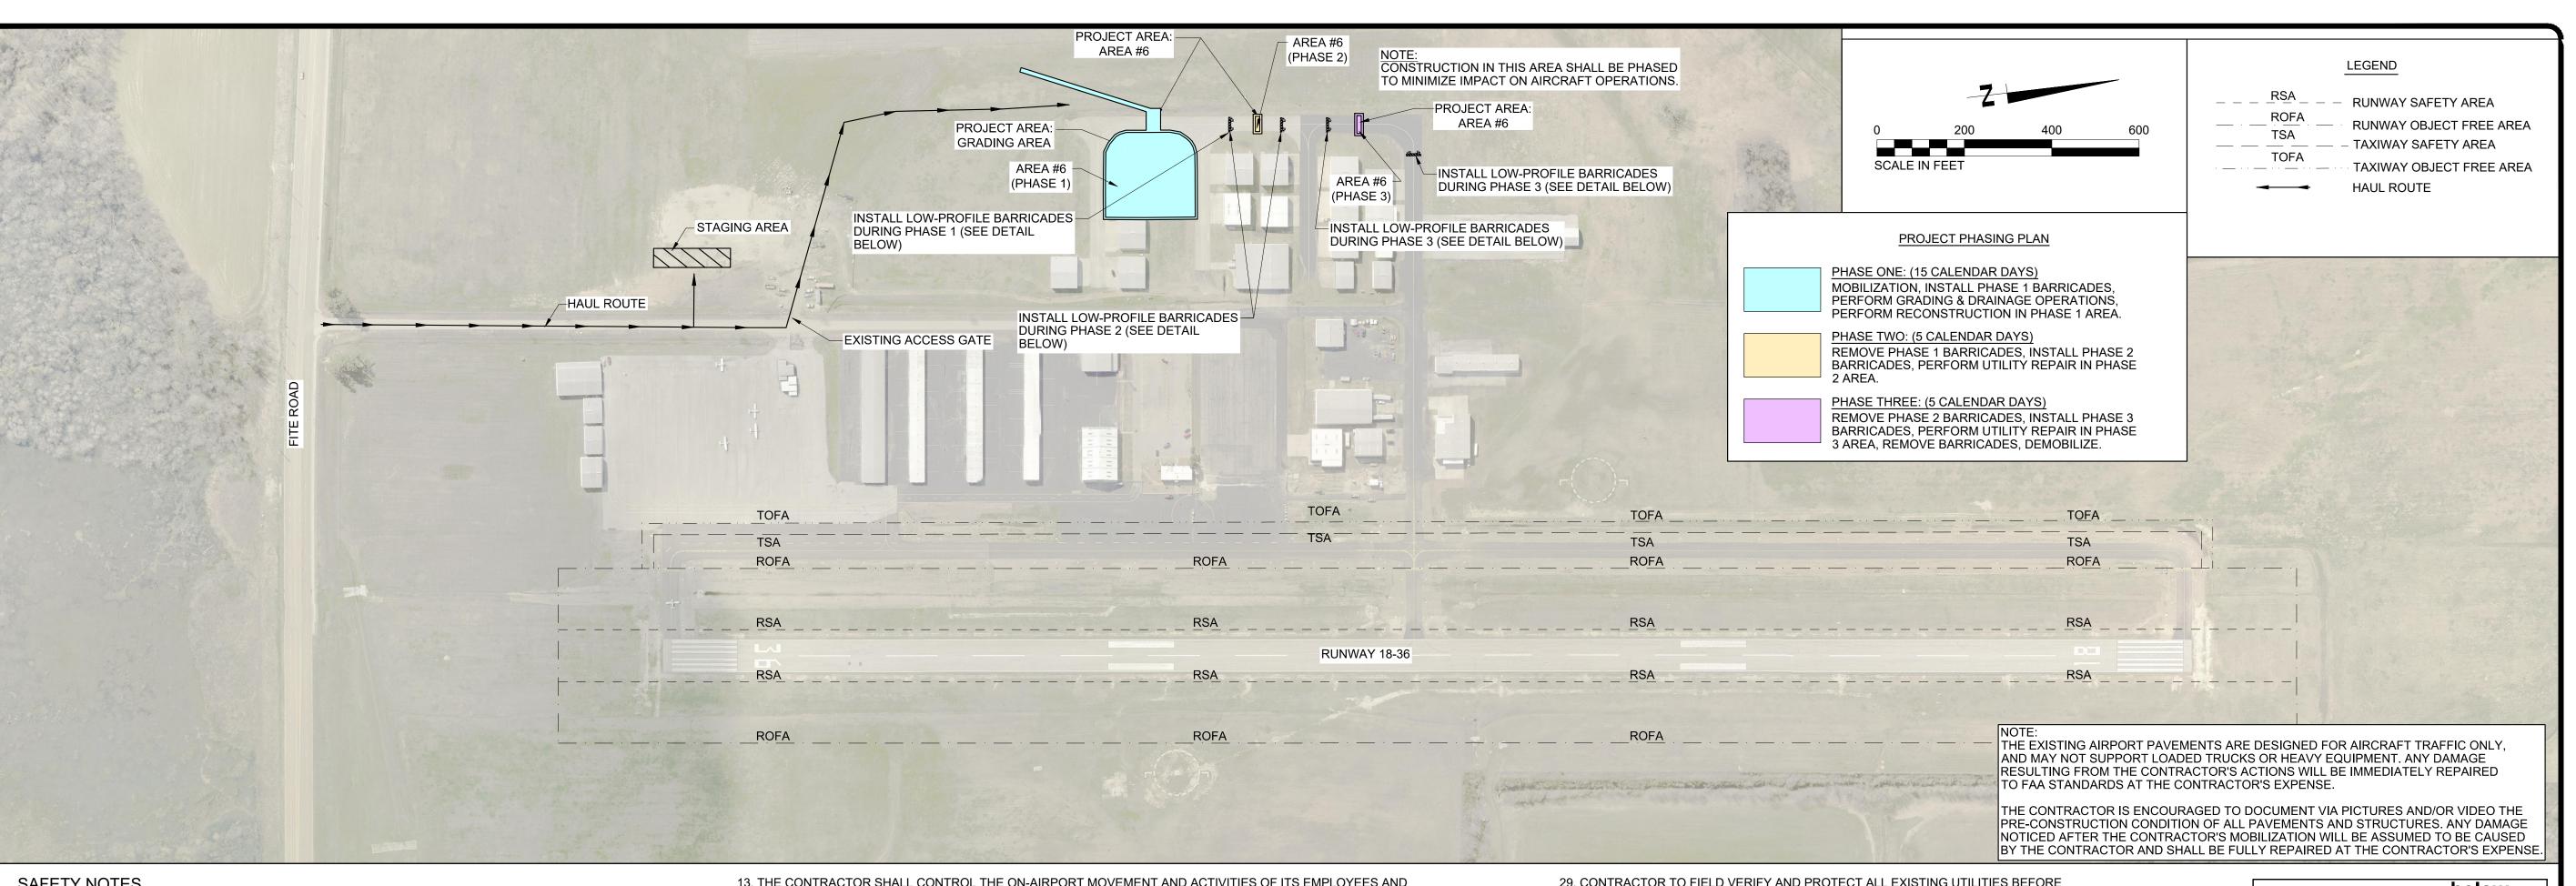

- 1. IT SHALL BE THE RESPONSIBILITY OF THE CONTRACTOR TO NOTIFY THE ENGINEER AND THE OWNER NO LESS THAN TWO (2) DAYS PRIOR TO ENTERING THE CONSTRUCTION SITE FOR ANY PURPOSE SO THAT THEY MAY PUBLISH "NOTICES TO AIR MISSIONS" (NOTAM) OF THE CONSTRUCTION ACTIVITIES.
- 2. AIRPORT OPERATION SAFETY AREAS ARE DEFINED AS FOLLOWS:
- 2.1. RUNWAY 18-36 RSA 60 FEET FROM THE CENTERLINE OF PAVEMENT AND 240 FEET
- BEYOND RUNWAY END. (RSA) 2.2. RUNWAY 18-36 OFA - 200 FEET FROM THE CENTERLINE OF PAVEMENT AND 240 FEET BEYOND RUNWAY END. (ROFA)
- 2.3. TAXIWAY SAFETY AREA 39.5' FROM CENTERLINE OF PAVEMENT. (TSA)
- 2.4. TAXIWAY OBJECT FREE AREA 62' FROM CENTERLINE OF PAVEMENT. (TOFA) 2.4. TAXILANE OBJECT FREE AREA - 55' FROM CENTERLINE OF PAVEMENT. (TLOFA)
- 3. NO SEPARATE MEASUREMENT OR PAYMENT WILL BE MADE FOR RADIOS, CONSTRUCTION OF AND MAINTENANCE OF HAUL ROUTES AND CONSTRUCTION ENTRANCE, ETC. AS INCLUDED IN THESE NOTES. ALL COSTS ASSOCIATED WITH THESE ITEMS MUST BE INCLUDED IN THE CONTRACT BID PRICES WHICH WOULD MOST LIKELY INCLUDE THEM.
- 4. THE CONTRACTOR AND PERSONNEL SHALL NOT, AT ANY TIME, BE ON THE RUNWAY, TAXIWAYS, OR MAIN APRON UNLESS THE AIRPORT MANAGER GIVES PRIOR APPROVAL.
- 5. THE CONTRACTOR SHALL TAKE EXTREME CAUTION AROUND ALL EXISTING AIRPORT EQUIPMENT.
- 6. THE CONSTRUCTION ENTRANCE, STAGING AREA, EMPLOYEE PARKING, STOCKPILE AREA, WASTE AREA, AND BORROW AREA SHALL BE COORDINATED WITH THE AIRPORT MANAGER.
- 7. THE CONTRACTOR SHALL HAVE AN INDIVIDUAL ON 24-HOUR CALL FOR EMERGENCY MAINTENANCE OF AIRPORT HAZARD LIGHTING. BARRICADES, AND OTHER EMERGENCIES WHICH MAY ARISE AS A RESULT OF WORK.
- 8. THE CONTRACTOR'S PERSONNEL AND EQUIPMENT SHALL NOT BE PERMITTED OUTSIDE THE CONSTRUCTION WORK LIMITS WITHOUT BEING ESCORTED BY THE OWNER-APPROVED ESCORT.
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- 9.2. ADVISORY CIRCULAR NUMBER 150/5370-2 (LATEST EDITION), "OPERATIONAL

CONTRACT TIME OR COMPENSATION.

- SAFETY ON AIRPORTS DURING CONSTRUCTION" 9.3. ADVISORY CIRCULAR NUMBER 150/5210-5-2 (LATEST EDITION), "PAINTING, MARKING, AND LIGHTING OF VEHICLES USED ON AN AIRPORT"
- 10. THE CONTRACTOR SHALL BE REQUIRED TO MINIMIZE DUST CREATED BY CONSTRUCTION ACTIVITIES USING WATER OR OTHER DEVICES. ANY COST ASSOCIATED WITH DUST CONTROL SHALL BE CONSIDERED INCIDENTAL TO THE PROJECT. IN THE EVENT DUST WHICH IS CREATED BY CONSTRUCTION ACTIVITIES BECOMES A HAZARD TO AIRFIELD OPERATIONS AND/OR AIRCRAFT NAVIGATION, CONSTRUCTION ACTIVITIES

WILL BE SHUT DOWN. THIS SHUTDOWN TIME WILL NOT BE A BASIS FOR CLAIMS FOR ADDITIONAL

- 11. AIRCRAFT OPERATIONS SHALL, AT ALL TIMES, HAVE PRIORITY OVER ALL VEHICLES, EQUIPMENT, AND PERSONNEL. THE CONTRACTOR SHALL EMPLOY STRICT MEASURES TO PREVENT ANY CONFLICT BETWEEN CONTRACTOR PERSONNEL AND AIRCRAFT ON ANY ACTIVE AIRFIELD PAVEMENT. THE CONTRACTOR SHALL REMAIN CLEAR OF ACTIVE RUNWAYS AND TAXIWAYS.
- 12. ALL CONTRACTOR VEHICLES, INCLUDING HAULING VEHICLES, THAT ARE AUTHORIZED TO OPERATE ON THE AIRPORT WITHIN THE DESIGNATED LIMITS OF CONSTRUCTION OR HAUL ROUTES AS DEFINED HEREIN, SHALL BE EQUIPPED WITH ROTATING OR FLASHING AMBER LIGHTS. WHEN OPERATING DURING PERIODS OF DARKNESS OR LIMITED VISIBILITY, CONTRACTOR'S VEHICLE SHALL BE EQUIPPED WITH SUCH ROTATING OR FLASHING AMBER LIGHTS, AND HAULING VEHICLES NOT SO EQUIPPED SHALL BE ESCORTED BY A VEHICLE SO EQUIPPED.

- 13. THE CONTRACTOR SHALL CONTROL THE ON-AIRPORT MOVEMENT AND ACTIVITIES OF ITS EMPLOYEES AND SUBCONTRACTORS.
- 14. OPEN-FLAME WELDING OR TORCH-CUTTING OPERATIONS ARE PROHIBITED UNLESS ADEQUATE FIRE AND SAFETY PRECAUTIONS HAVE BEEN APPROVED BY THE OWNER.
- 15. OPEN TRENCHES. EXCAVATIONS AND STOCKPILED MATERIALS AT THE CONSTRUCTION SITE SHALL BE PROMINENTLY MARKED WITH ORANGE CONSTRUCTION FENCING WITH BARRELS AND WITH FLASHING AMBER LIGHT UNITS (ACCEPTABLE TO THE OWNER) DURING HOURS OF RESTRICTED VISIBILITY OR DARKNESS.
- 16. STOCKPILED MATERIAL SHALL BE CONSTRAINED IN A MANNER TO PREVENT MOVEMENT AS A RESULT OF AIRCRAFT OR WIND.
- 17. ALL VEHICLES BELONGING TO THE FOREMAN AND SUPERINTENDENT SHALL CONTAIN RADIOS CAPABLE OF TRANSMITTING AND RECEIVING THE UNICOM/CTAF FREQUENCY OF 122.80 MHZ. NORMAL RADIO COMMUNICATIONS BETWEEN CONTRACTOR
- 18. ALL CONSTRUCTION TRAFFIC WHICH CROSSES AIRPORT OPERATIONAL SAFETY AREAS MUST BE CONTROLLED BY FLAGMEN. ALL FLAGMEN CONTROLLING CONSTRUCTION TRAFFIC ACROSS AIRPORT OPERATIONAL AREAS SHALL ALSO BE EQUIPPED WITH A RADIO WHICH WILL OPERATE ON THE UNICOM/CTAF FREQUENCY OF 122.80 MHZ.
- 19. CONTRACTOR TO PROVIDE A MINIMUM OF TWO (2) RADIOS CAPABLE OF OPERATING ON 122.80 MHZ ON THE PROJECT SITE FOR CONTRACTOR USE AT ALL TIMES DURING CONSTRUCTION.
- 20. ANY DAMAGE TO THE EXISTING AIRPORT LIGHTING SYSTEM CAUSED BY CONSTRUCTION OPERATIONS SHALL BE IMMEDIATELY NOTED TO THE OWNER AND REPAIRED BY THE CONTRACTOR AT THE CONTRACTOR'S EXPENSE AND TO THE OWNER'S SPECIFICATIONS.
- 21. DEBRIS, WASTE, AND LOOSE MATERIAL CAPABLE OF CAUSING DAMAGE TO AIRCRAFT LANDING GEAR, PROPELLERS AND ROTORS, OR OF BEING INGESTED BY JET ENGINES SHALL NOT BE LEFT ON ACTIVE AIRCRAFT MOVEMENT AREAS. MATERIAL DROPPED WITHIN THESE AREAS SHALL BE REMOVED CONTINUOUSLY DURING WORKING HOURS.
- 22. THE CONTRACTOR SHALL FURNISH AND INSTALL TEMPORARY REFLECTORIZED SIGNS TO CLEARLY MARK THE DESIGNATED ACCESS ROUTES TO AFFECTED AREAS OF AIRPORT PROPERTY. CONTRACTOR SHALL CONTROL ACCESS TO THE WORKING AREA BY CONSTRUCTION VEHICLES AS DELINEATED ON THIS PLAN. THE COST OF THIS WORK SHALL BE INCIDENTAL TO THE MOBILIZATION LINE ITEM.
- 23. THE CONTRACTOR SHALL BE RESPONSIBLE FOR INFORMING ALL PERSONS UNDER THEIR CONTROL THAT UNAUTHORIZED CONSTRUCTION PERSONNEL FOUND IN RESTRICTED AREAS OF THE AIRPORT SHOWN ON THE SAFETY PLAN ARE SUBJECT TO ARREST FOR A PUNISHABLE FEDERAL OFFENSE AND WILL PROMPTLY AND PERMANENTLY BE REMOVED FROM THE JOB. ALL AREAS INSIDE THE PERIMETER FENCE ARE RESTRICTED. PERSONNEL ARE ONLY AUTHORIZED IN CONSTRUCTION AREAS.
- 24. THE CONTRACTOR SHALL PERFORM CONSTRUCTION OPERATIONS AS NECESSARY TO MINIMIZE ATTRACTION TO BIRDS CAUSED BY PONDED WATER AND GRASS SEED.
- 25. THE CONTRACTOR SHALL PROVIDE, INSTALL, AND MAINTAIN FLASHING LIGHTS AND BARRICADES ALONG AIRCRAFT APRON EDGES OR WHERE TEMPORARY PAVEMENT CLOSURES OR AIRCRAFT LIMITATIONS ARE REQUIRED. BARRICADES SHALL BE PLACED END-TO-END ON CENTER OR AS NOTED ALONG THE AFFECTED PAVEMENT EDGE OR ACROSS THE PAVEMENT OF A CLOSED TAXIWAY. THE CONTRACTOR SHALL DAILY MAINTAIN THE LIGHTS AND BARRICADES IN AN OPERABLE CONDITION FOR THE DURATION OF THE PROJECT. THE CONTRACTOR SHALL FURNISH THE OWNER A CONTACT NUMBER FOR 24- HOUR MAINTENANCE OF LIGHTS AND BARRICADES. THE COST FOR BARRICADES AND LIGHTS SHALL BE INCLUDED IN THE "AIRFIELD BARRICADES" PAY ITEM.
- 26. THE CONTRACTOR SHALL COMPLY WITH ALL SECURITY REQUIREMENTS SPECIFIED HEREIN. THE CONTRACTOR SHALL DESIGNATE IN WRITING TO THE OWNER THE NAME OF ITS "CONTRACTOR SECURITY OFFICER". THE CONTRACTOR'S SECURITY OFFICER SHALL BE RESPONSIBLE FOR BRIEFING ALL CONTRACTOR PERSONNEL ON THESE REQUIREMENTS.
- 27. THE CONTRACTOR'S SECURITY OFFICER SHALL BE RESPONSIBLE FOR BRIEFING ALL CONTRACTOR PERSONNEL ON THESE REQUIREMENTS. CONTRACTOR EMPLOYEES SHALL ATTEND THE OWNER'S SECURITY TRAINING SESSION AND SHALL BE BRIEFED ON THESE REQUIREMENTS PRIOR TO WORKING IN THE CONSTRUCTION AREAS.
- 28. THE CONTRACTOR SHALL ACQUAINT THEIR SUPERVISORS AND EMPLOYEES WITH THE AIRPORT ACTIVITIES AND OPERATIONS THAT ARE INHERENT AT THIS AIRPORT AND SHALL CONDUCT THEIR CONSTRUCTION ACTIVITIES TO CONFORM TO ALL ROUTINE AND EMERGENCY AIR TRAFFIC REQUIREMENTS AND TO THE GUIDELINES ON SAFETY.

- 29. CONTRACTOR TO FIELD VERIFY AND PROTECT ALL EXISTING UTILITIES BEFORE CONSTRUCTION WORK BEGINS.
- 30. ALL LOCATIONS USED FOR HAUL ROUTES, STAGING AREAS, EMPLOYEE PARKING, AND MATERIAL STORAGE SHALL BE RESTORED TO ORIGINAL CONDITION WHEN ALL CONSTRUCTION IS COMPLETED.
- CONDITION OF ALL AIRPORT PAVEMENTS AND STRUCTURES. ANY DAMAGE NOTICED AFTER THE CONTRACTOR'S MOBILIZATION WILL BE ASSUMED TO BE CAUSED BY THE CONTRACTOR TO BE FULLY REPAIRED AT THE CONTRACTOR'S EXPENSE.
- 32. SUFFICIENT SWEEPERS AND CLEAN UP EQUIPMENT SHALL BE PROVIDED IN ORDER THAT ALL LOOSE MATERIAL, DEBRIS, AND MUD CAN BE REMOVED FROM ALL AIRPORT OPERATIONS AREAS ON A
- 33. GATES AT CONSTRUCTION ENTRANCES SHALL REMAIN CLOSED AND LOCKED AT ALL TIMES WHEN THE ENTRANCE IS NOT IN USE BY CONSTRUCTION PERSONNEL. GATES TO BE MANNED BY CONTRACTOR

PERSONNEL WHEN OPEN.

- 34. CONTRACTOR SHALL SUBMIT MSCAA & FAA UTILITY LOCATE REQUEST FORM PRIOR TO EXECUTION.
- 35. CONTRACTOR SHALL PREPARE A SAFETY PLAN COMPLIANCE DOCUMENT (SPCD) THAT DETAIL HOW THE CONTRACTOR WILL COMPLY WITH THE CONSTRUCTION SAFETY & PHASING PLAN (CSPP). THE SPCD MUST BE APPROVED BY THE AIRPORT OPERATOR PRIOR TO THE ISSUANCE OF A NOTICE TO



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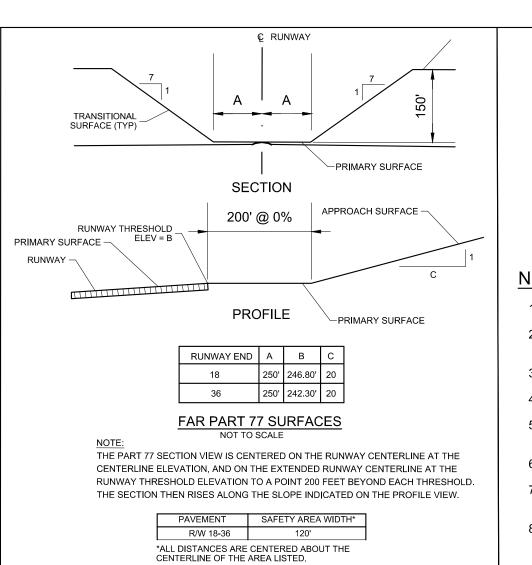
LOCAL EMERGENCY PHONE NUMBERS **EMERGENCY: 911** MILLINGTON POLICE DEPT: (901) 872-3333 FIRE DEPARTMENT: (901) 873-5800 AIRPORT: (901) 358-0028 MEDICAL: (901) 516-5200

UTILITY CONTACTS


LIQUIDATED DAMAGES \$2,000 PER CALENDAR DAY

MLGW: (901) 528-4270

CONTRACT TIME 25 CALENDAR DAYS



SAFETY AREA DIMENSIONS

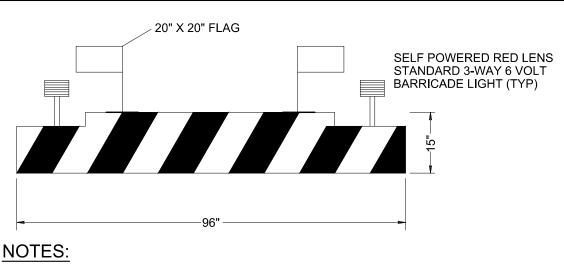

- 1. BARRICADES INTENDED FOR SHORT TERM CLOSURE OF AIRCRAFT ROUTES.
- 2. BARRICADE SHALL BE EQUIPPED WITH RED FLASHING LIGHTS THAT ARE SECURELY FASTENED TO THE BARRICADE TO AVOID JET INGESTION.
- 3. BARRICADES SHALL BE SPACED A MAXIMUM OF 8 FT FROM END TO END.
- 4. BARRICADES SHALL CONFORM TO AC 150/5370-2, LATEST EDITION.
- 5. BARRICADES SHALL BE NEUBERT AERO CORP. (NAC) AB811 OR EQUIVALENT AS APPROVED BY THE ENGINEER.
- 6. FILL BARRICADE BASE WITH WATER OR SAND TO ADD ADDITIONAL WEIGHT.
- 7. CONTRACTOR TO FURNISH, INSTALL, AND MAINTAIN BARRICADES THROUGHOUT THE DURATION OF THE PROJECT.
- 8. BARRICADES SHALL BE PAID FOR UNDER C-105-6.2.

8' SAFETY BARRICADE

N.T.S.




ROGRAM MANAGER

BARGE BARGE DESIGN SOLUTIONS, INC

65 GERMANTOWN CT, SUITE 100

MEMPHIS, TN 38018

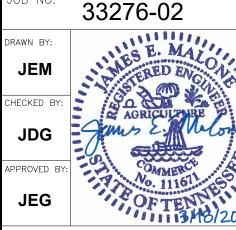

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> > REVISIONS DESCRIPTION ISSUED FOR BID

MSCAA PROJ. NO. 18-1420-01

CHARLES BAKER PAVEMENT RECONSTRUCTION

SHEET TITLE:

CONSTRUCTION SAFETY & PHASING PLAN (AREA 6)

DWG. FILE NAME 3327602-16C-SF-06.DWG

C-SF-06 03/11/2024 "=200"

SUMMARY OF QUANTITIES

	AREA 1 - NOT IN CONTRACT		,	
ITEM	DESCRIPTION	BID QUANTITY	FINAL QUANTIFY	UNIT
C-100-14.1	CONTRACTOR QUALITY CONTROL PROGRAM (CQCP)	1		LS
C-102-5.1	EROSION CONTROL SILT FENCE (INSTALLATION & REMOVAL)	2,218		LF
C-102-5.2	INLET PROTECTION (INSTALLATION & REMOVAL)	12		EA
C-102-5.3	WEIGHTED WATTLES (INSTALLATION & REMOVAL)	474		LF
C-102-5.4	TEMPORARY CONSTRUCTION EXIT (INSTALLATION & REMOVAL)	1		LS
C-105-6.1	MOBILIZATION	1		LS
C-105-6.2	AIRFIELD BARRICADES	1		LS
P-101-5.1	SAW-CUT ASPHALT	425		LF
P-101-5.2	STORM DRAIN INLET DEMOLITION	6		EA
	STORM DRAIN PIPE DEMOLITION	565		LF
	UNCLASSIFIED EXCAVATION (INCLUDES STRIPPING & REPLACING TOPSOL)	100		CY
P-207-5.1	IN-PLACE FULL DEPTH RECYCLED (FDR) ASPHALT AGGREGATE BASE COURSE (8" COMPACTED THICKNESS)	19,396		SY
P-403-8.1	ASPHALT SURFACE COURSE (1.5" COMPACTED THICKNESS)	1,800		TONS
P-403-8.2	ASPHALT BINDER COURSE (2.5" COMPACTED THICKNESS)	3,000		TONS
P-602-5.1	EMULSIFIED ASPHALT PRIME COAT	5,818		GAL
P-603-5.1	EMULSIFIED ASPHALT TACK COAT	1,940		GAL
P-620-5.1	PAVEMENT MARKING, REFLECTIVE YELLOW	275		SF
	PAVEMENT MARKING, NON-REFLECTIVE WHITE	1,263		SF
P-620-5.3	PAVEMENT MARKING, NON-REFLECTIVE YELLOW	409		SF
D-701-5.2	18 INCH RCP (CLASS III)	977		LF
D-751-5.1	INLET#10	7		EA
D-751-5.2	CONNECT TO EXISTING DRAINAGE STRUCTURE	4		EA
T-904-5.1	SODDING	2,034		SX

	AREA 2 - NOT IN CONTRACT			
ITEM	DESCRIPTION	BID QUANTITY	FINAL QUANTITY	UNIT
C-100-14.1	CONTRACTOR QUALITY CONTROL PROGRAM (CQCP)	1		LS
	EROSION CONTROL SILT FENCE (INSTALLATION & REMOVAL)	170		LF
	INLET PROTECTION (INSTALLATION & REMOVAL)	1		EA
C-102-5.3	WEIGHTED WATTLES (INSTALLATION & REMOVAL)	310		LF
C-102-5.4	TEMPORARY CONSTRUCTION EXIT (INSTALLATION & REMOVAL)	1		LS
C-105-6.1	MOBILIZATION	1		LS
C-105-6.2	AIRFIELD BARRICADES	1		LS
P-101-5.1	SAW-CUT ASPHALT	889		LF
P-101-5.4	TIE DOWN REMOVAL	13		EA
	UNCLASSIFIED EXCAVATION (INCLUDES STRIPPING & REPLACING TOPSOIL)	100		CY
P-207-5.1	IN-PLACE FULL DEPTH RECYCLED (FDR) ASPHALT AGGREGATE BASE COURSE (8" COMPACTED THICKNESS)	4,997		SY
P-403-8.1	ASPHALT SURFACE COURSE (1.5" COMPACTED THICKNESS)	470		TONS
P-403-8.2	ASPHALT BINDER COURSE (2.5" COMPACTED THICKNESS)	784		TONS
P-602-5.1	EMULSIFIED ASPHALT PRIME COAT	1,471		GAL
P-603-5.1	EMULSIFIED ASPHALT TACK COAT	503		GAL
	AIRCRAFT TIEDOWNS	14		EA
	PAVEMENT MARKING, NON-REFLECTIVE WHITE	351		SF
P-620-5.3	PAVEMENT MARKING, NON-REFLECTIVE YELLOW	185		SF
T-904-5.1	SODDING	35		TSY_
				•

	BASE BID: AREA 3				
ITEM	DESCRIPTION	BID QUANTITY	FINAL QUANTITY	UNIT	
C-100-14.1	CONTRACTOR QUALITY CONTROL PROGRAM (CQCP)	1		LS	
C-102-5.1	EROSION CONTROL SILT FENCE (INSTALLATION & REMOVAL)	1,332		LF	
C-102-5.2	INLET PROTECTION (INSTALLATION & REMOVAL)	1		EA	
C-102-5.4	TEMPORARY CONSTRUCTION EXIT (INSTALLATION & REMOVAL)	1		LS	
C-105-6.1	MOBILIZATION	1		LS	
C-105-6.2	AIRFIELD BARRICADES	1		LS	
P-101-5.1	SAW-CUT ASPHALT	437		LF	
P-101-5.4	TIE DOWN REMOVAL	36		EA	
P-152-4.1	UNCLASSIFIED EXCAVATION (INCLUDES STRIPPING & REPLACING TOPSOIL)	100		CY	
P-207-5.1	IN-PLACE FULL DEPTH RECYCLED (FDR) ASPHALT AGGREGATE BASE COURSE (8" COMPACTED THICKNESS)	8,347		SY	
P-403-8.1	ASPHALT SURFACE COURSE (1.5" COMPACTED THICKNESS)	775		TONS	
P-403-8.2	ASPHALT BINDER COURSE (2.5" COMPACTED THICKNESS)	1,291		TONS	
P-602-5.1	EMULSIFIED ASPHALT PRIME COAT	2,504		GAL	
P-603-5.1	EMULSIFIED ASPHALT TACK COAT	418		GAL	
P-610-6.1	AIRCRAFT TIE-DOWNS	36		EA	
P-620-5.1	PAVEMENT MARKING, REFLECTIVE YELLOW	246		SF	
P-620-5.3	PAVEMENT MARKING, NON-REFLECTIVE YELLOW	246		SF	
T-904-5.1	SODDING	2,051		SY	

	AREA 4 - NOT IN CONTRACT			
ITEM	DESCRIPTION	BID QUANTITY	FINAL QUANTITY	UNIT
C-100-14.1	CONTRACTOR QUALITY CONTROL PROGRAM (CQCP)	_1		LS
C-102-5.1	EROSION CONTROL SILT FENCE (INSTALLATION & REMOVAL)	1,040		LF
	INLET PROTECTION (INSTALLATION & REMOVAL)	1		EA
C-102-5.4	TEMPORARY CONSTRUCTION EXIT (INSTALLATION & REMOVAL)	1		LS
C-105-6.1	MOBILIZATION	1		LS
C-105-6.2	AIRFIELD BARRICADES	1		LS
P-101-5.1	SAW-CUT ASPHALT	94		LF
	UNCLASSIFIED EXCAVATION (INCLUDES STRIPPING & REPLACING TOPSOIL)	100		CY
	IN-PLACE FULL DEPTH RECYCLED (FDR) ASPHALT AGGREGATE BASE COURSE (8" COMPACTED THICKNESS)	2,392		SY
	ASPHALT SURFACE COURSE (1.5" COMPACTED THICKNESS)	222		TONS
P-403-8.2	ASPHALT BINDER COURSE (2.5" COMPACTED THICKNESS)	370		TONS
	EMULSIFIED ASPHALT PRIME COAT	718		GAL
	EMULSIFIED ASPHALT TACK COAT	240		GAL
D-751-5.1	INLET #10	1		EA
T-904-5.1	SODDING	130		SY

	AREA 5 - NOT IN CONTRACT			
ITEM	DESCRIPTION	BID QUANTITY	FINAL QUANTITY	UNIT
C-100-14.1	CONTRACTOR QUALITY CONTROL PROGRAM (CQCP)	1		LS
C-102-5.1	EROSION CONTROL SILT FENCE (INSTALLATION & REMOVAL)	1,350		LF
C-102-5.4	TEMPORARY CONSTRUCTION EXIT (INSTALLATION & REMOVAL)	1		LS
C-105-6.1	MOBILIZATION	1		LS
C-105-6.2	AIRFIELD BARRICADES	1		LS
P-101-5.1	SAW-CUT ASPHALT	67		LF
	UNCLASSIFIED EXCAVATION (INCLUDES STRIPPING & REPLACING TOPSOIL)	100		CY
	IN-PLACE FULL DEPTH RECYCLED (FDR) ASPHALT AGGREGATE BASE COURSE (8" COMPACTED THICKNESS)	4,102		SY
P-403-8.1	ASPHALT SURFACE COURSE (1.5" COMPACTED THICKNESS)	380		TONS
P-403-8.2	ASPHALT BINDER COURSE (2.5" COMPACTED THICKNESS)	635		TONS
P-602-5.1	EMULSIFIED ASPHALT PRIME COAT	1,230		GAL
P-603-5.1	EMULSIFIED ASPHALT TACK COAT	410		GAL
T-904-5.1	SODDING	185		SY

	BASE BID: AREA 6				
ITEM	DESCRIPTION BID QUANTITY	FINAL QUANTITY UNIT			
C-100-14.1	CONTRACTOR QUALITY CONTROL PROGRAM (CQCP)	LS			
C-102-5.1	EROSION CONTROL SILT FENCE (INSTALLATION & REMOVAL) 1,922	LF			
C-102-5.2	INLET PROTECTION (INSTALLATION & REMOVAL)	EA			
C-102-5.4	TEMPORARY CONSTRUCTION EXIT (INSTALLATION & REMOVAL)	LS			
C-105-6.1	MOBILIZATION 1	LS			
C-105-6.2	AIRFIELD BARRICADES 1	LS			
P-101-5.1	SAW-CUT ASPHALT 217	LF			
P-101-5.5	UTILITY CUT REPAIR (6" CRUSHED AGGREGATE, 4" HMA)	LS			
P-101-5.6	MARKING REMOVAL 2,020	SF			
P-152-4.1	UNCLASSIFIED EXCAVATION (INCLUDES STRIPPING & REPLACING TOPSOIL) 200	CY			
P-620-5.1	PAVEMENT MARKING, REFLECTIVE YELLOW 1,010	SF			
P-620-5.3	PAVEMENT MARKING, NON-REFLECTIVE YELLOW 1,010	SF			
D-701-5.1	22X13.5 INCH RCP ARCH PIPE (CLASS III) 660	LF			
D-751-5.2	CONNECT TO EXISTING DRAINAGE STRUCTURE 1	EA			
D-751-5.3	3'X3' INLET	EA			
D-752-5.1	22X13.5 INCH CONCRETE HEADWALL 1	EA			
T-904-5.1	SODDING 7,460	SY			

	ADDITIVE ALTERNATE #1				
ITEM	DESCRIPTION	BID QUANTITY	FINAL QUANTITY	UNIT	
C-102-5.1	EROSION CONTROL SILT FENCE (INSTALLATION & REMOVAL)	21		LF	
P-207-5.1	IN-PLACE FULL DEPTH RECYCLED (FDR) ASPHALT AGGREGATE BASE COURSE (8" COMPACTED THICKNESS)	556		SY	
P-403-8.1	ASPHALT SURFACE COURSE (1.5" COMPACTED THICKNESS)	48		TONS	
P-403-8.2	ASPHALT BINDER COURSE (2.5" COMPACTED THICKNESS)	80		TONS	
P-602-5.1	EMULSIFIED ASPHALT PRIME COAT	223		GAL	
P-603-5.1	EMULSIFIED ASPHALT TACK COAT	56		GAL	

	ADDITIVE ALTERNATE #2				
ITEM	DESCRIPTION	BID QUANTITY	FINAL QUANTITY	UNIT	
C-102-5.1	EROSION CONTROL SILT FENCE (INSTALLATION & REMOVAL)	102		LF	
C-102-5.3	WEIGHTED WATTLES (INSTALLATION & REMOVAL)	268		LF	
P-101-5.1	SAW-CUT ASPHALT	102		LF	
P-101-5.4	TIE DOWN REMOVAL	14		EA	
P-207-5.1	IN-PLACE FULL DEPTH RECYCLED (FDR) ASPHALT AGGREGATE BASE COURSE (8" COMPACTED THICKNESS)	1,838		SY	
P-403-8.1	ASPHALT SURFACE COURSE (1.5" COMPACTED THICKNESS)	185		TONS	
P-403-8.2	ASPHALT BINDER COURSE (2.5" COMPACTED THICKNESS)	285		TONS	
P-602-5.1	EMULSIFIED ASPHALT PRIME COAT	492		GAL	
P-603-5.1	EMULSIFIED ASPHALT TACK COAT	186		GAL	
P-610-6.1	AIRCRAFT TIEDOWNS	13		EA	
P-620-5.2	PAVEMENT MARKING, NON-REFLECTIVE WHITE	14		SF	
P-620-5.3	PAVEMENT MARKING, NON-REFLECTIVE YELLOW	82		SF	
T-904-5.1	SODDING	35		SY	

NOTE: AREA 1, AREA 2, AREA 4, AND AREA 5 ARE SHOWN FOR REFERENCE ONLY AND ARE NOT INCLUDED IN THIS CONTRACT. **ONLY AREA 3, AREA 6, ADDITIVE** ALTERNATE #1, AND ADDITIVE ALTERNATE #2 WILL BE PART OF THIS CONTRACT.

GENERAL NOTES:

- 1. THE CONTRACTOR MUST SCHEDULE OPERATIONS IN ORDER TO COMPLETE CONSTRUCTION IN THE OVERALL TIME LIMIT SPECIFIED. CONTRACTOR IS TO PREPARE A CONSTRUCTION SCHEDULE TO INCLUDE THE PROPOSED SEQUENCE OF CONSTRUCTION, AND BRING THE SCHEDULE TO THE PRECONSTRUCTION MEETING FOR REVIEW AND APPROVAL.
- 2. THE CONTRACTOR SHALL COMPLY WITH ALL PERTINENT PROVISIONS OF THE "MANUAL OF ACCIDENT PREVENTION IN CONSTRUCTION" ISSUED BY AGC OF AMERICA, INC. AND THE "SAFETY AND HEALTH REGULATIONS FOR CONSTRUCTION" ISSUED BY THE UNITED STATES DEPARTMENT OF LABOR. REFER TO MSCAA SAFETY MANUAL FOR ADDITIONAL SAFETY REQUIREMENTS.
- 3. THE LOCATIONS OF UTILITIES (INCLUSIVE OF STORM DRAINS) SHOWN WITHIN THESE PLANS ARE APPROXIMATE. EXACT LOCATIONS SHALL BE VERIFIED IN THE FIELD BY THE CONTRACTOR PRIOR TO CONSTRUCTION. CONTRACTOR SHALL CALL TENNESSEE ONE CALL AT 1-800-351-1111 (OR 811). CONTRACTOR SHALL ALSO CONTACT THE AIRPORT FOR UTILITY LOCATIONS.
- 4. CONTRACTOR SHALL GIVE ALL NECESSARY NOTICES AND OBTAIN ALL PERMITS.
- PROPOSED HAUL ROUTES AND STOCKPILE AREAS SHALL BE APPROVED BY THE RESIDENT PROJECT REPRESENTATIVE AND THE OWNER PRIOR TO START OF WORK. ALL CONSTRUCTION TRAFFIC MUST ENTER AND EXIT THE PROJECT WORK AREA PER DESIGNATED HAUL ROUTES.
- 6. CONTRACTOR SHALL REVIEW PROJECT CONSTRUCTION SAFETY PLAN AND BE FAMILIAR WITH ALL AIRPORT OPERATIONAL SAFETY AREAS. NO EQUIPMENT SHALL BE LEFT IN THE RUNWAY/TAXIWAY SAFETY/OBJECT FREE AREAS, AND LIGHTED BARRICADES SHALL BE PROVIDED AS REQUIRED.
- 7. GENERAL CONTRACTOR SHALL HAVE AN AUTHORIZED JOB SUPERINTENDENT ON SITE WHENEVER WORK IS BEING PERFORMED BY ANY TRADE.
- 8. CONTRACTOR IS REQUIRED TO FURNISH ALL STAKING REQUIRED FOR COMPLETION OF THE JOB. HORIZONTAL AND VERTICAL CONTROL ARE TO BE ESTABLISHED BY THE ENGINEER.
- 9. IN THE EVENT OF ANY DISCREPANCIES AND/OR ERRORS FOUND IN THE DRAWINGS, OR IF PROBLEMS ARE ENCOUNTERED DURING CONSTRUCTION, THE CONTRACTOR SHALL BE REQUIRED TO NOTIFY THE ENGINEER BEFORE PROCEEDING WITH THE WORK. IF ENGINEER IS NOT NOTIFIED, THE CONTRACTOR SHALL TAKE RESPONSIBILITY FOR THE COST OF ANY REVISIONS.
- 10. THE CONTRACTOR SHALL BE RESPONSIBLE FOR THE STABILIZATION OF AND THE MAINTENANCE OF ALL ACCESS AND HAUL ROUTES. ALL ACCESS AND HAUL ROUTES SHALL BE RETURNED TO THEIR ORIGINAL CONDITION, OR LEFT AS
- DESIRED BY THE OWNER, PRIOR TO FINAL ACCEPTANCE OF THE PROJECT. 11. THE CONTRACTOR SHALL BE RESPONSIBLE FOR REPAIRING ANY EXISTING PAVEMENTS, ON OR OFF THE AIRPORT
- PROPERTY, WHICH BECOME DAMAGED BY CONSTRUCTION TRAFFIC. 12. THESE NOTES ARE INTENDED TO SUPPLEMENT PROJECT SPECIFICATIONS AND IN NO WAY INVALIDATE
- SPECIFICATIONS PROVIDED IN OTHER BID DOCUMENTS (GENERAL OR SPECIFIC REQUIREMENTS). 13. SURPLUS MATERIAL NOT RETAINED BY THE AIRPORT AND NOT REQUIRED FOR SITE CONSTRUCTION SHALL BE
- DISPOSED OF BY THE CONTRACTOR AT THE CONTRACTOR'S EXPENSE.
- 14. COORDINATE ALL WORK WITH THE RPR. RPR WILL COORDINATE WITH AIRPORT MANAGER FOR APPROVAL.

PROGRAM MANAGER

BARGE BARGE DESIGN SOLUTIONS, INC 65 GERMANTOWN CT, SUITE 100

33276-02

MEMPHIS, TN 38018

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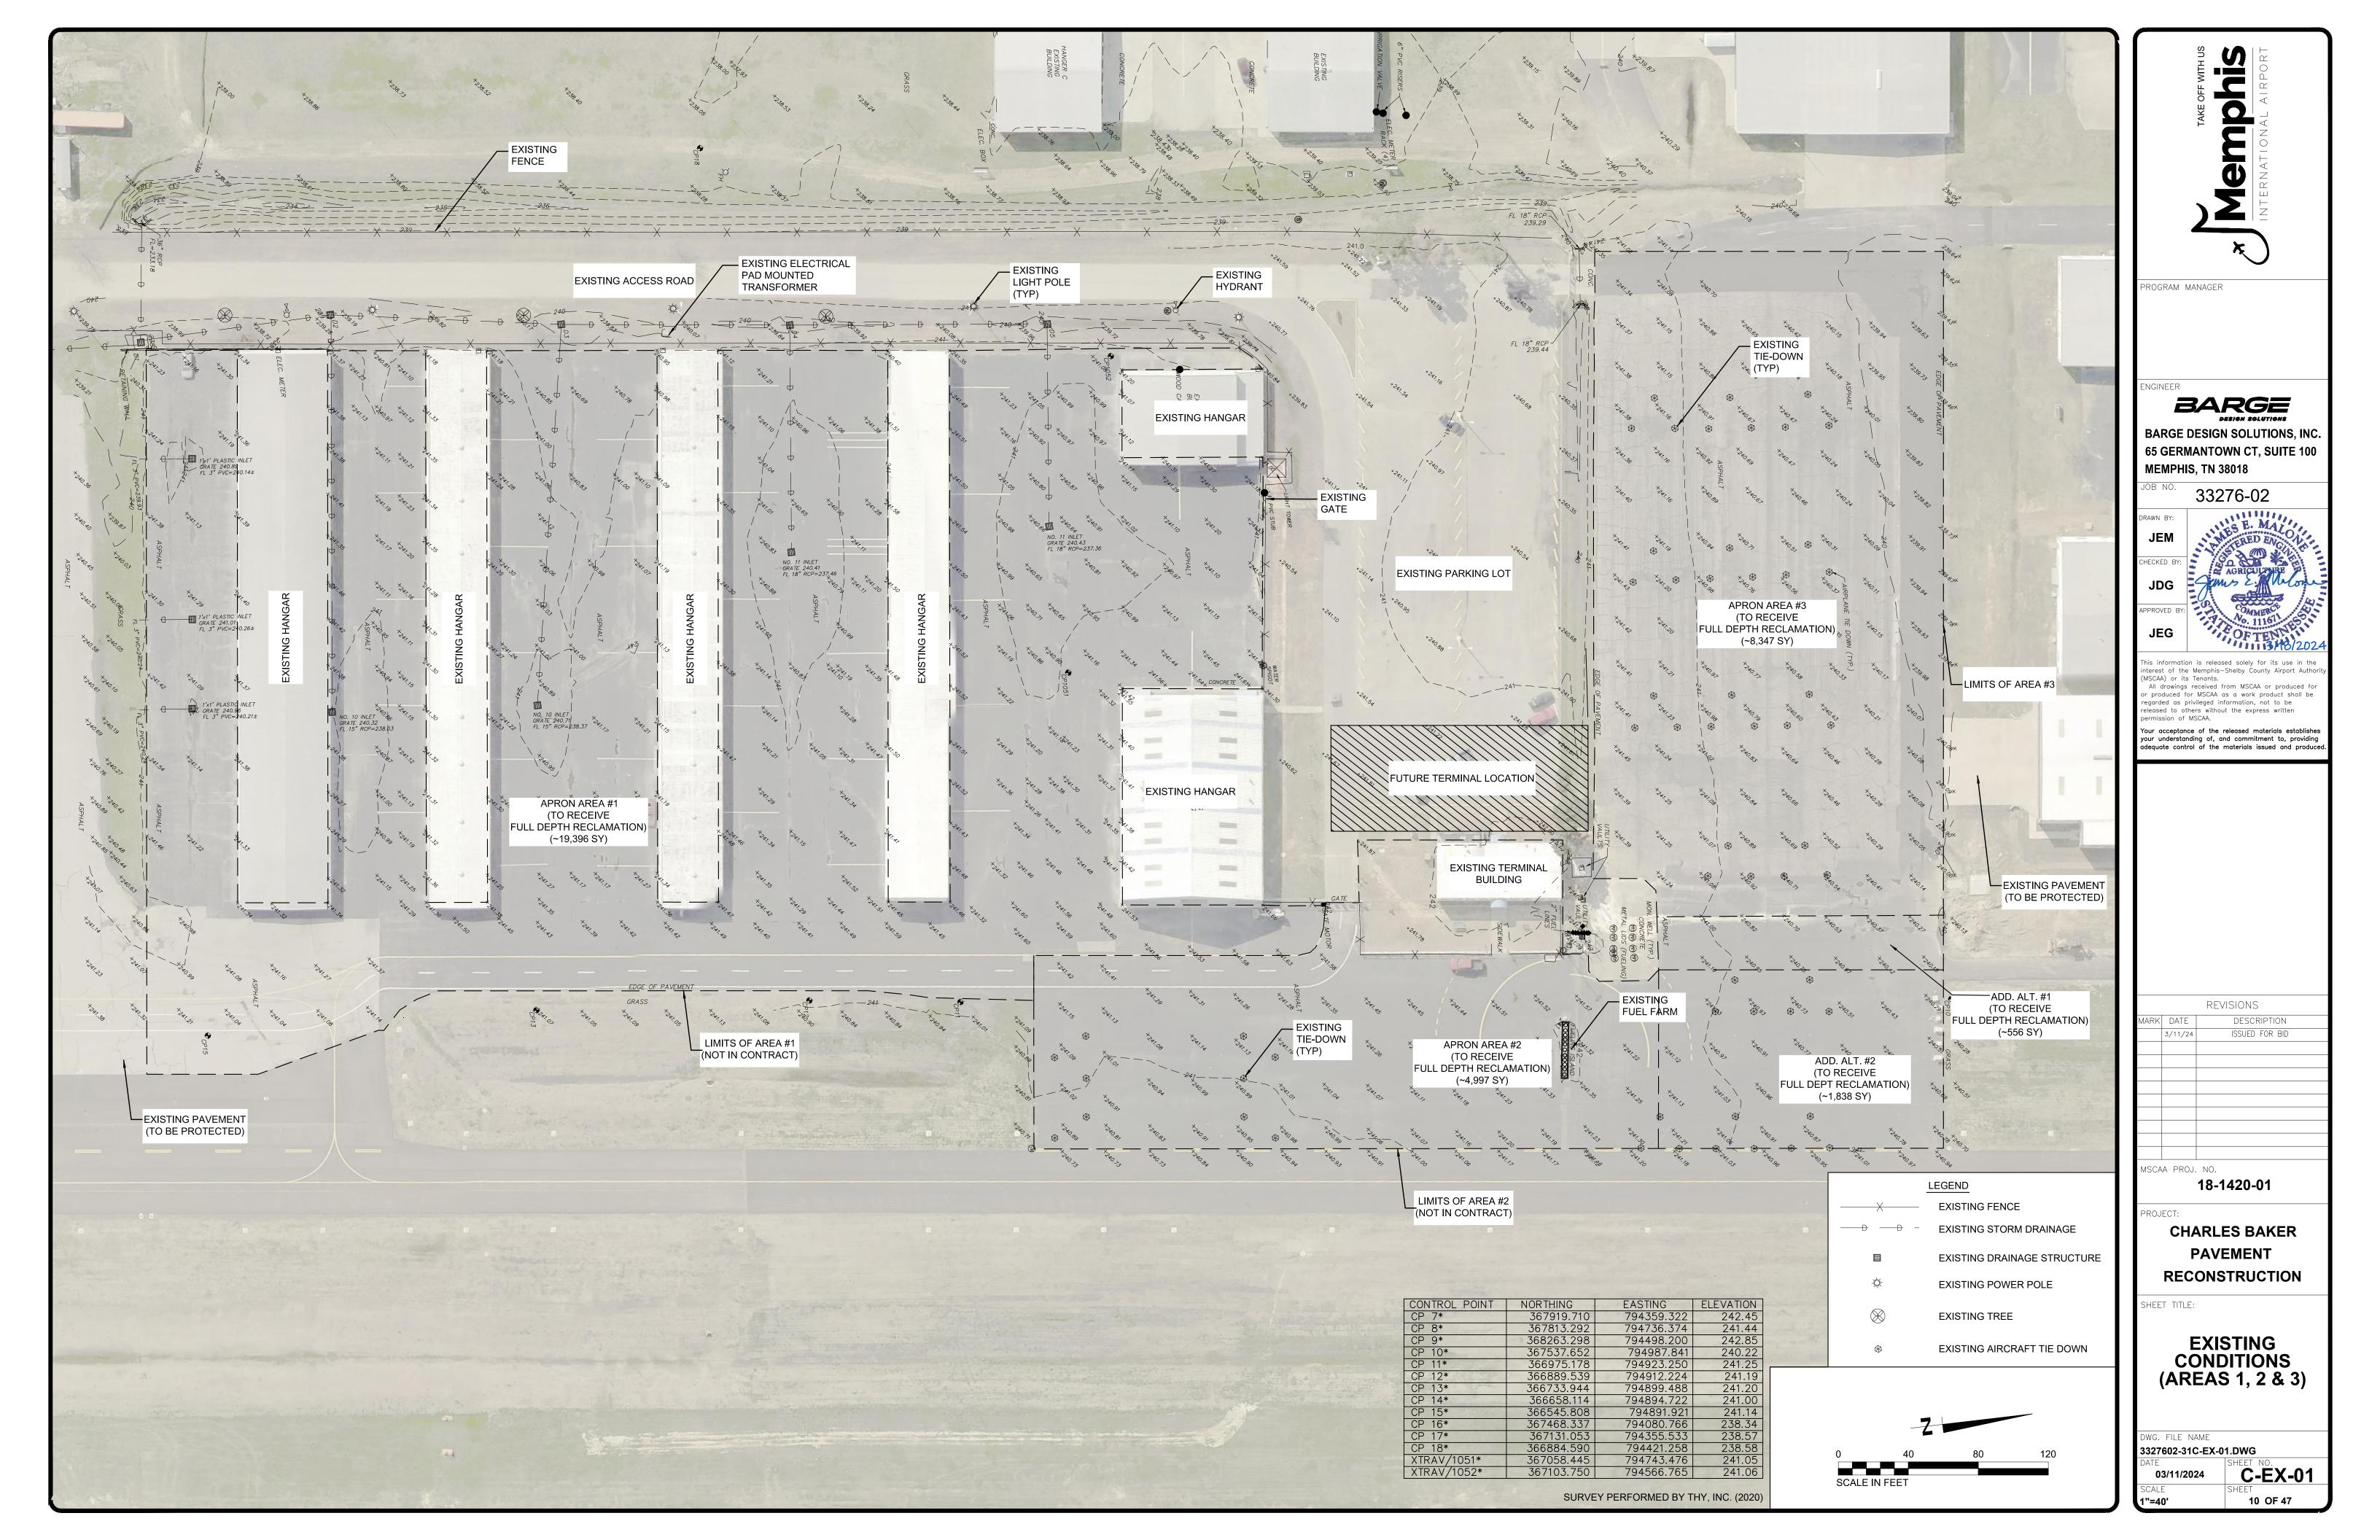
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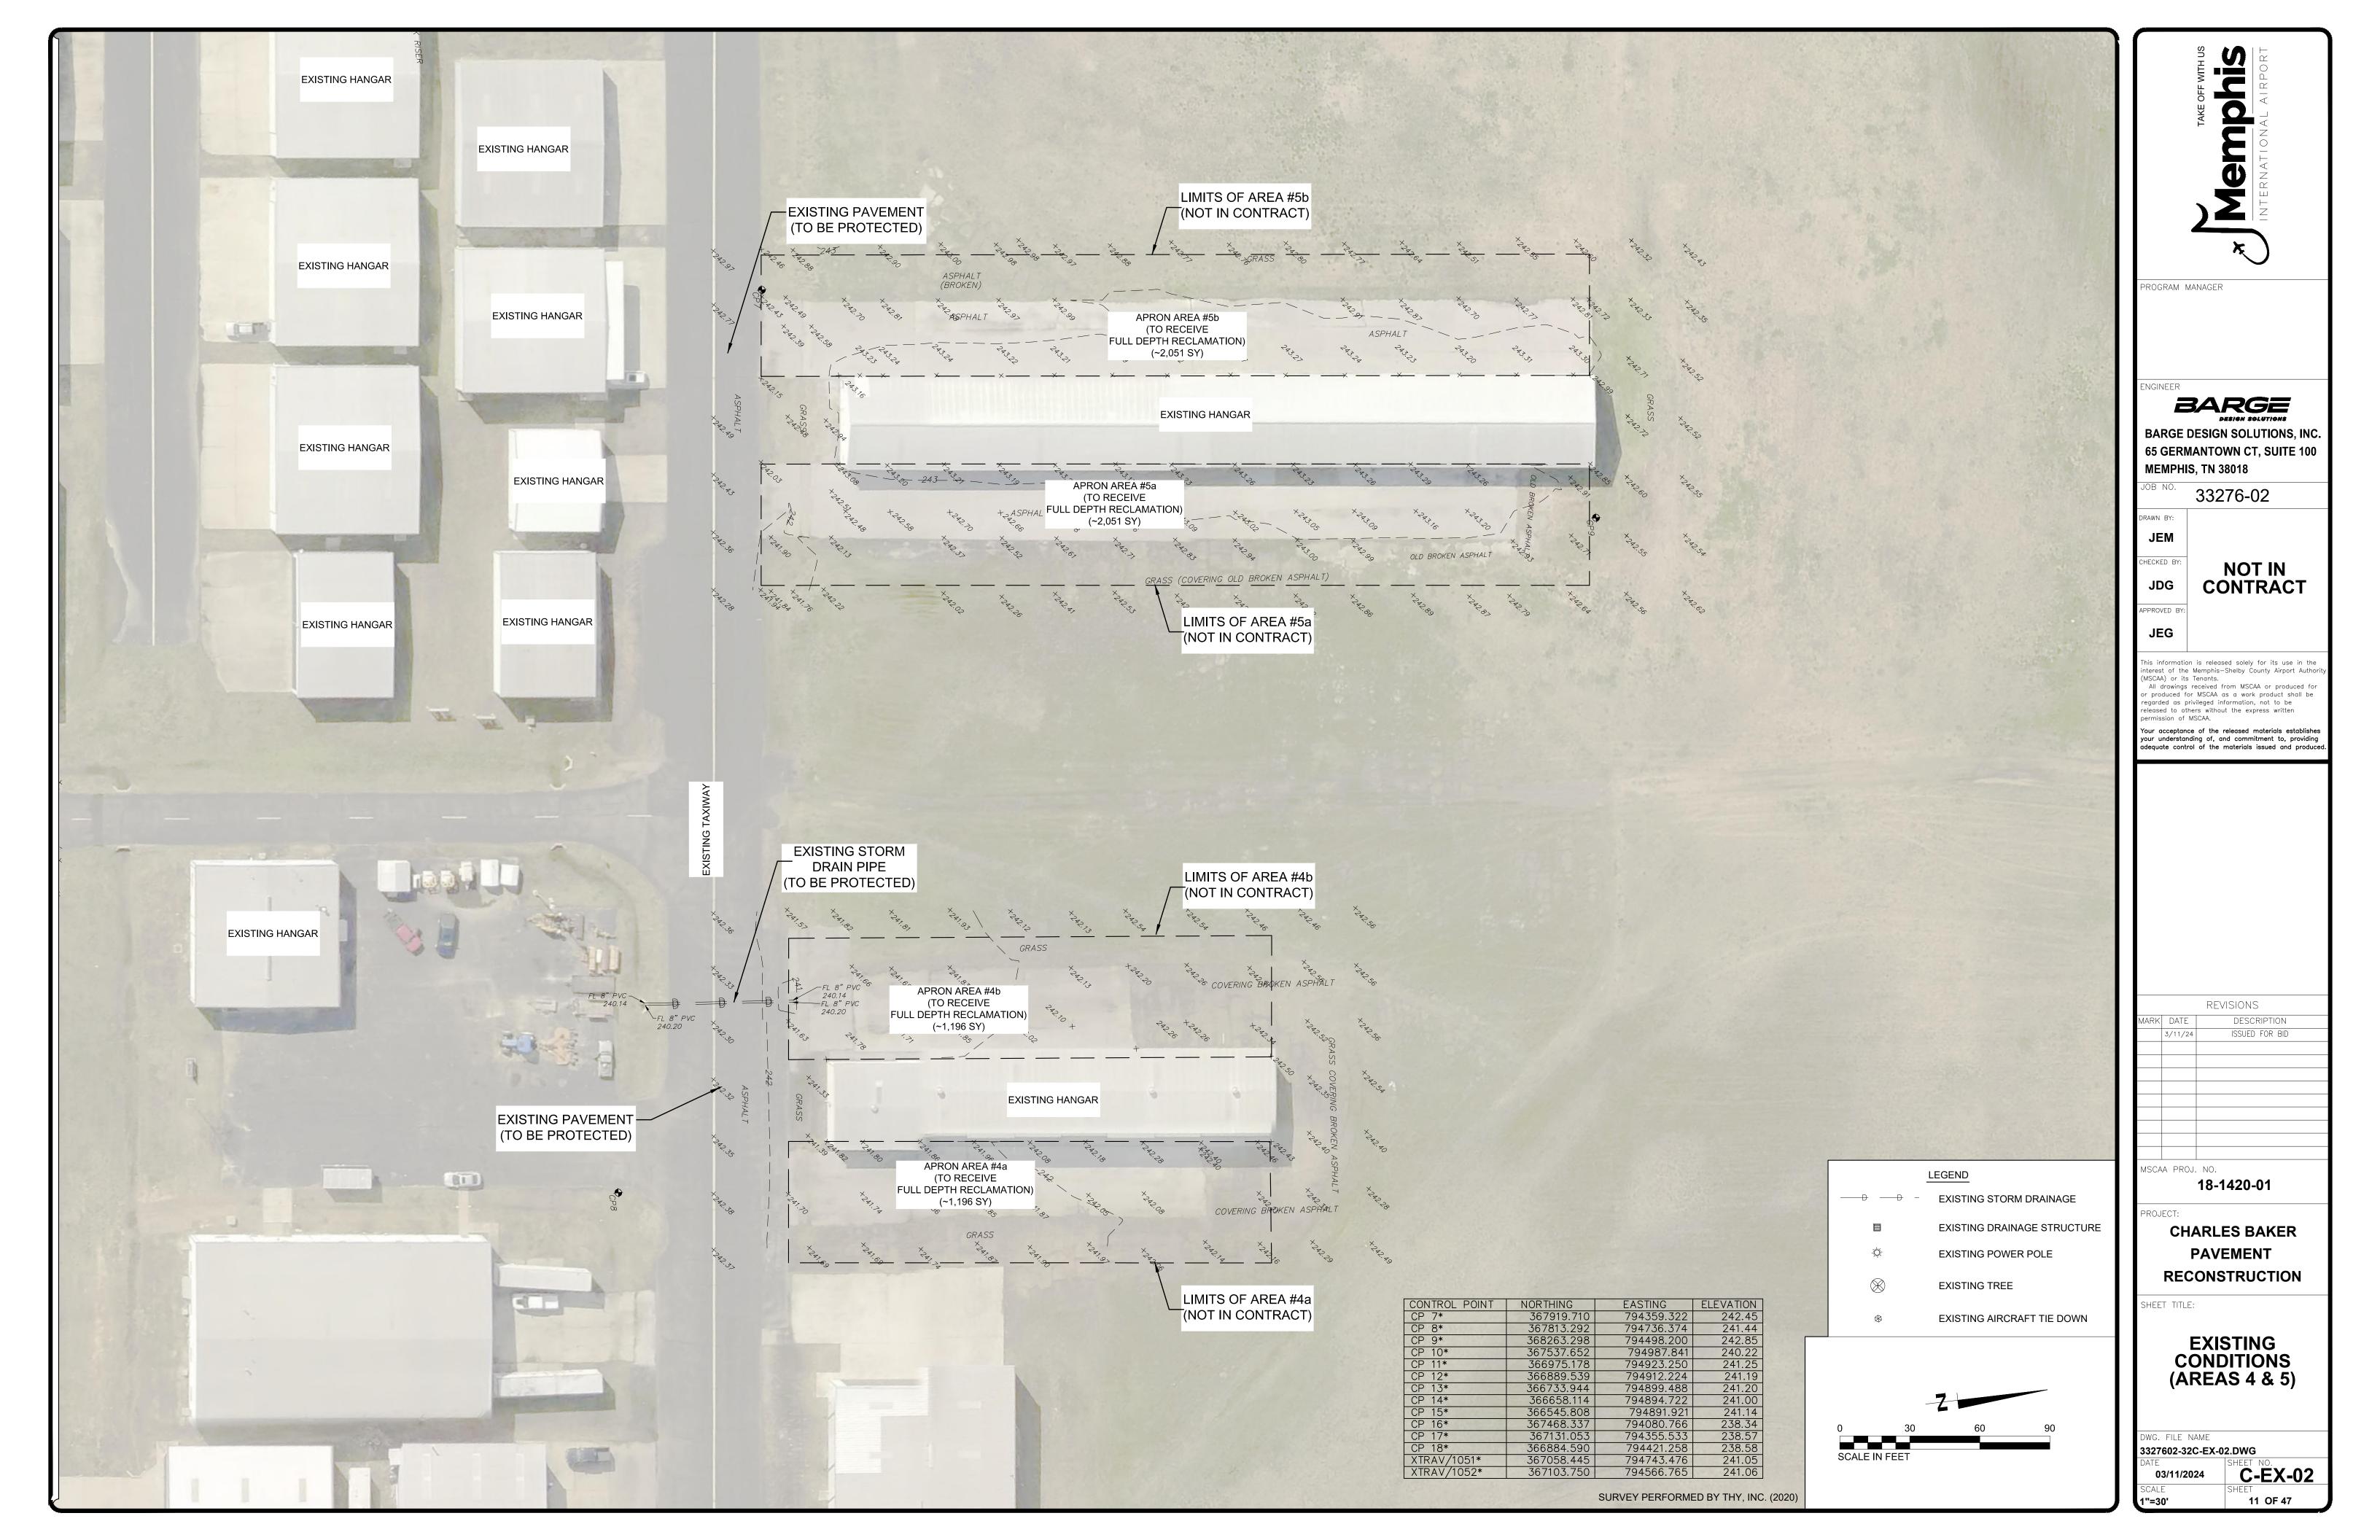
CHARLES BAKER PAVEMENT RECONSTRUCTION


GENERAL NOTES SUMMARY OF QUANTITIES


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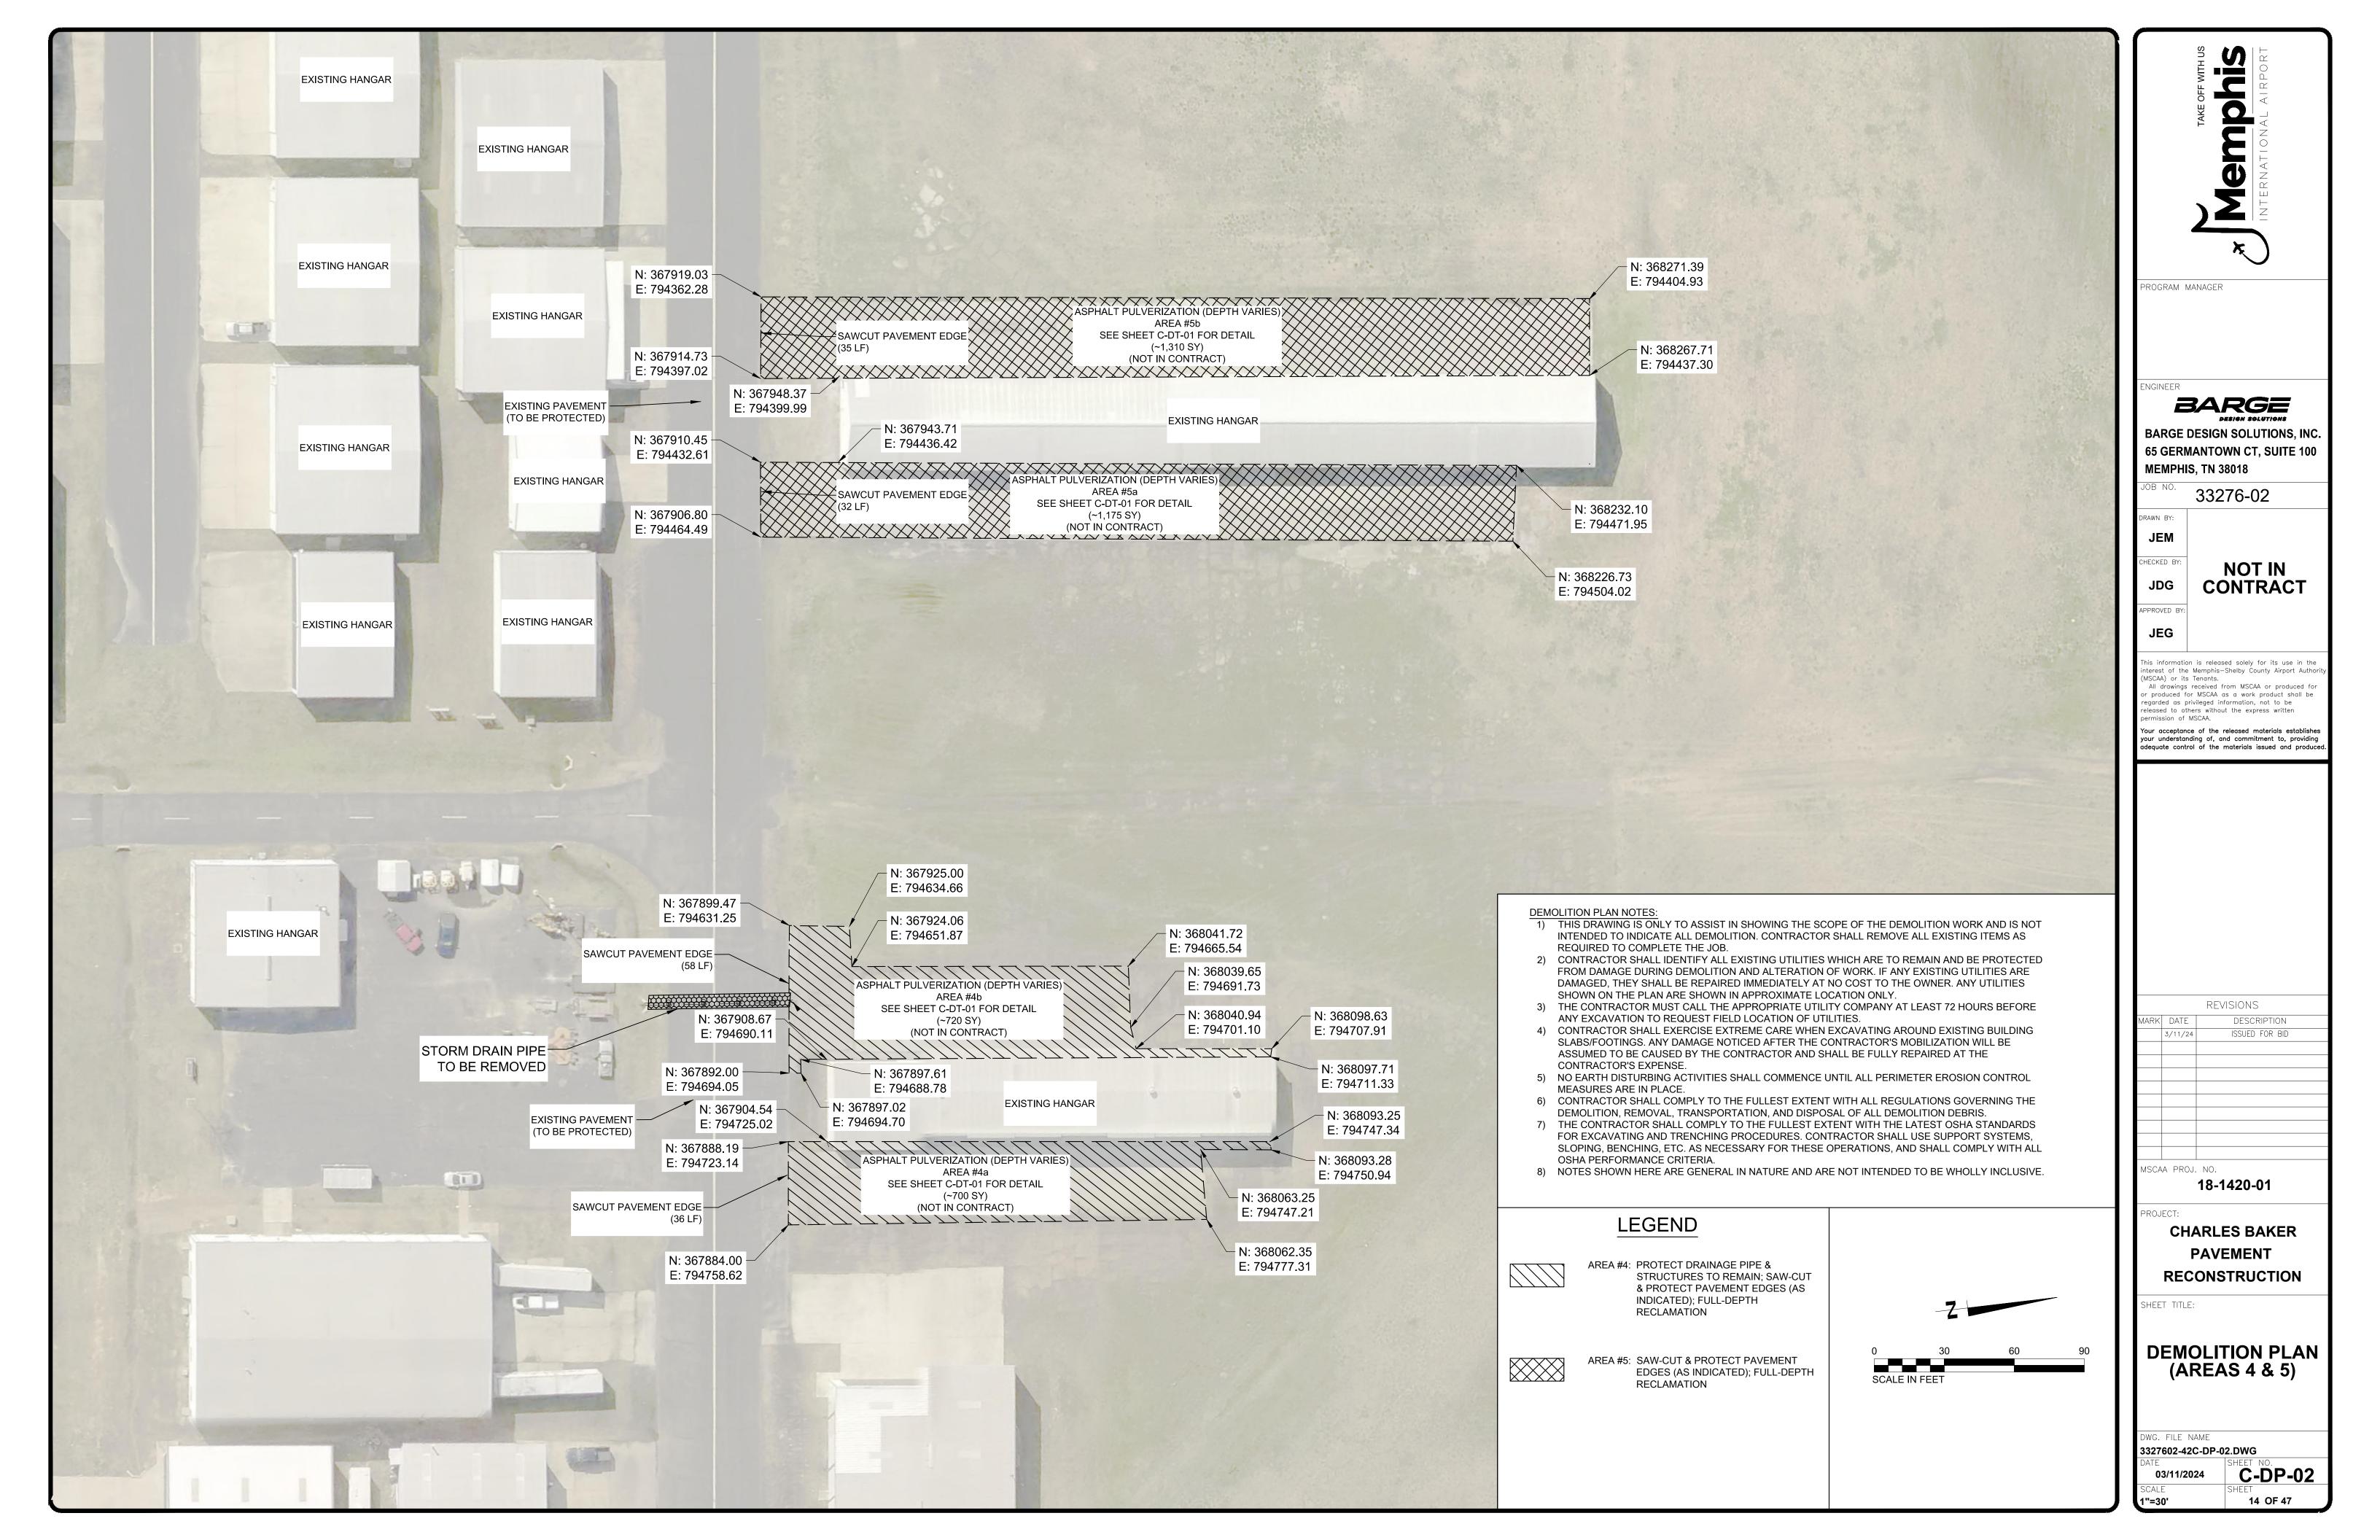
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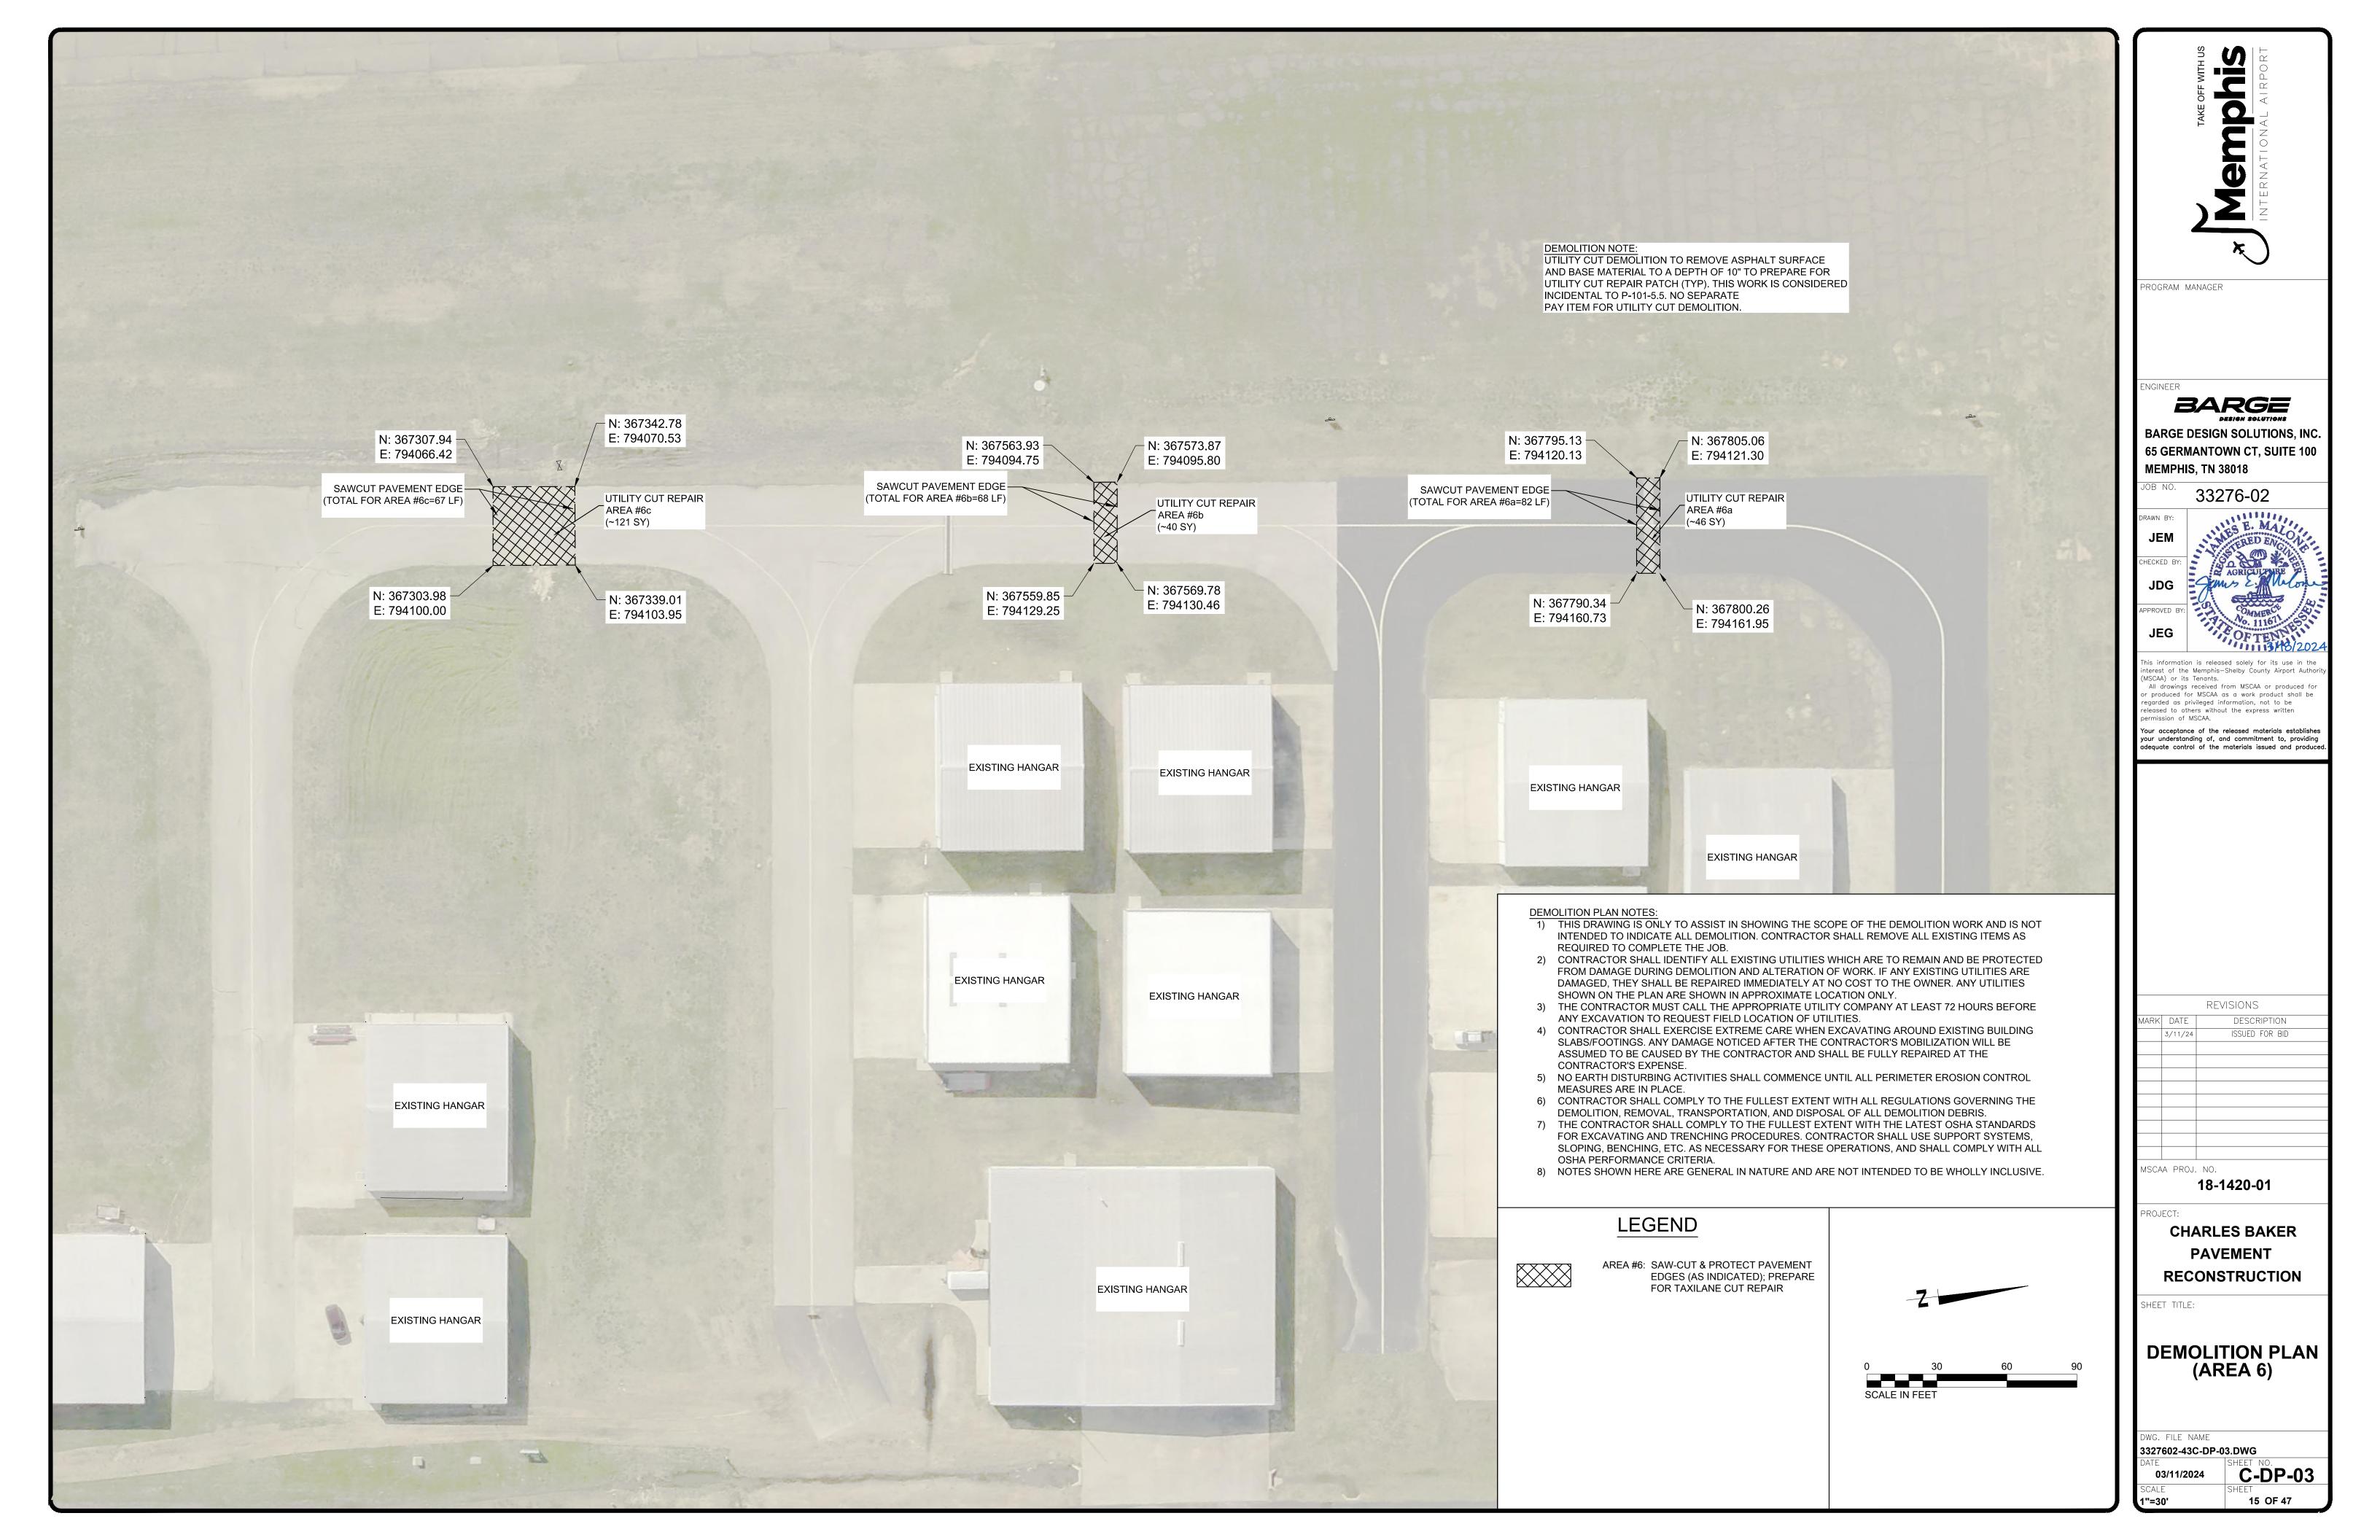











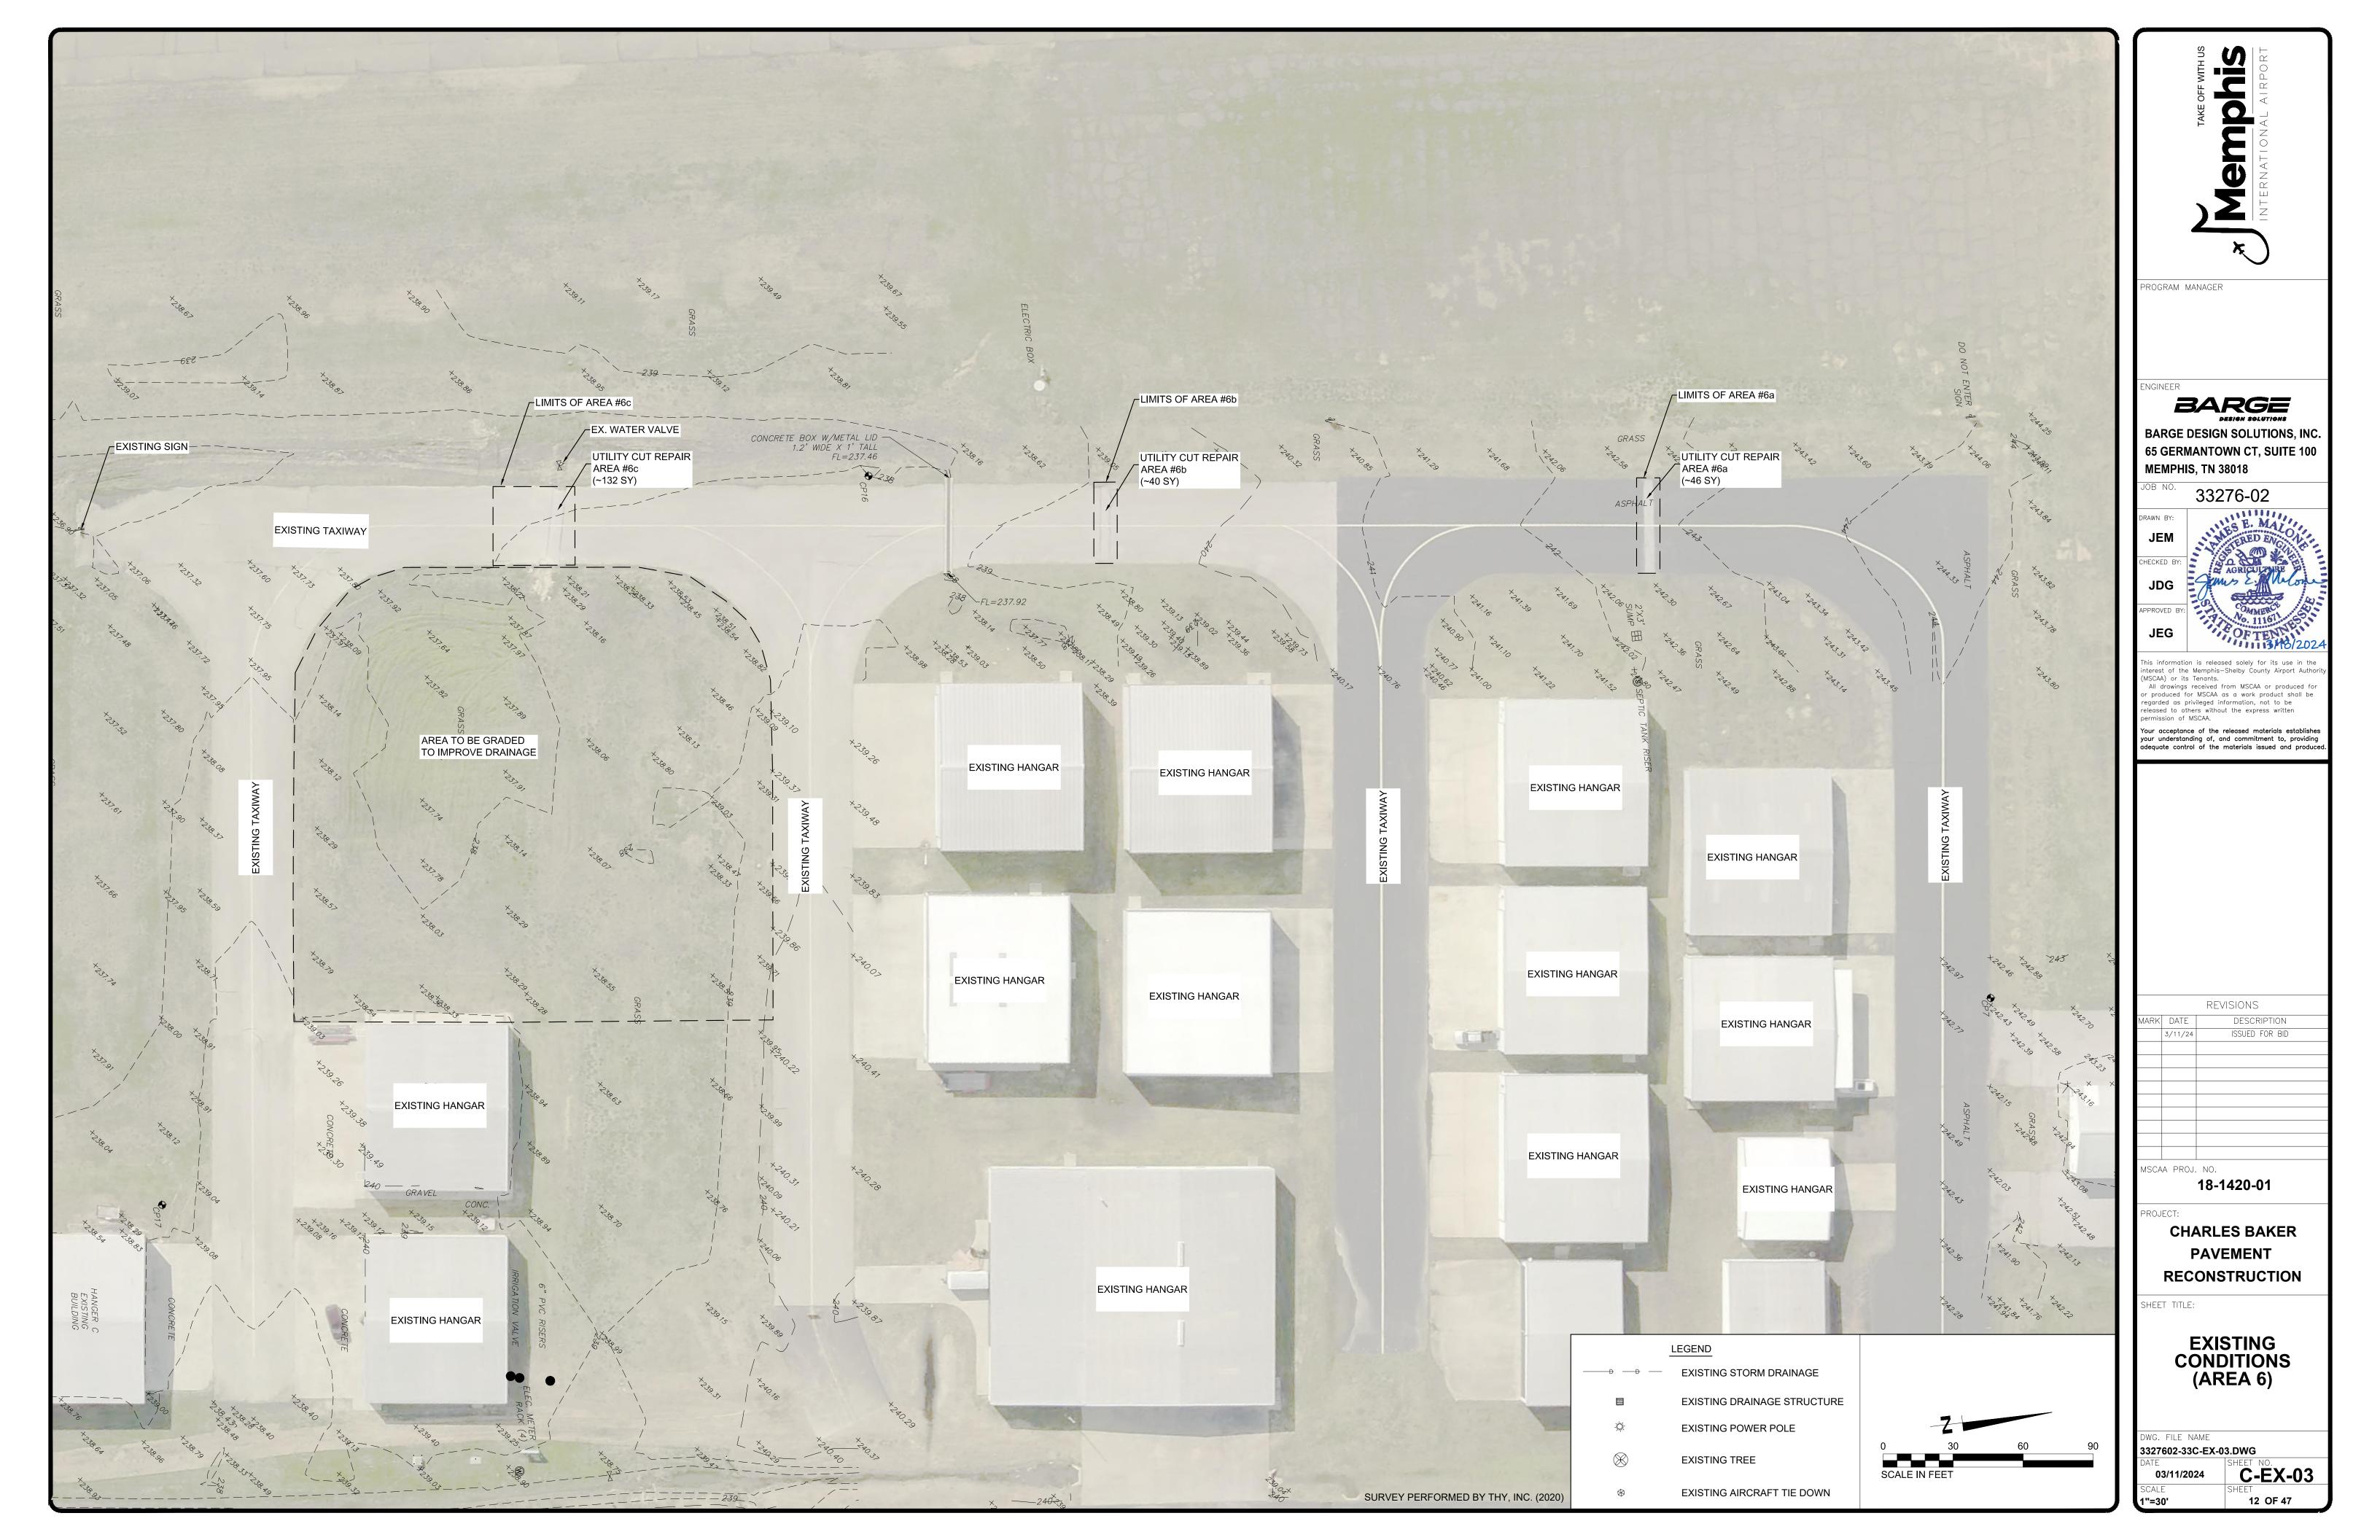


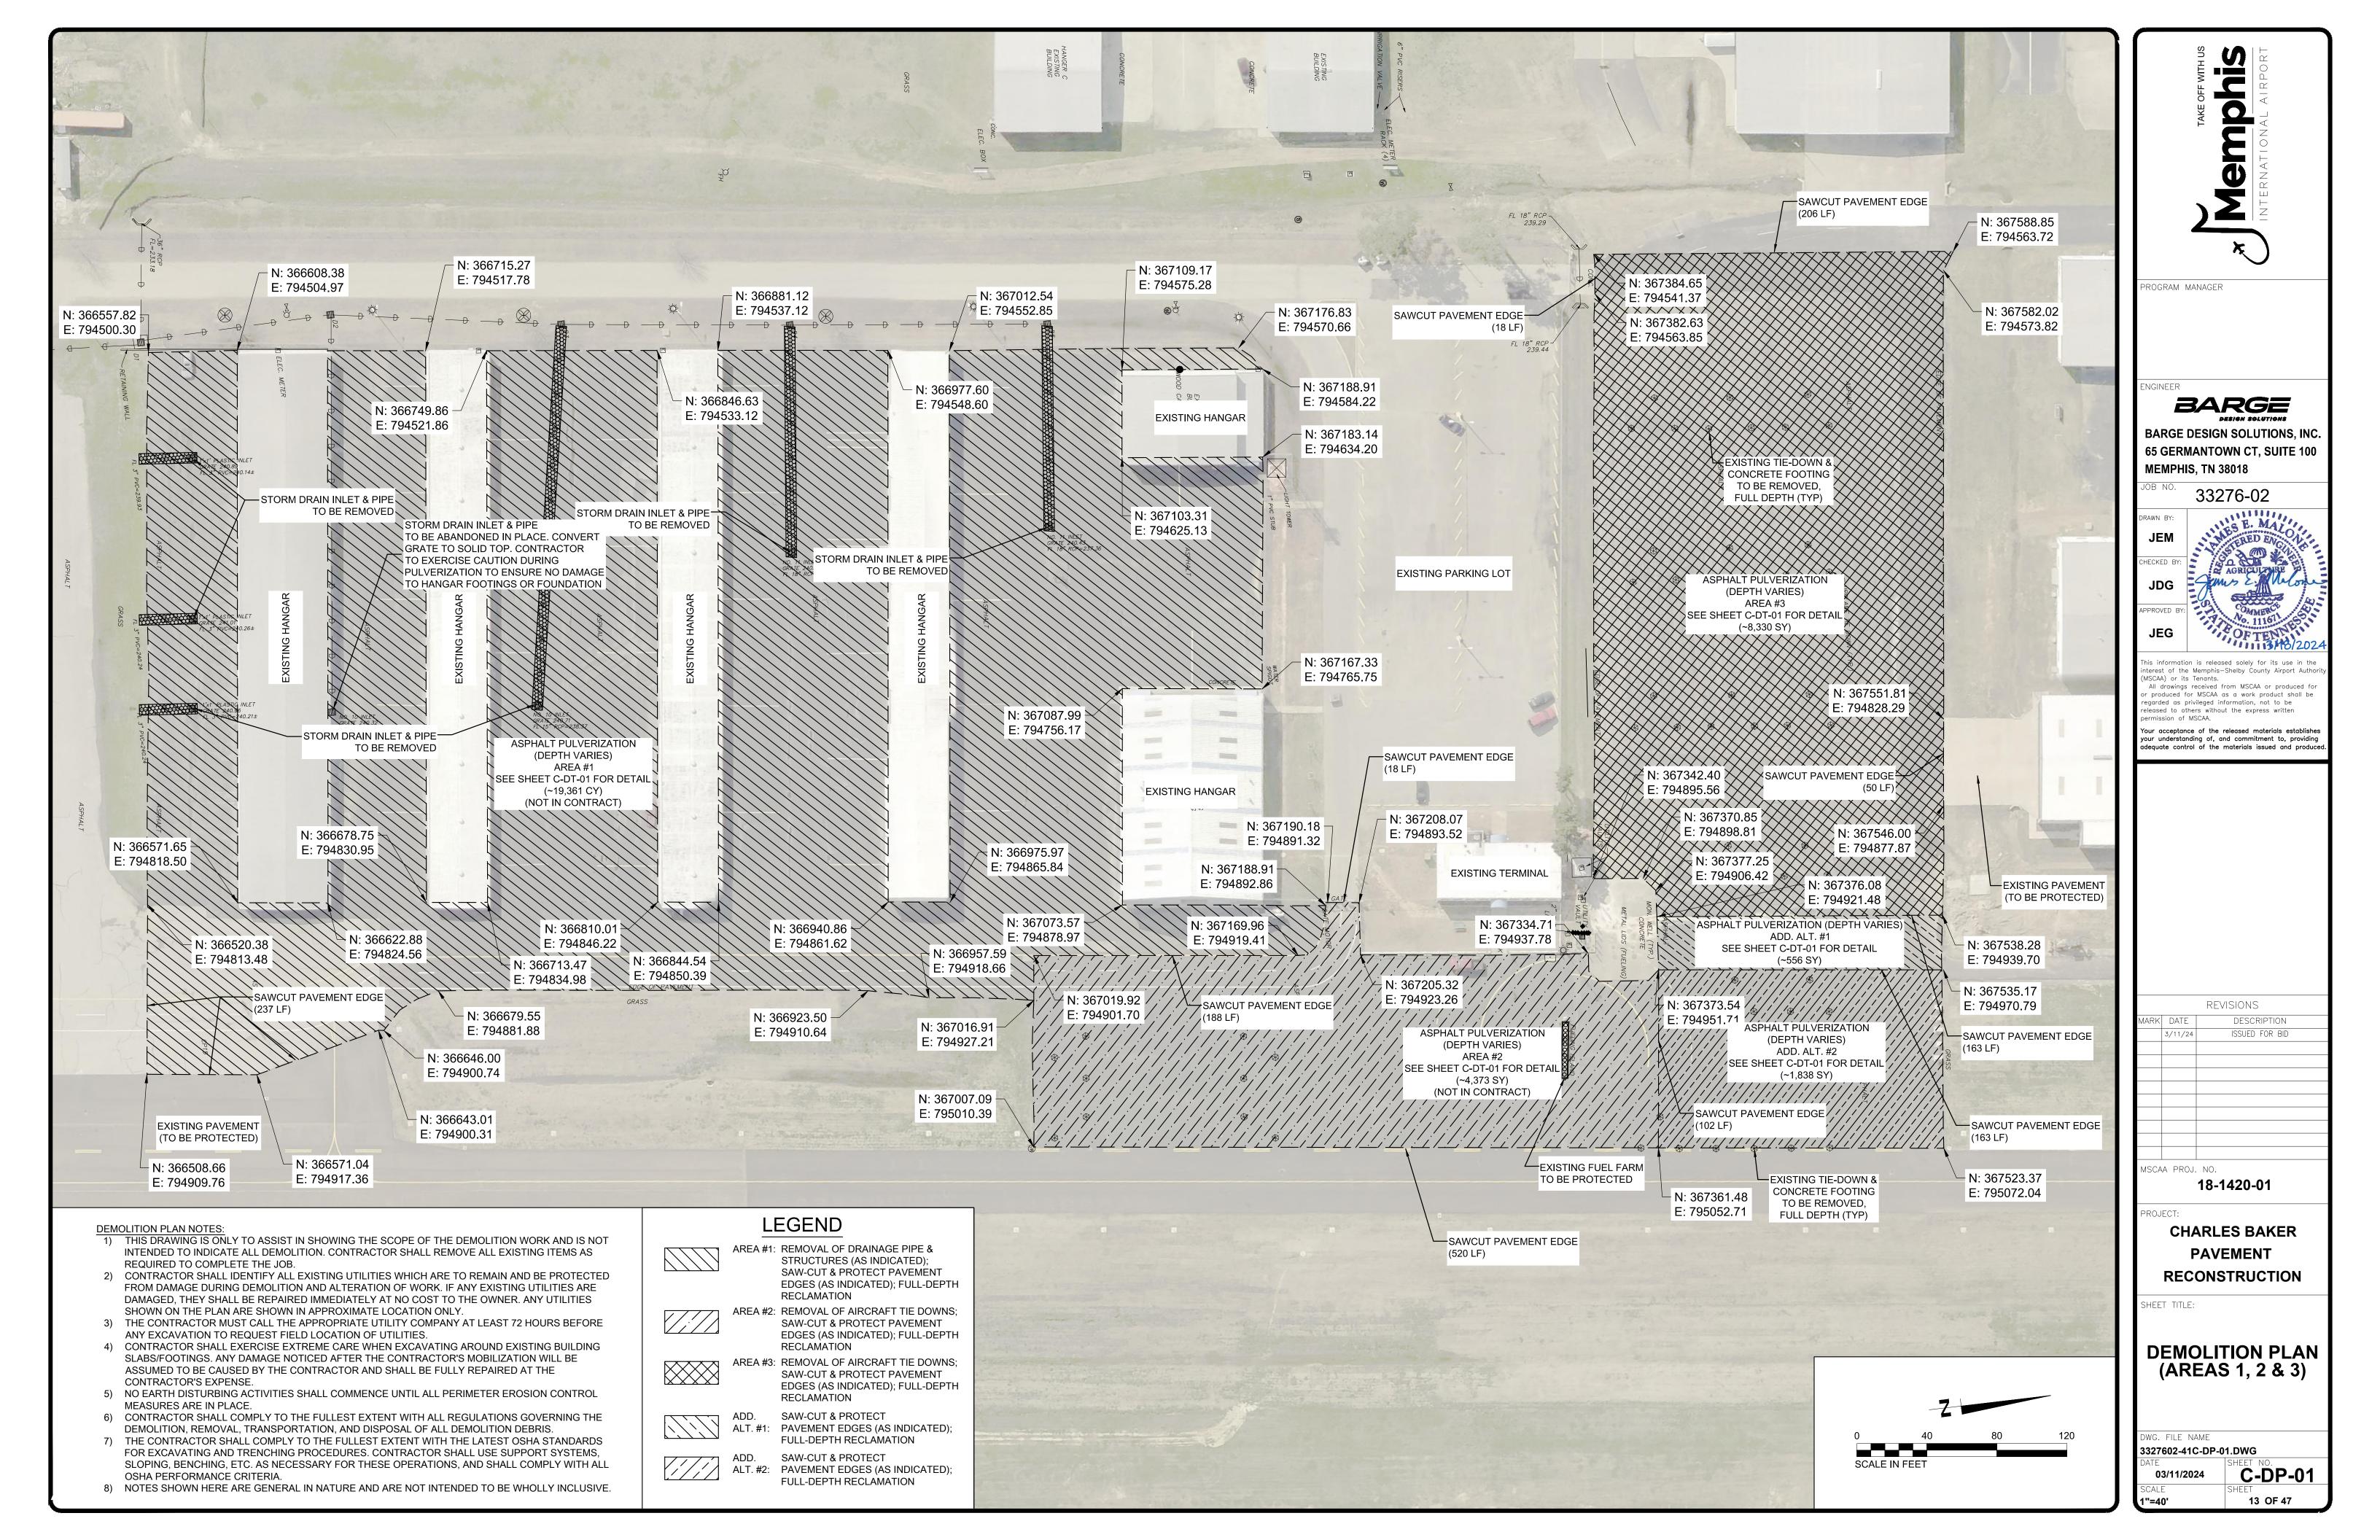


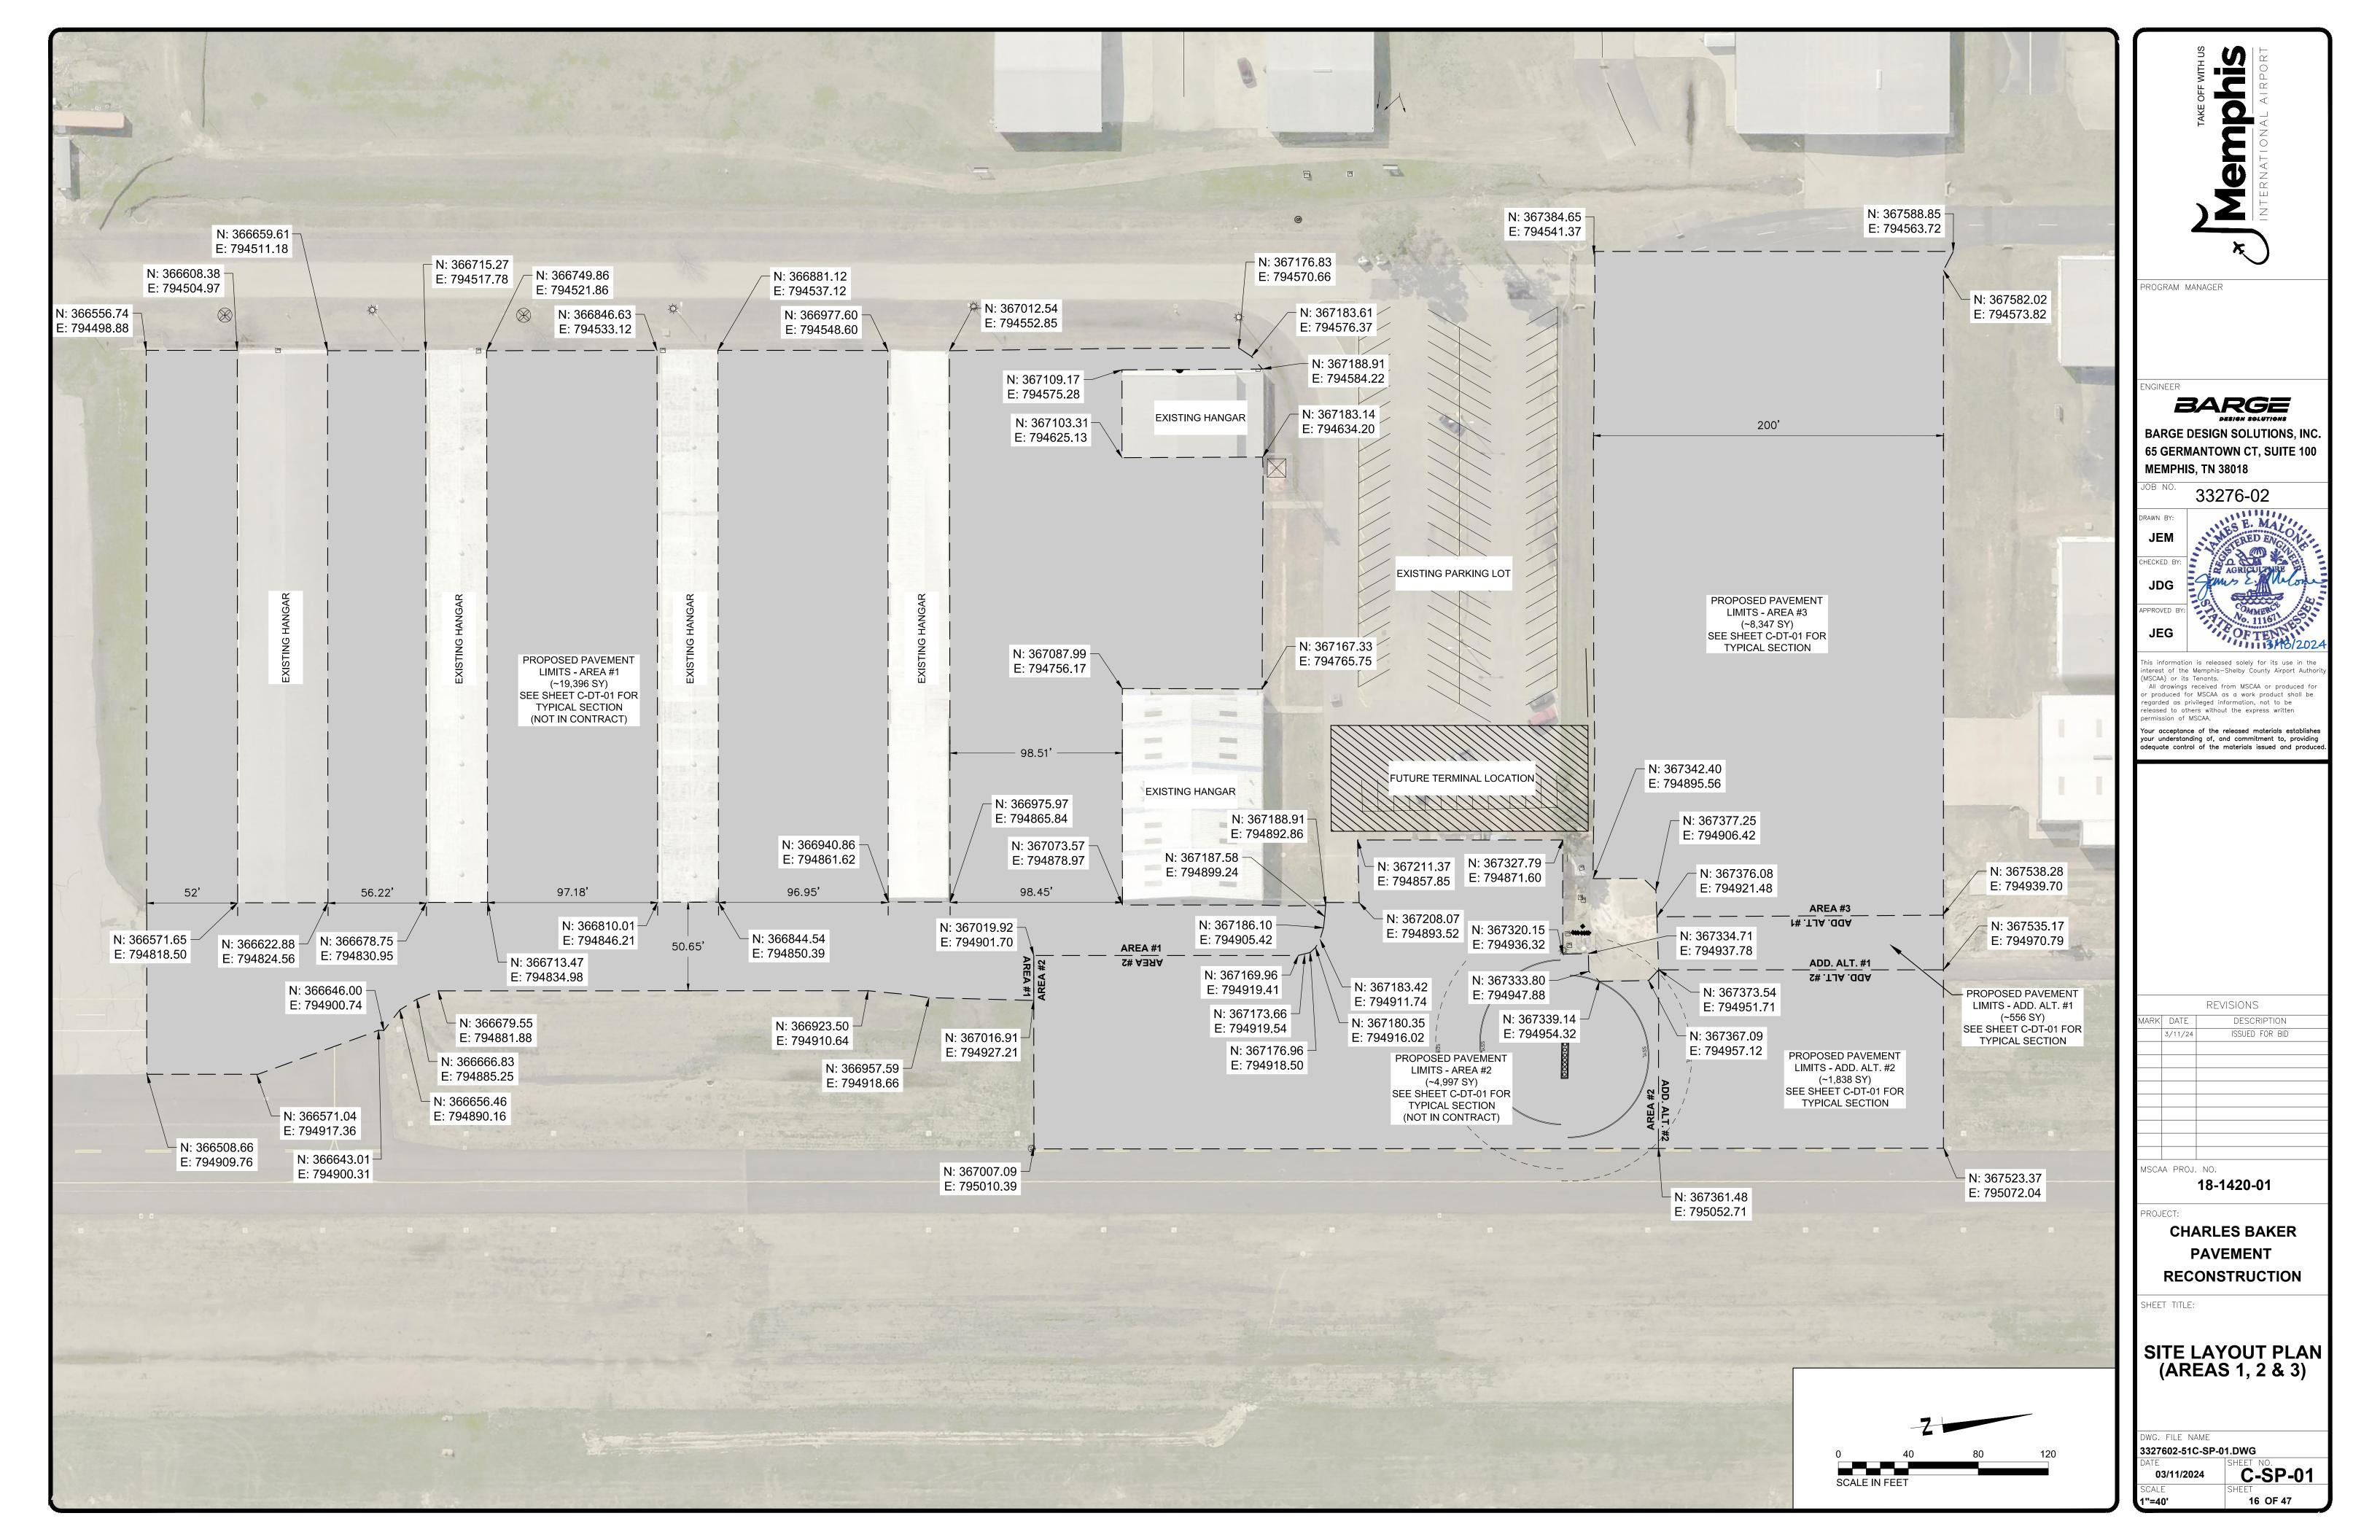


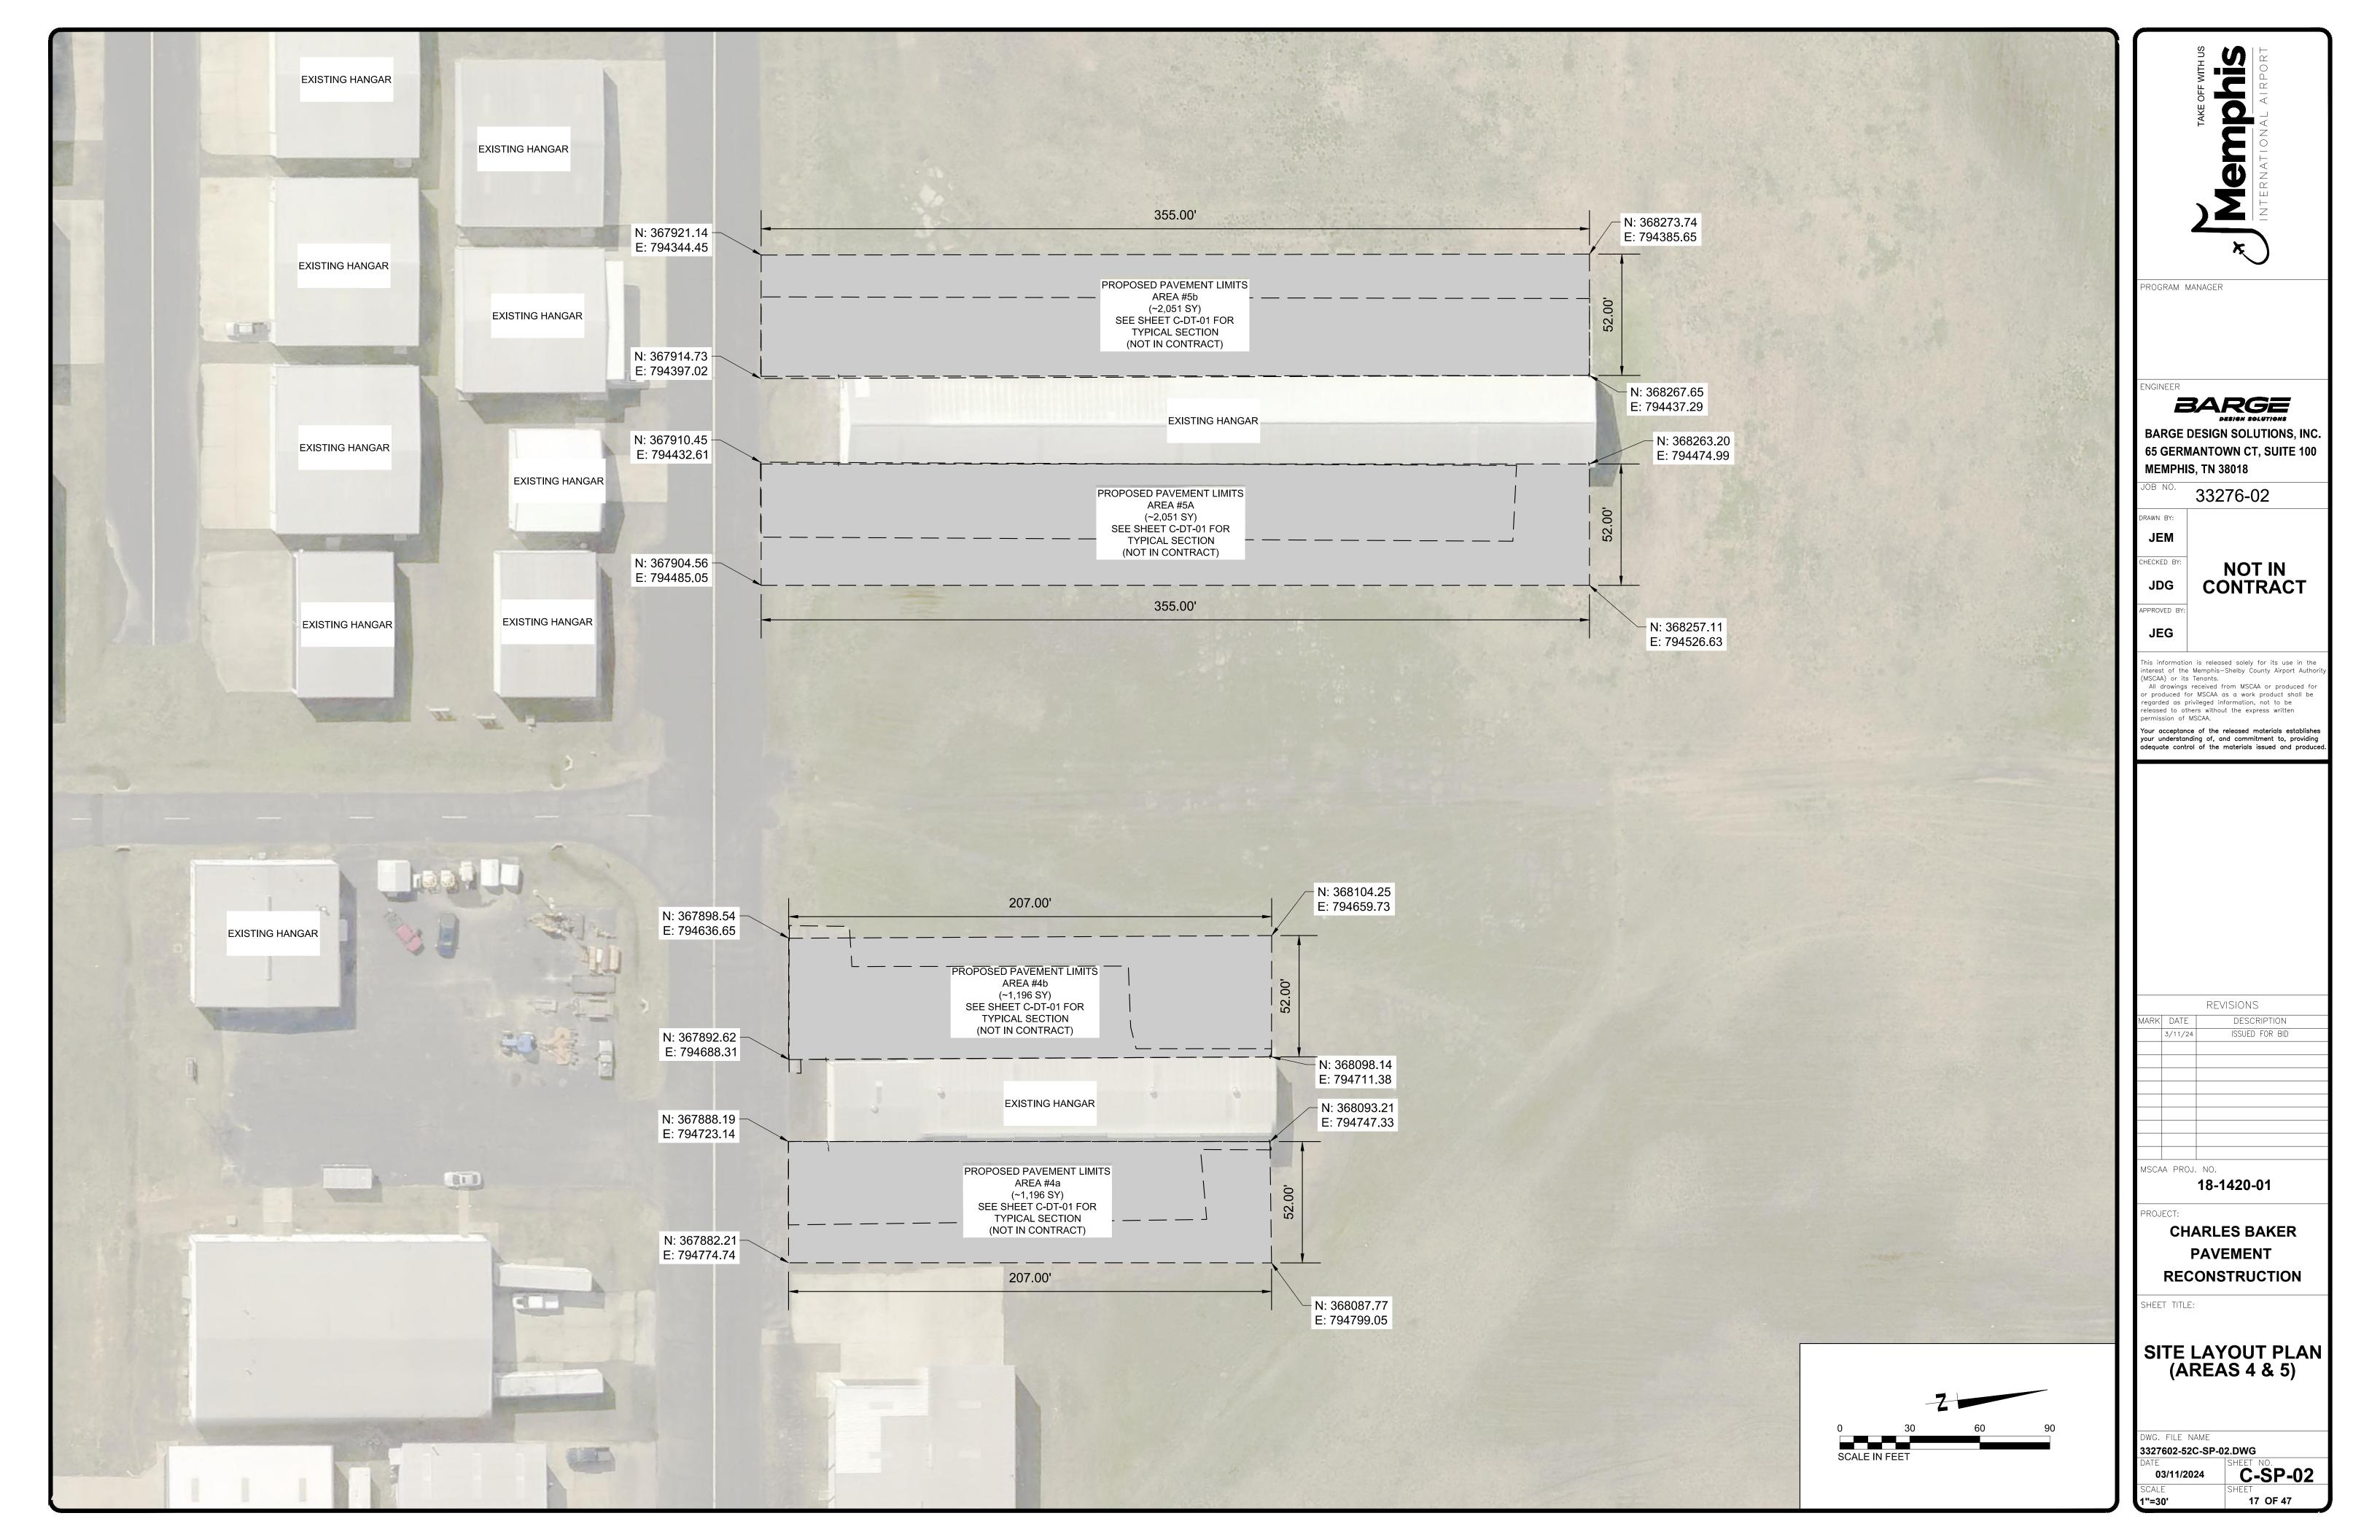


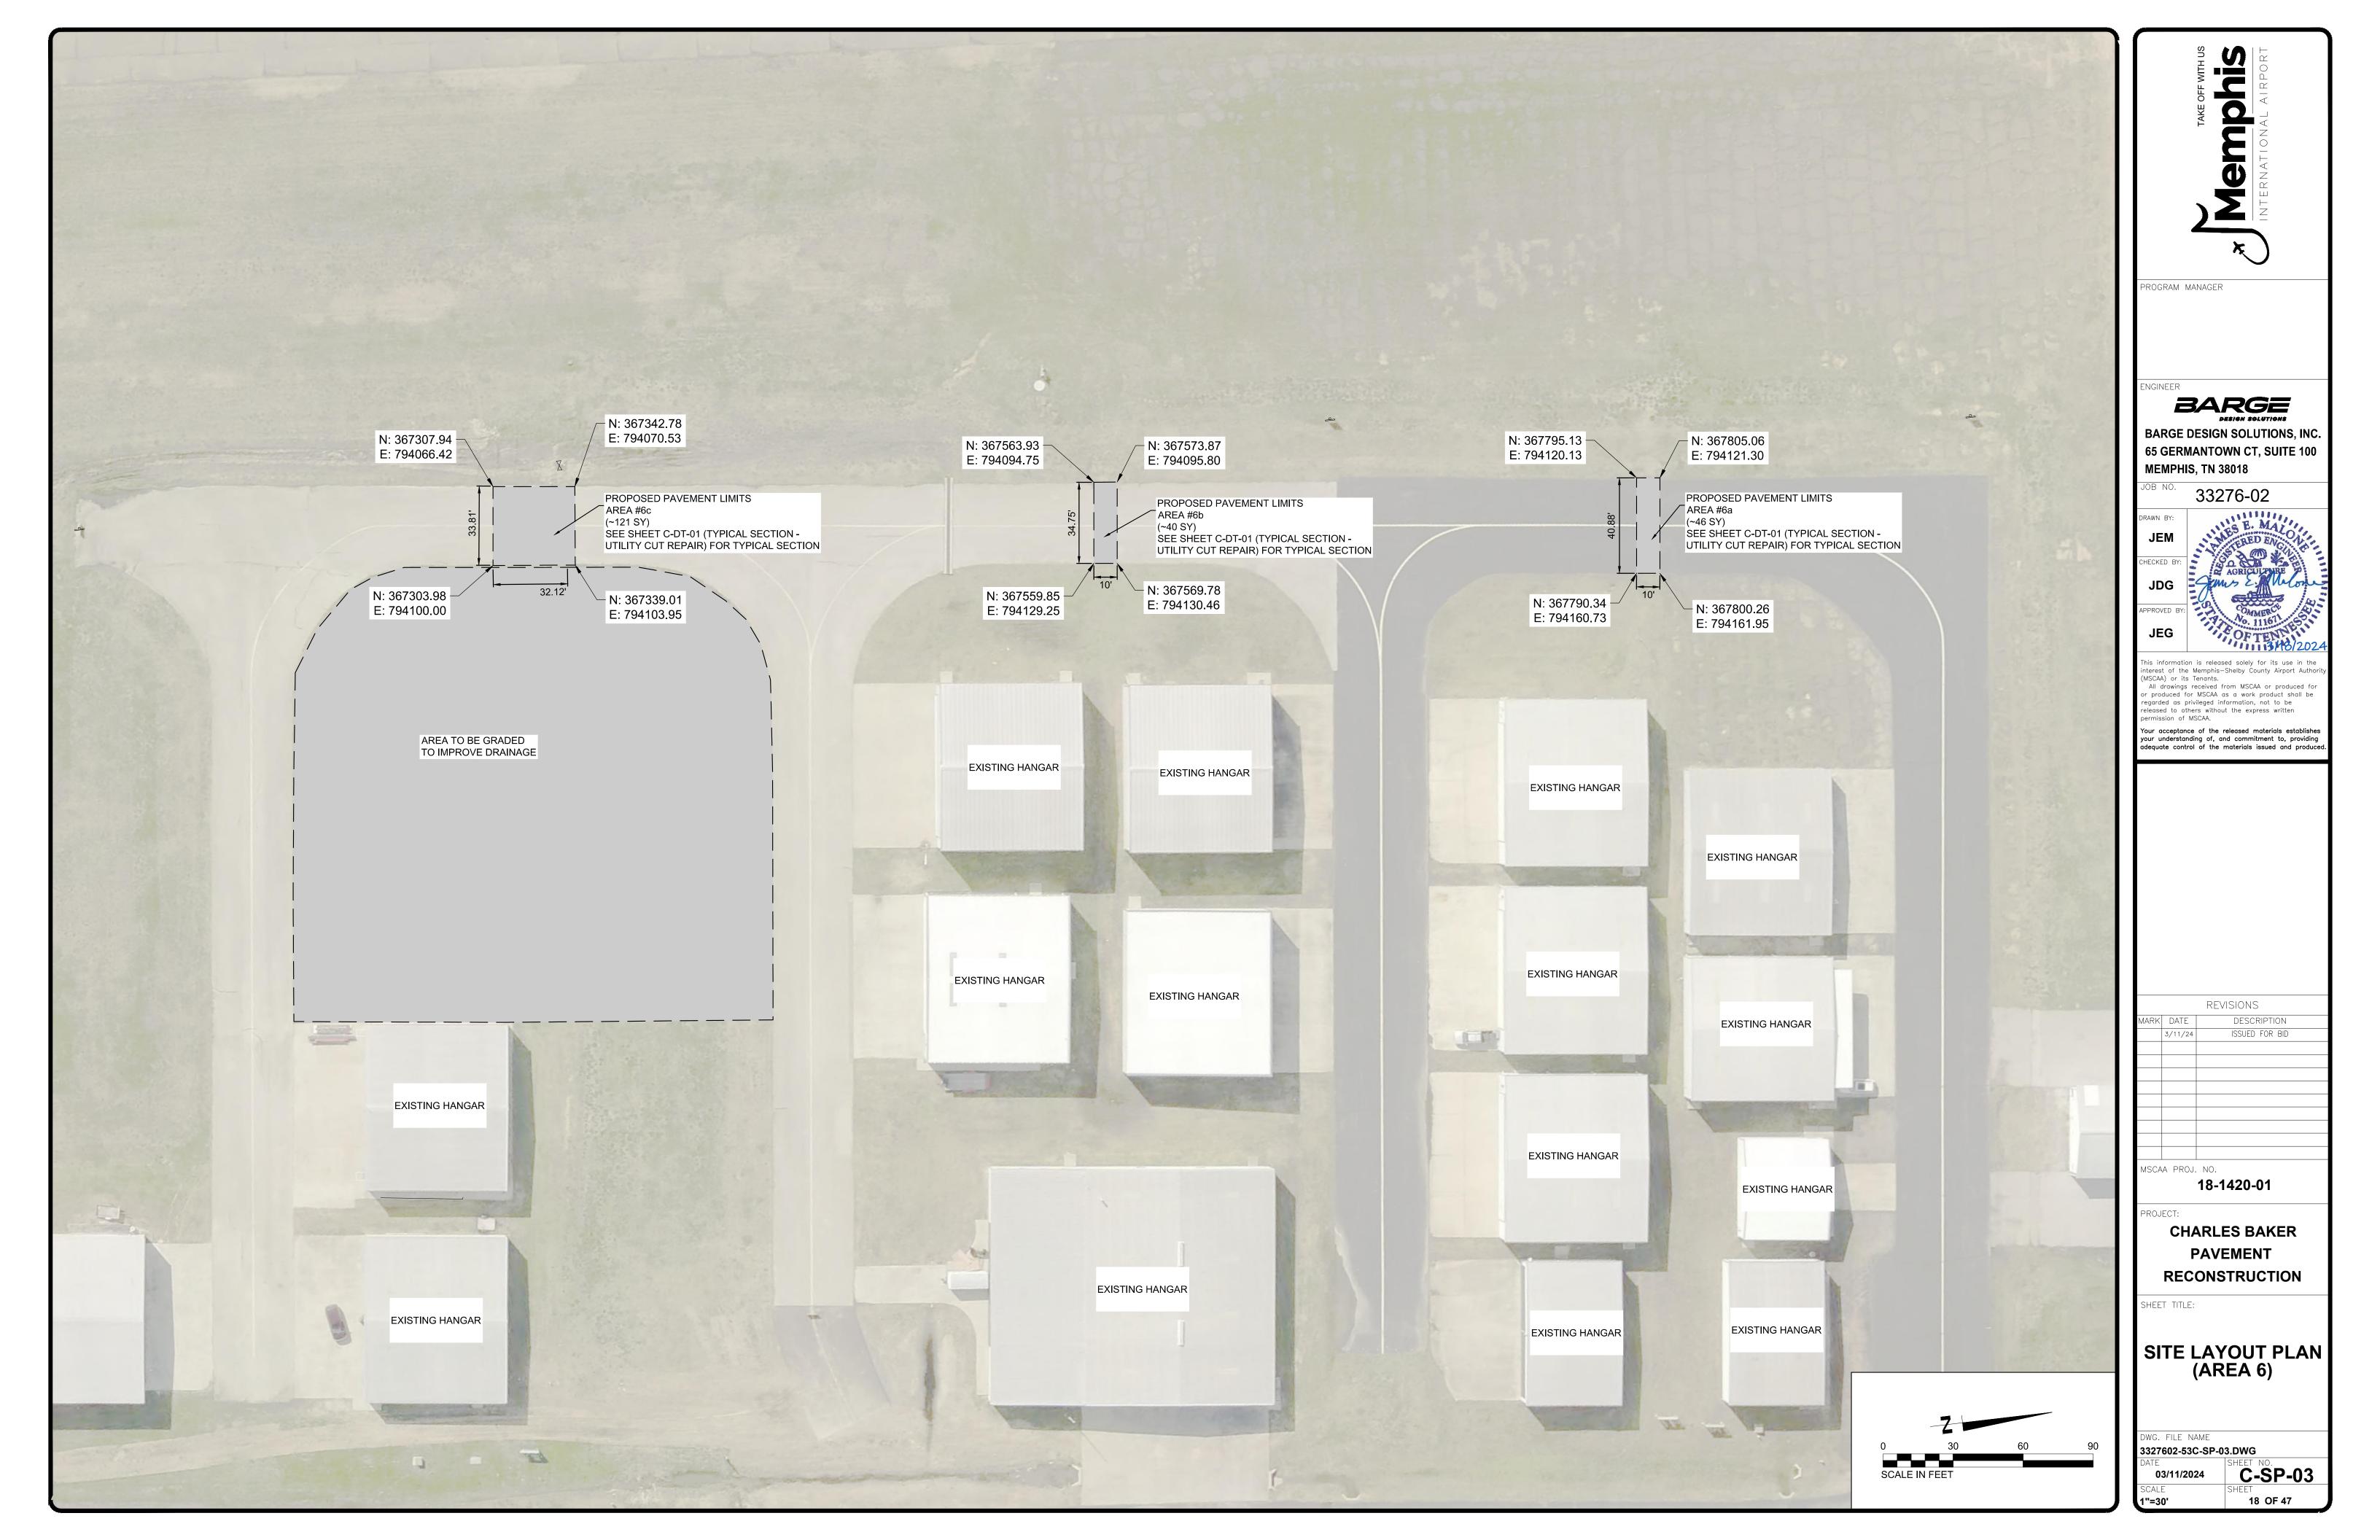


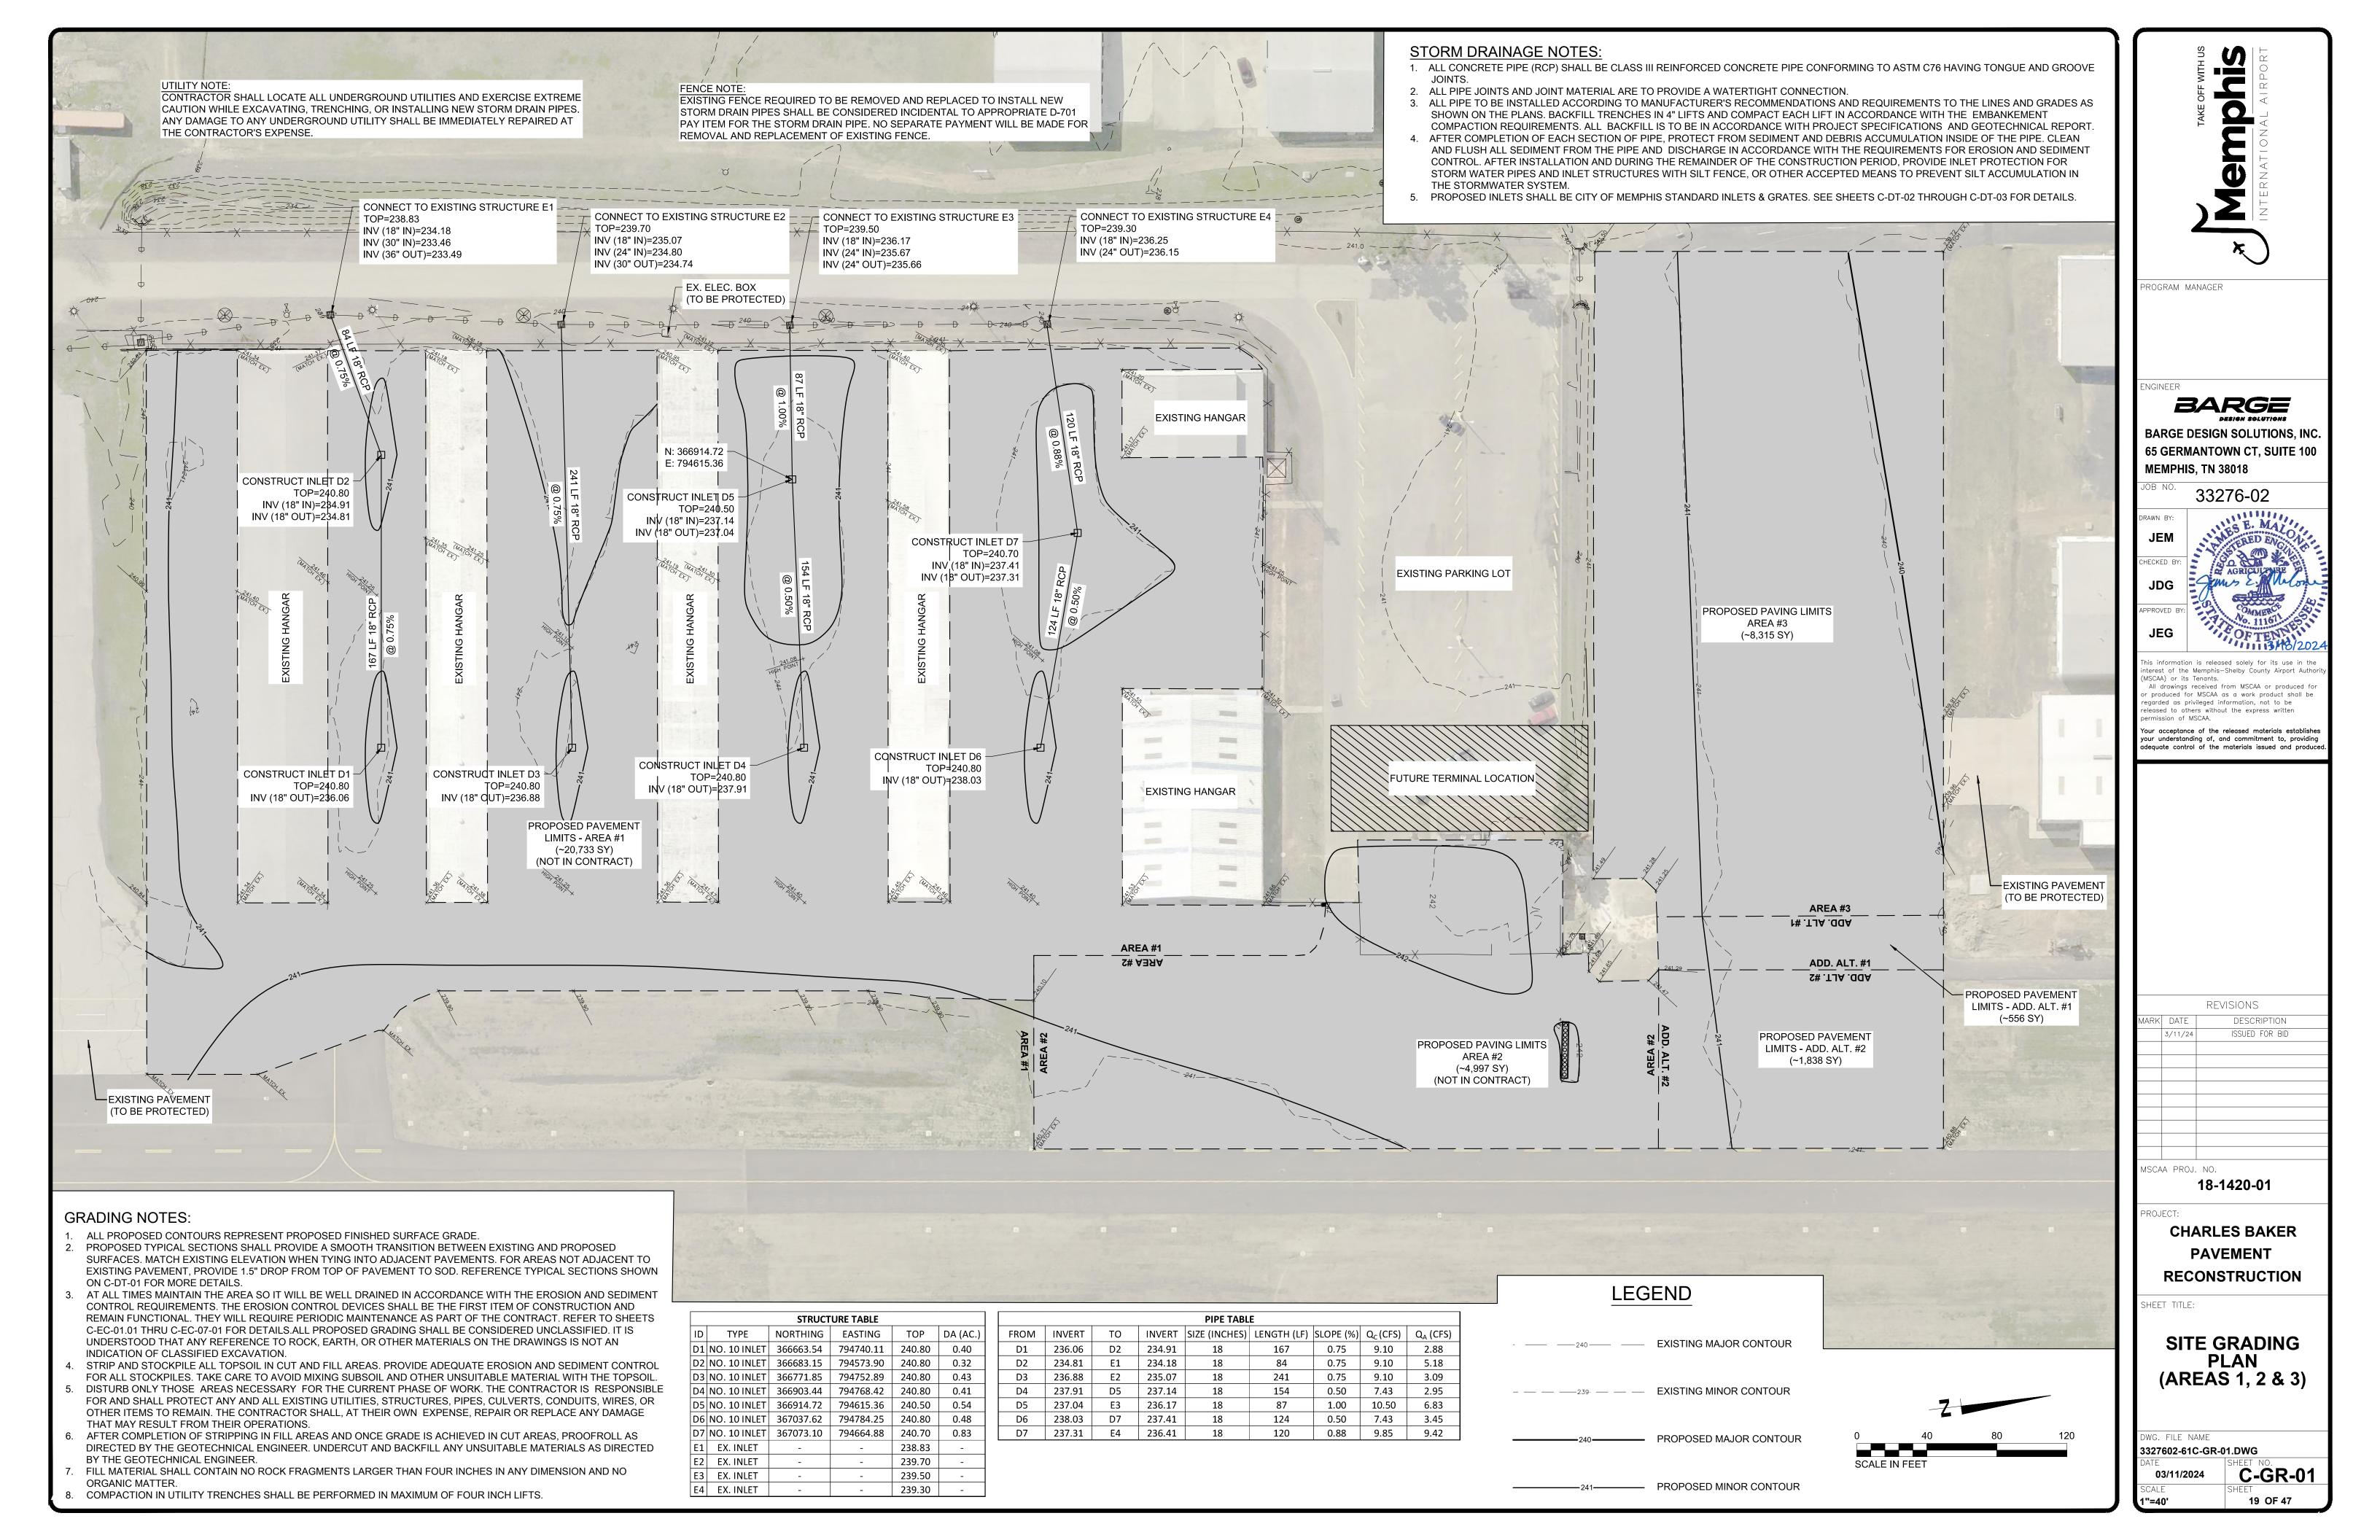


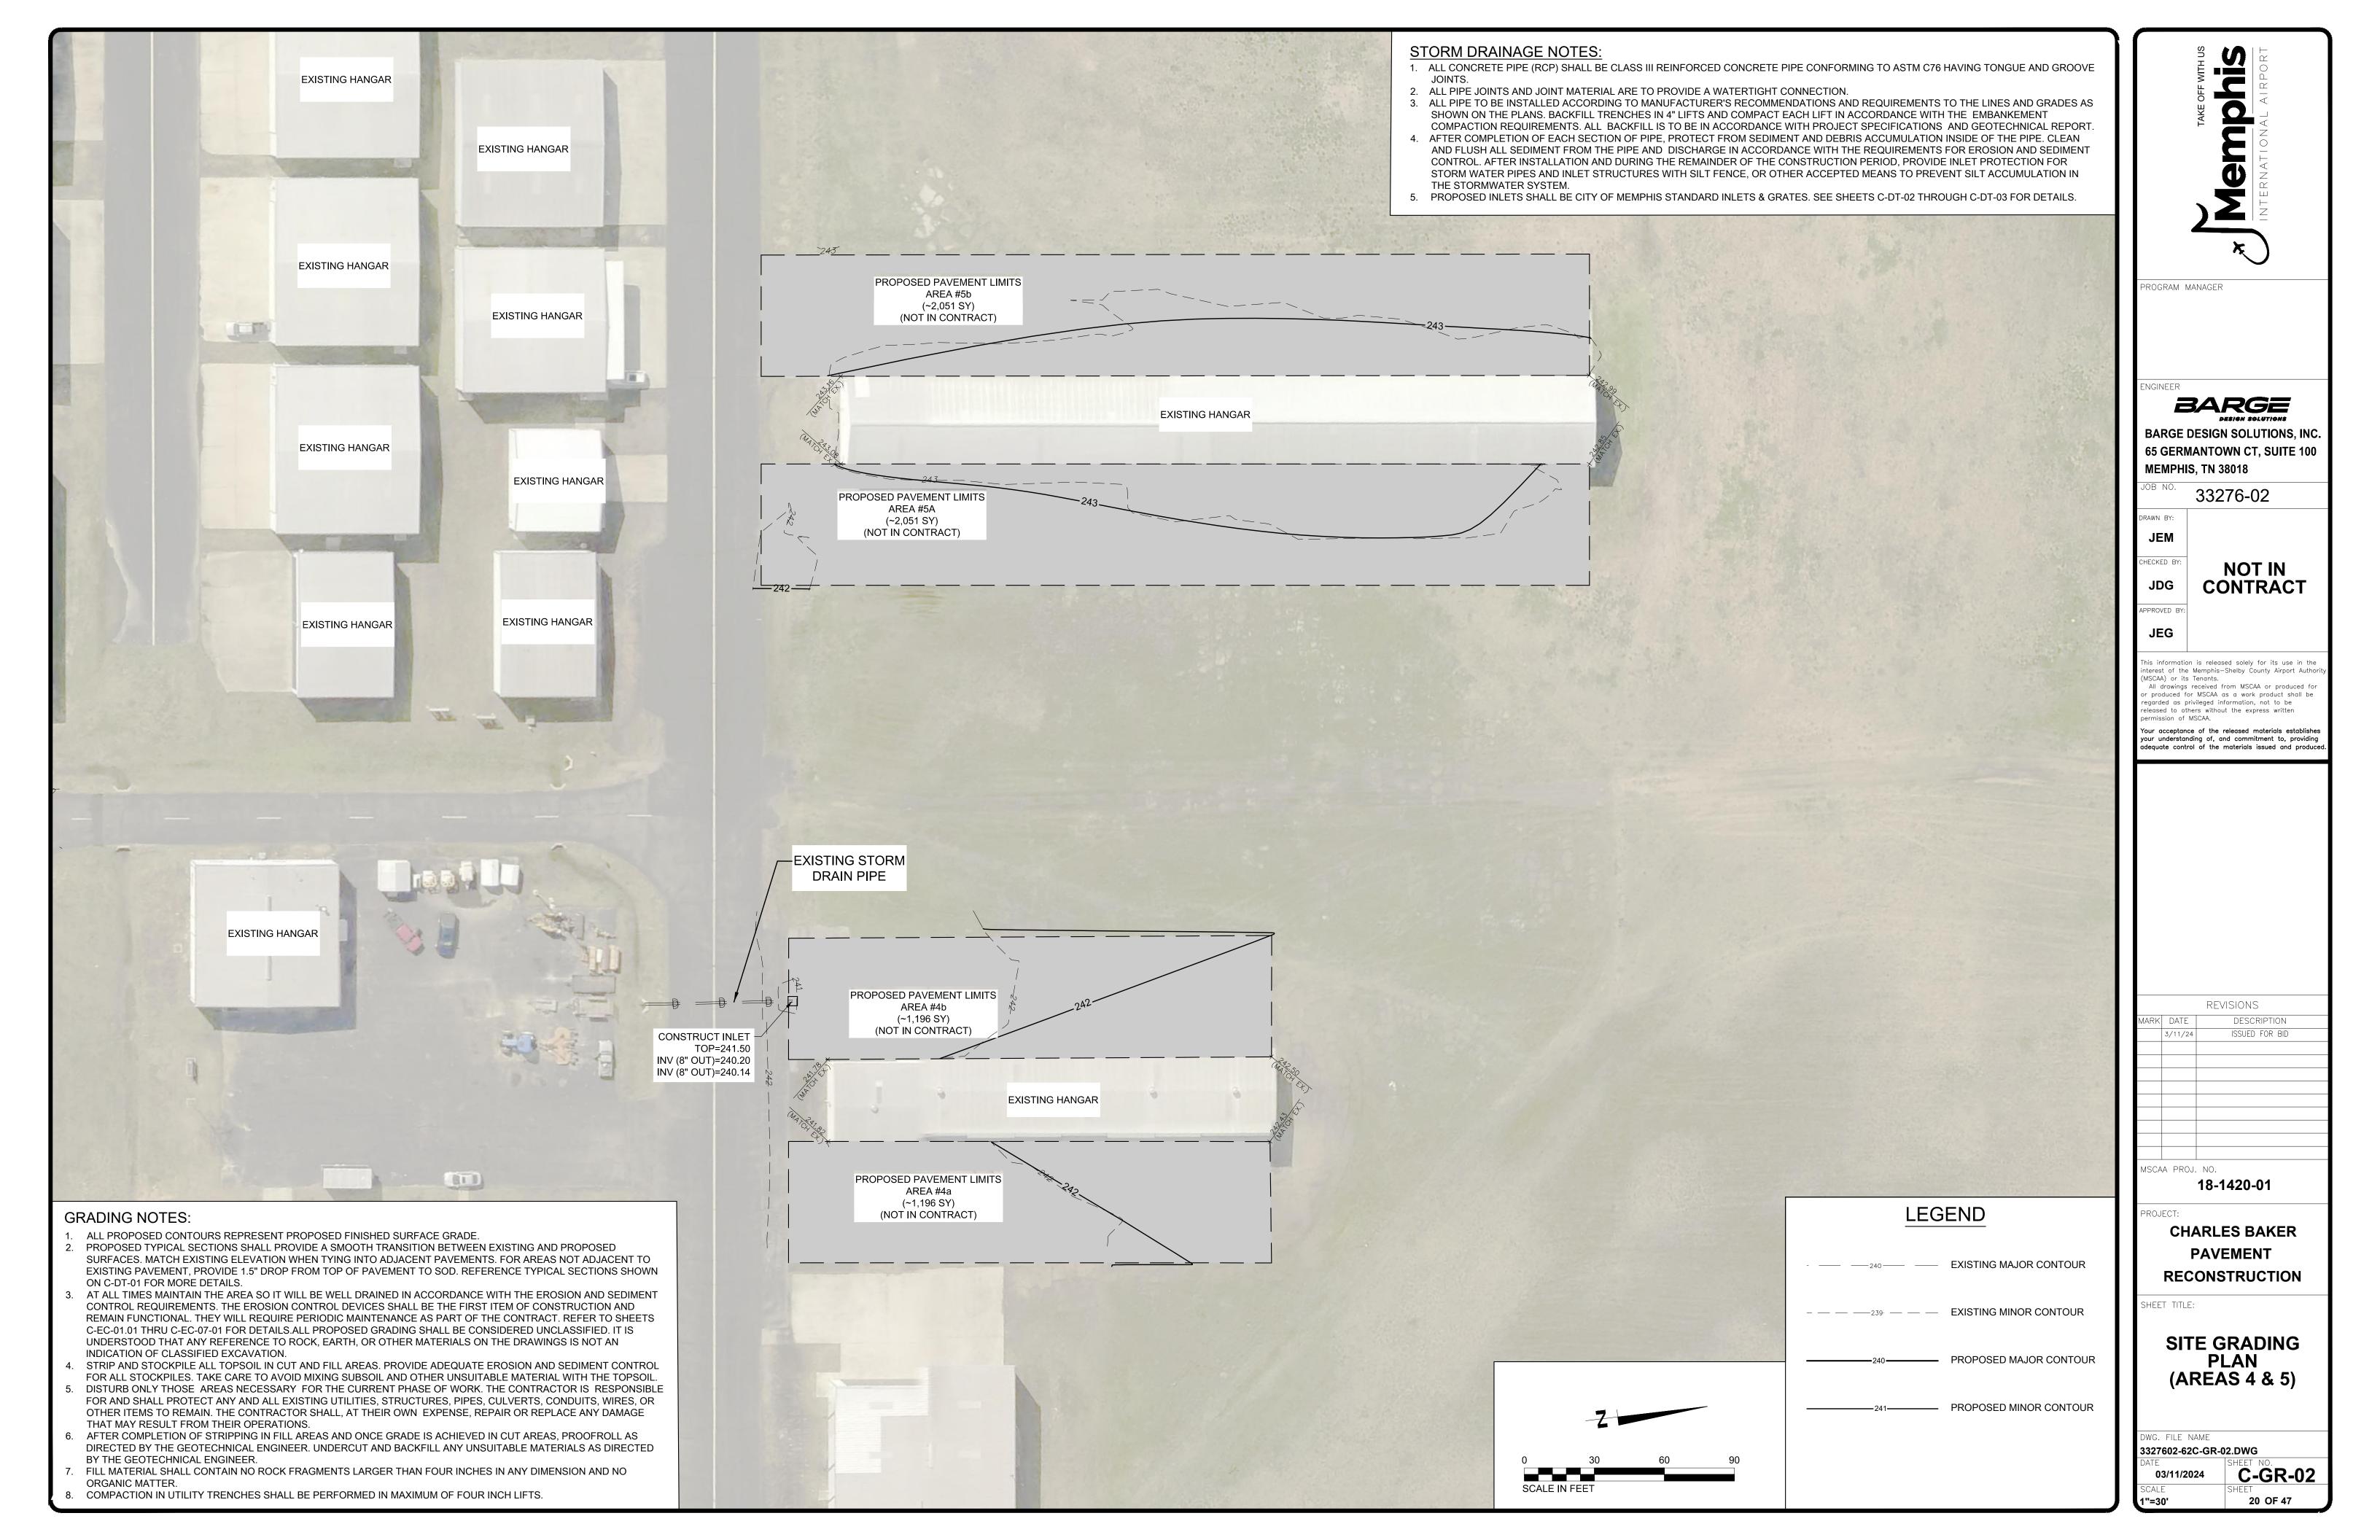


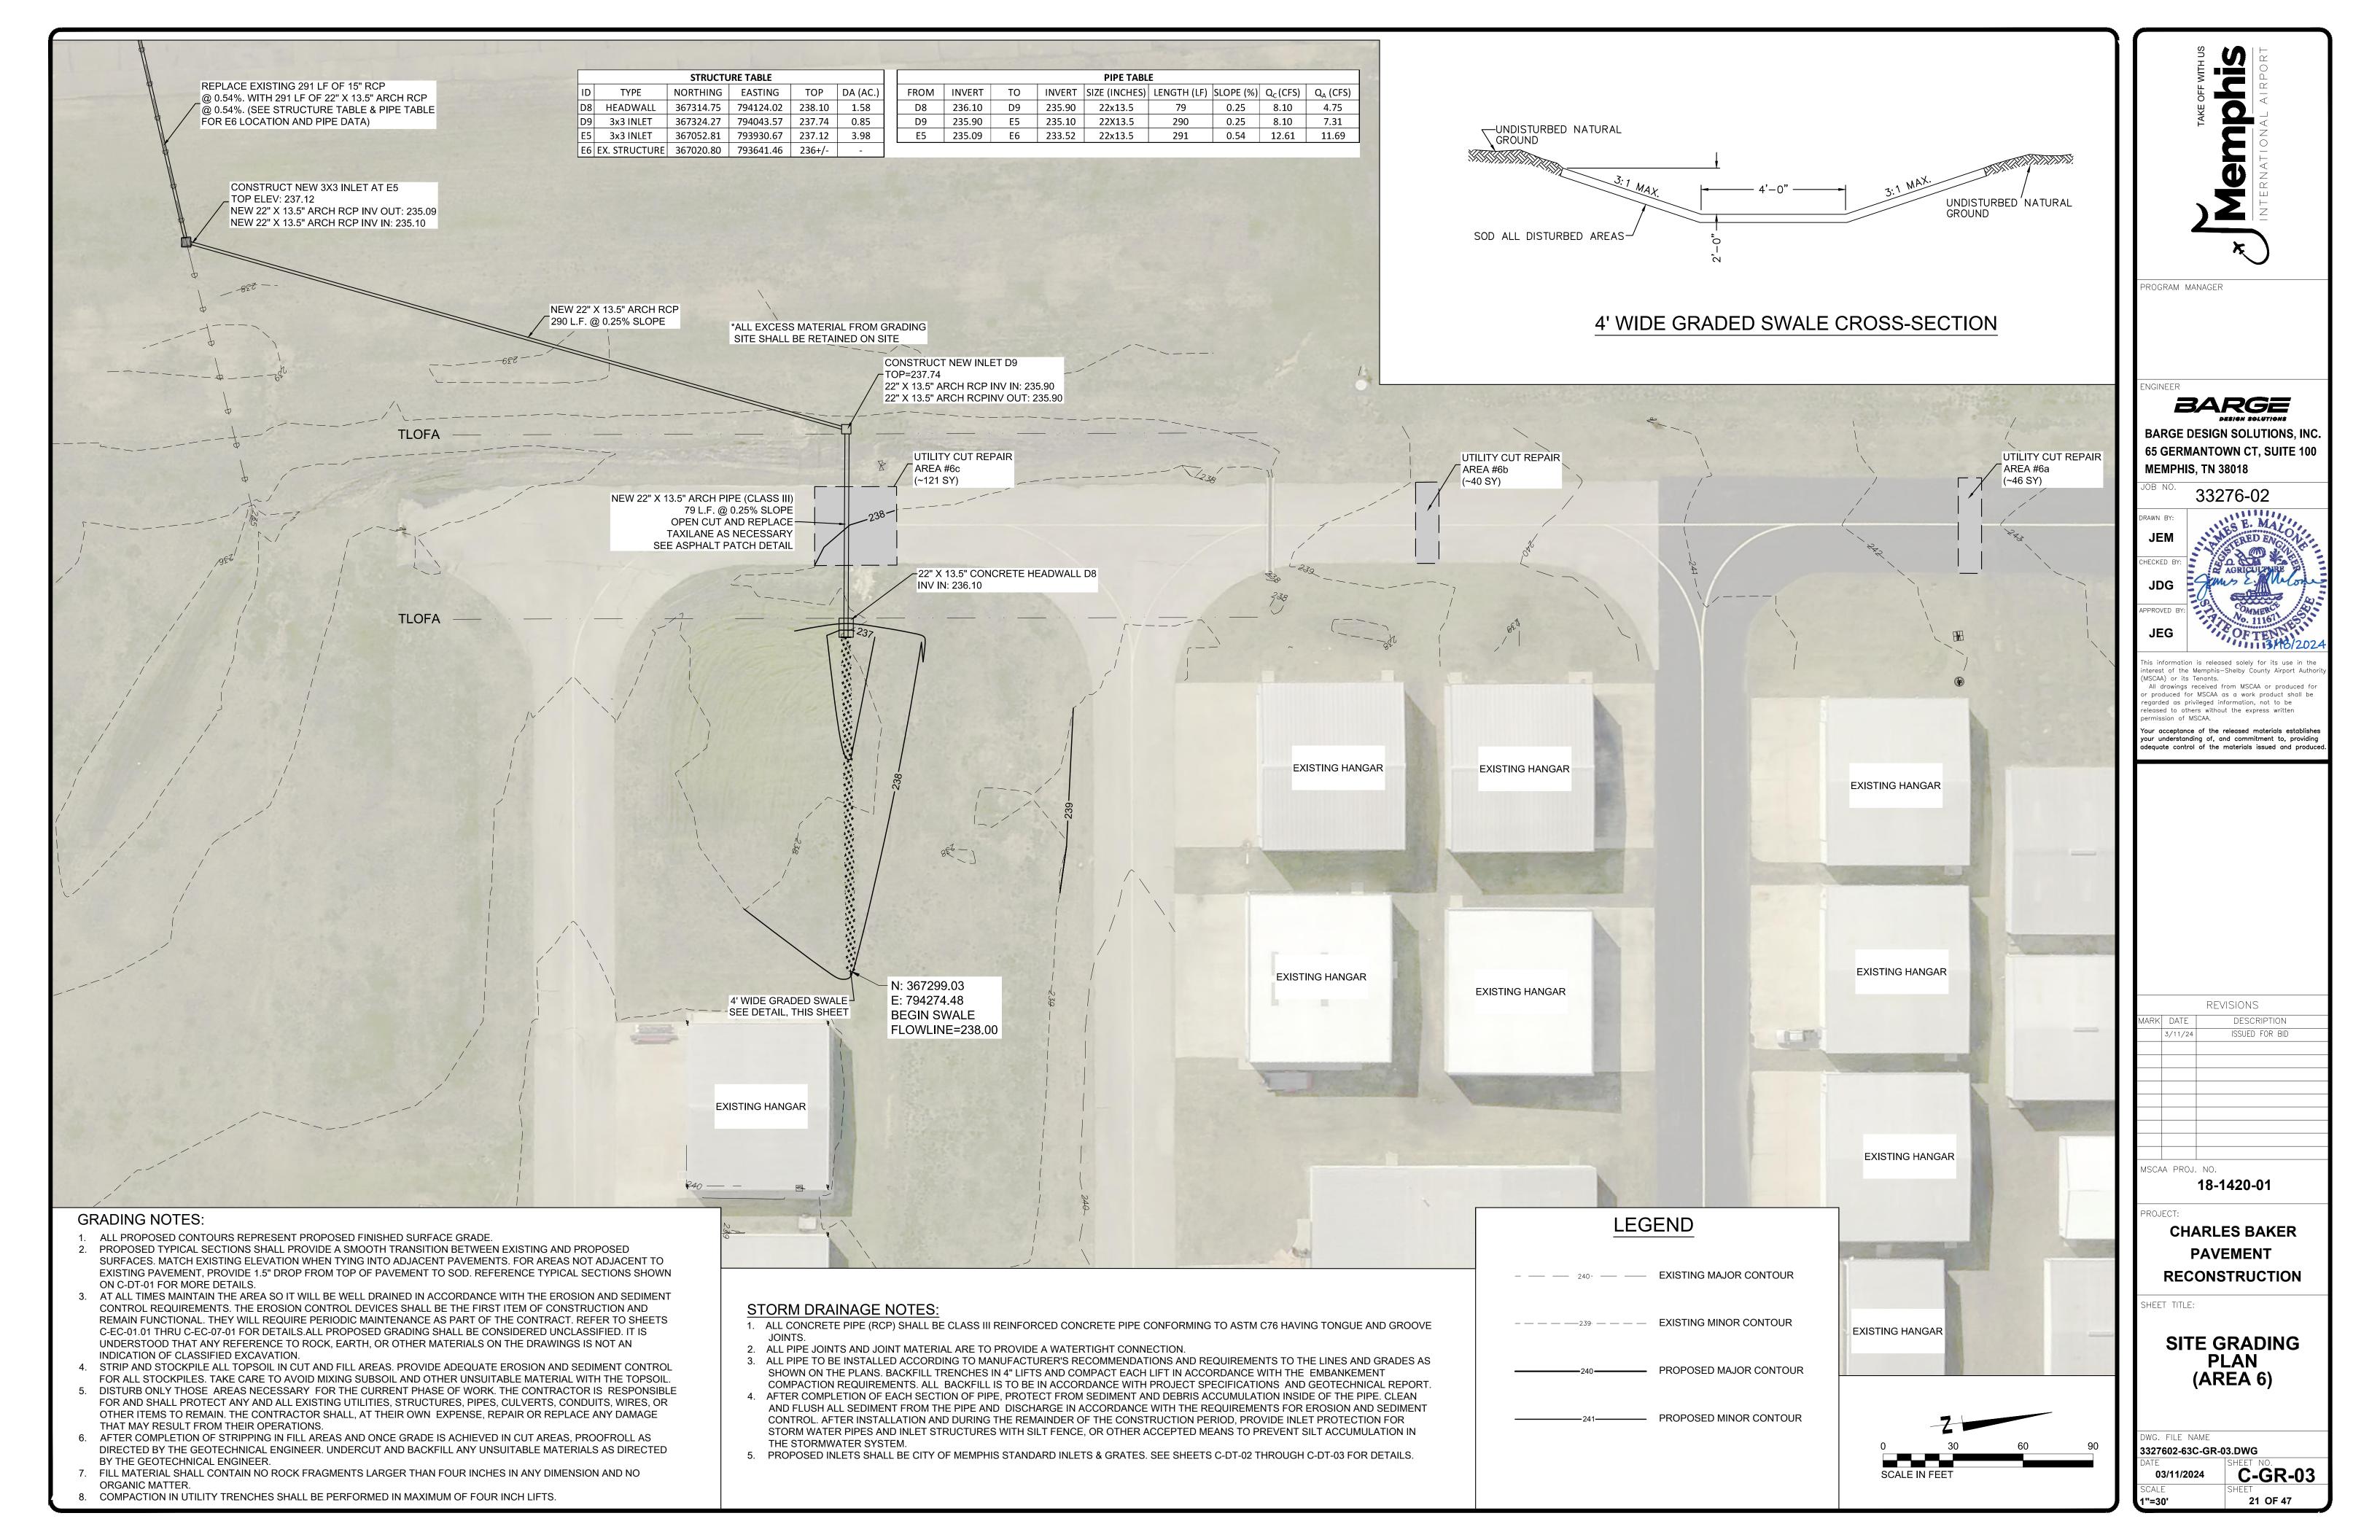


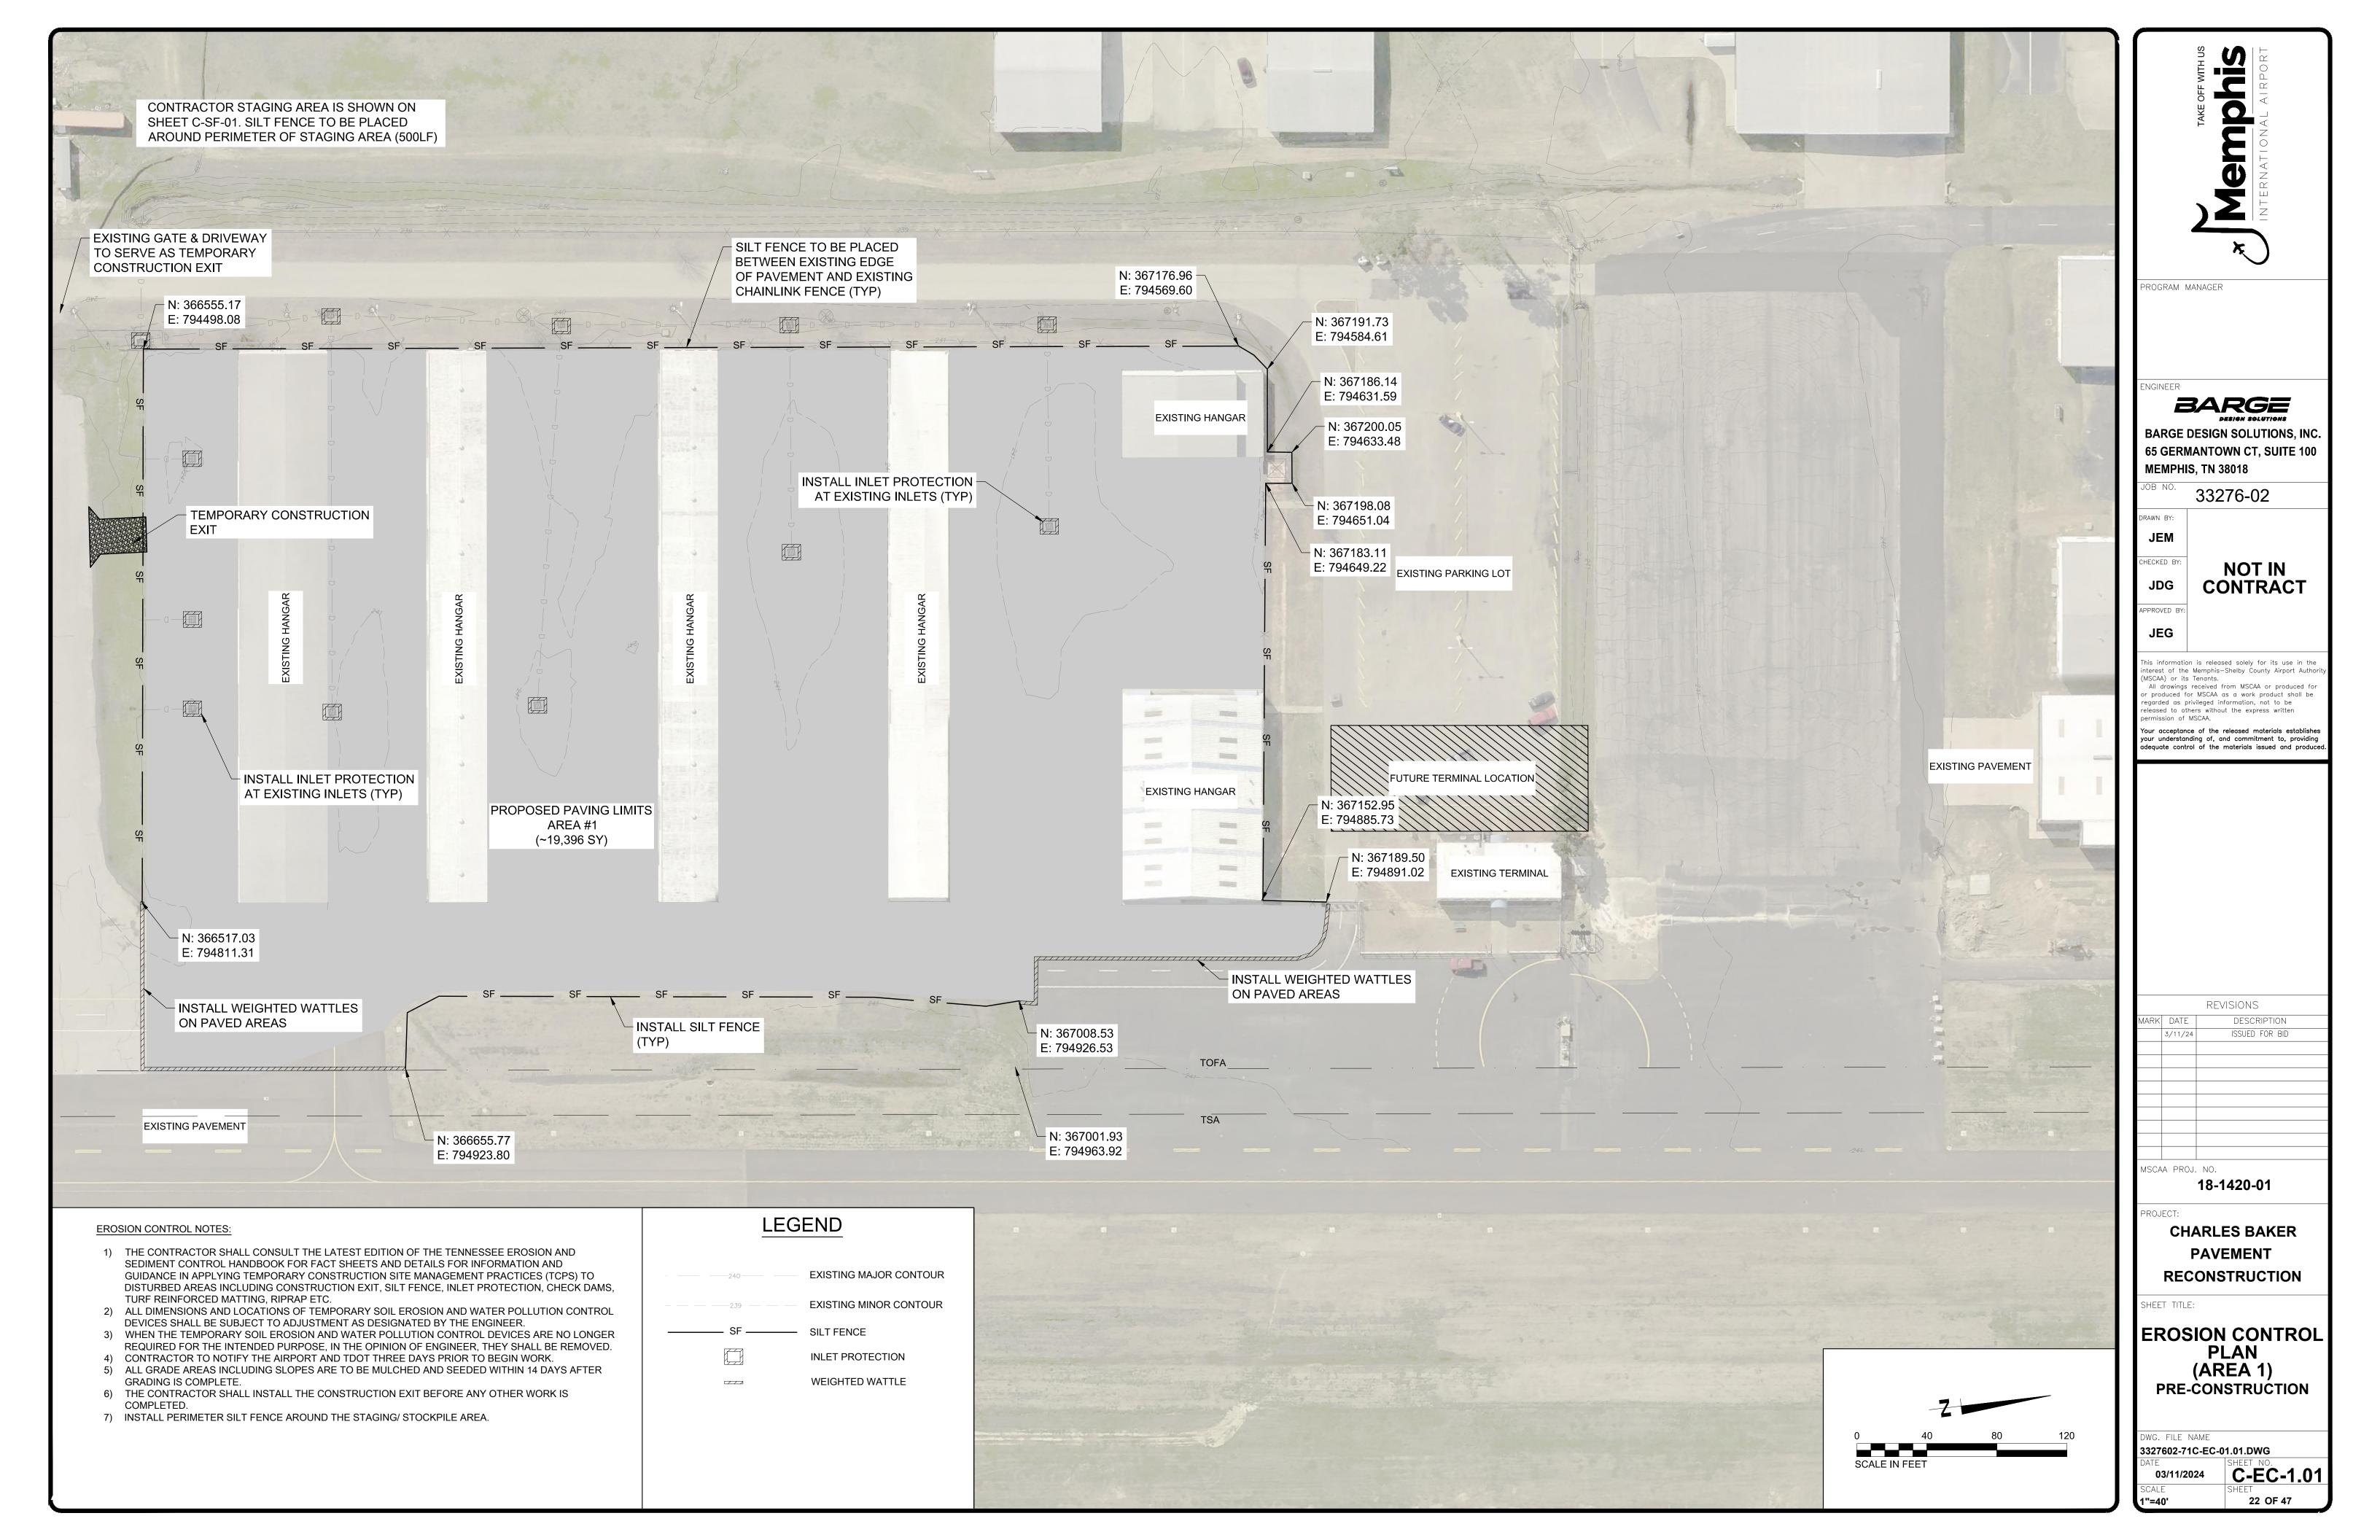


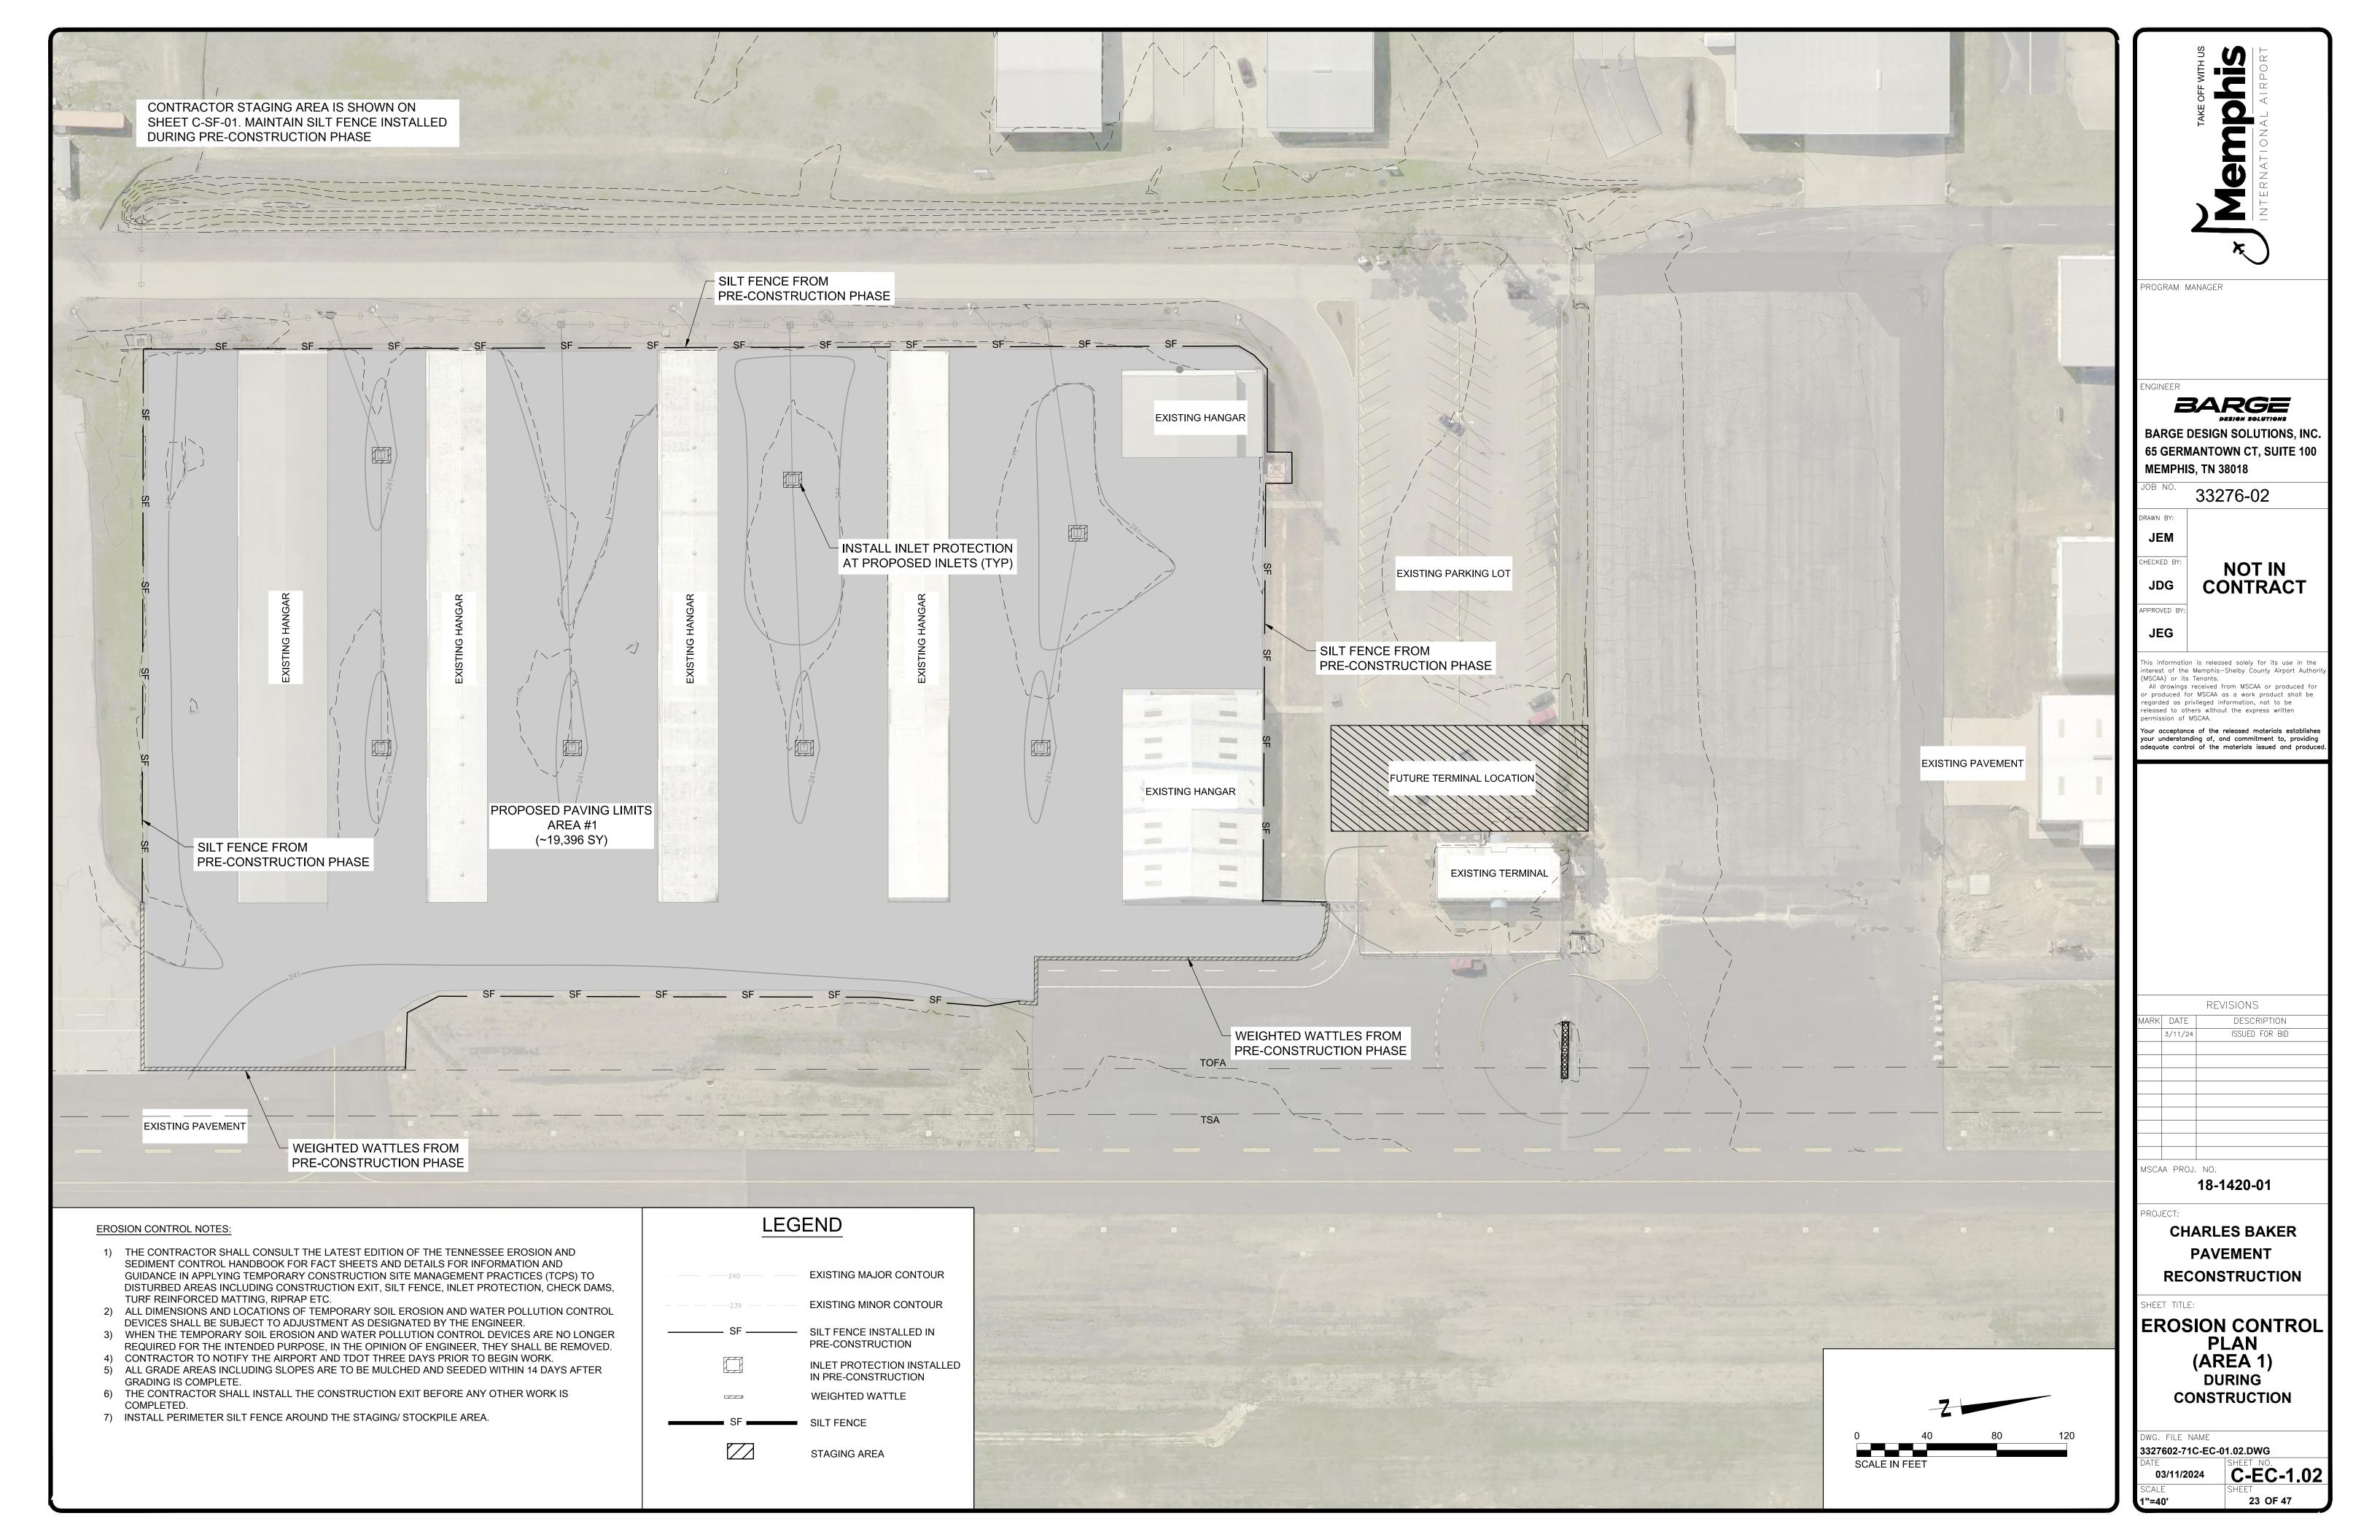


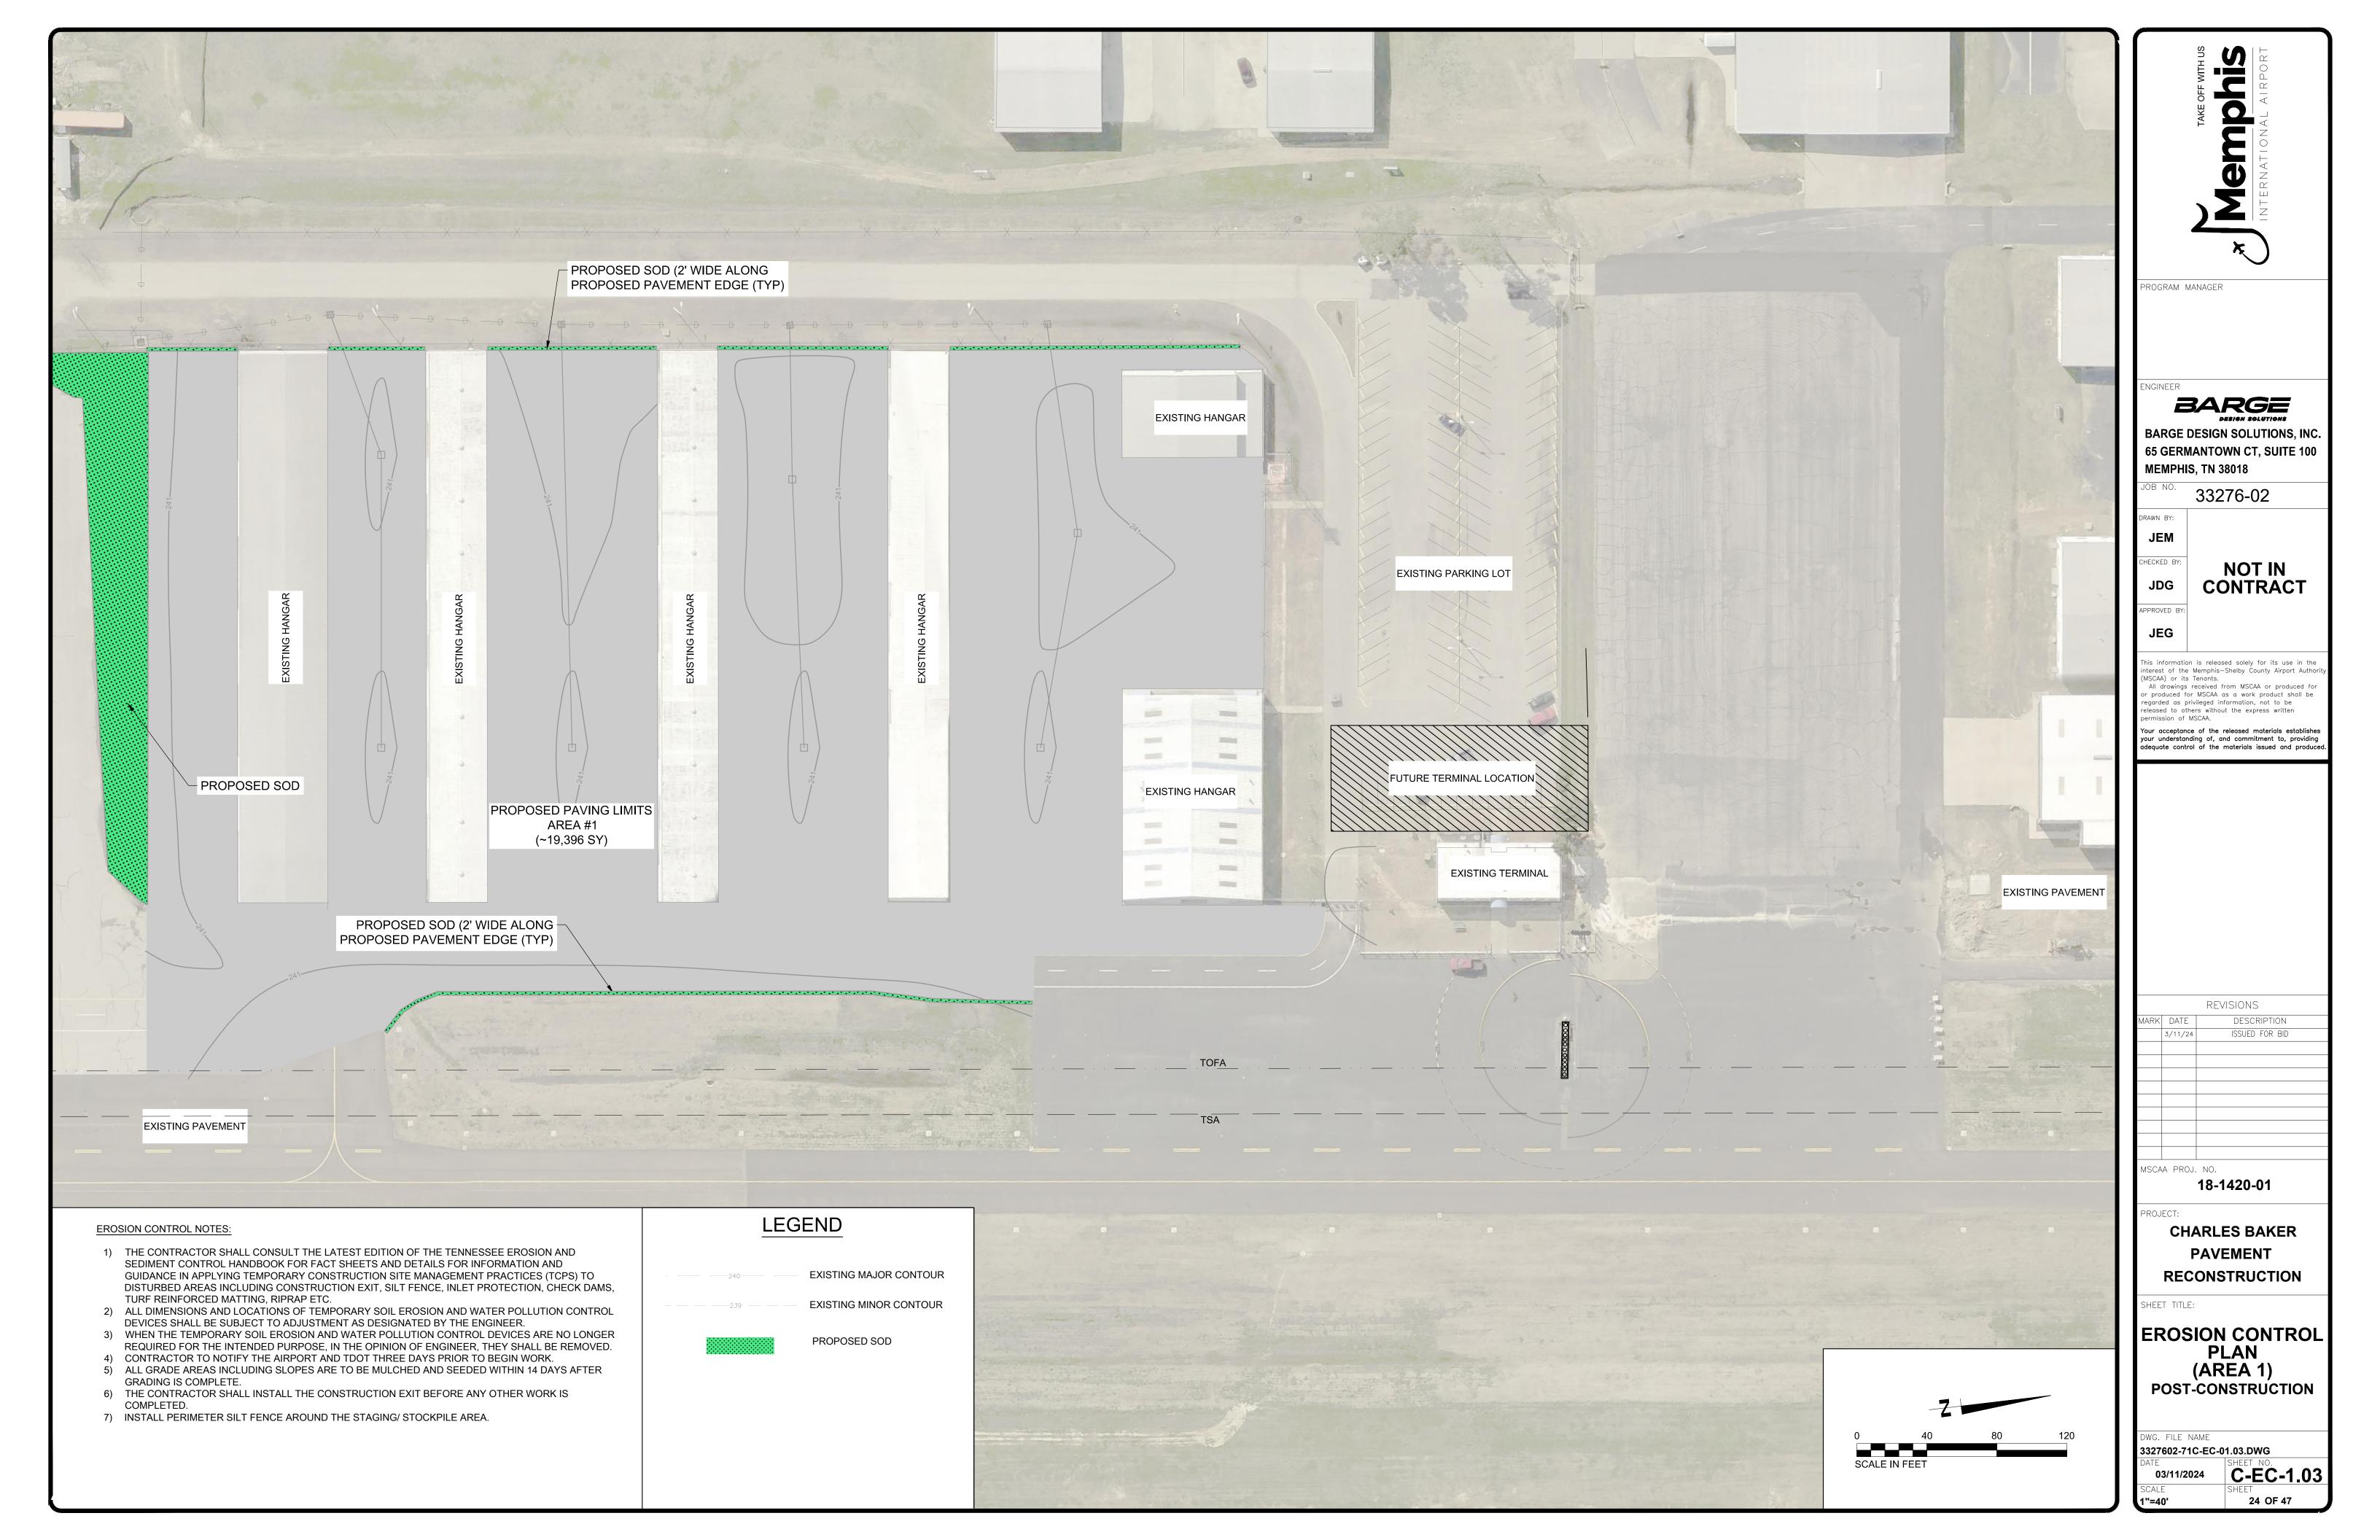


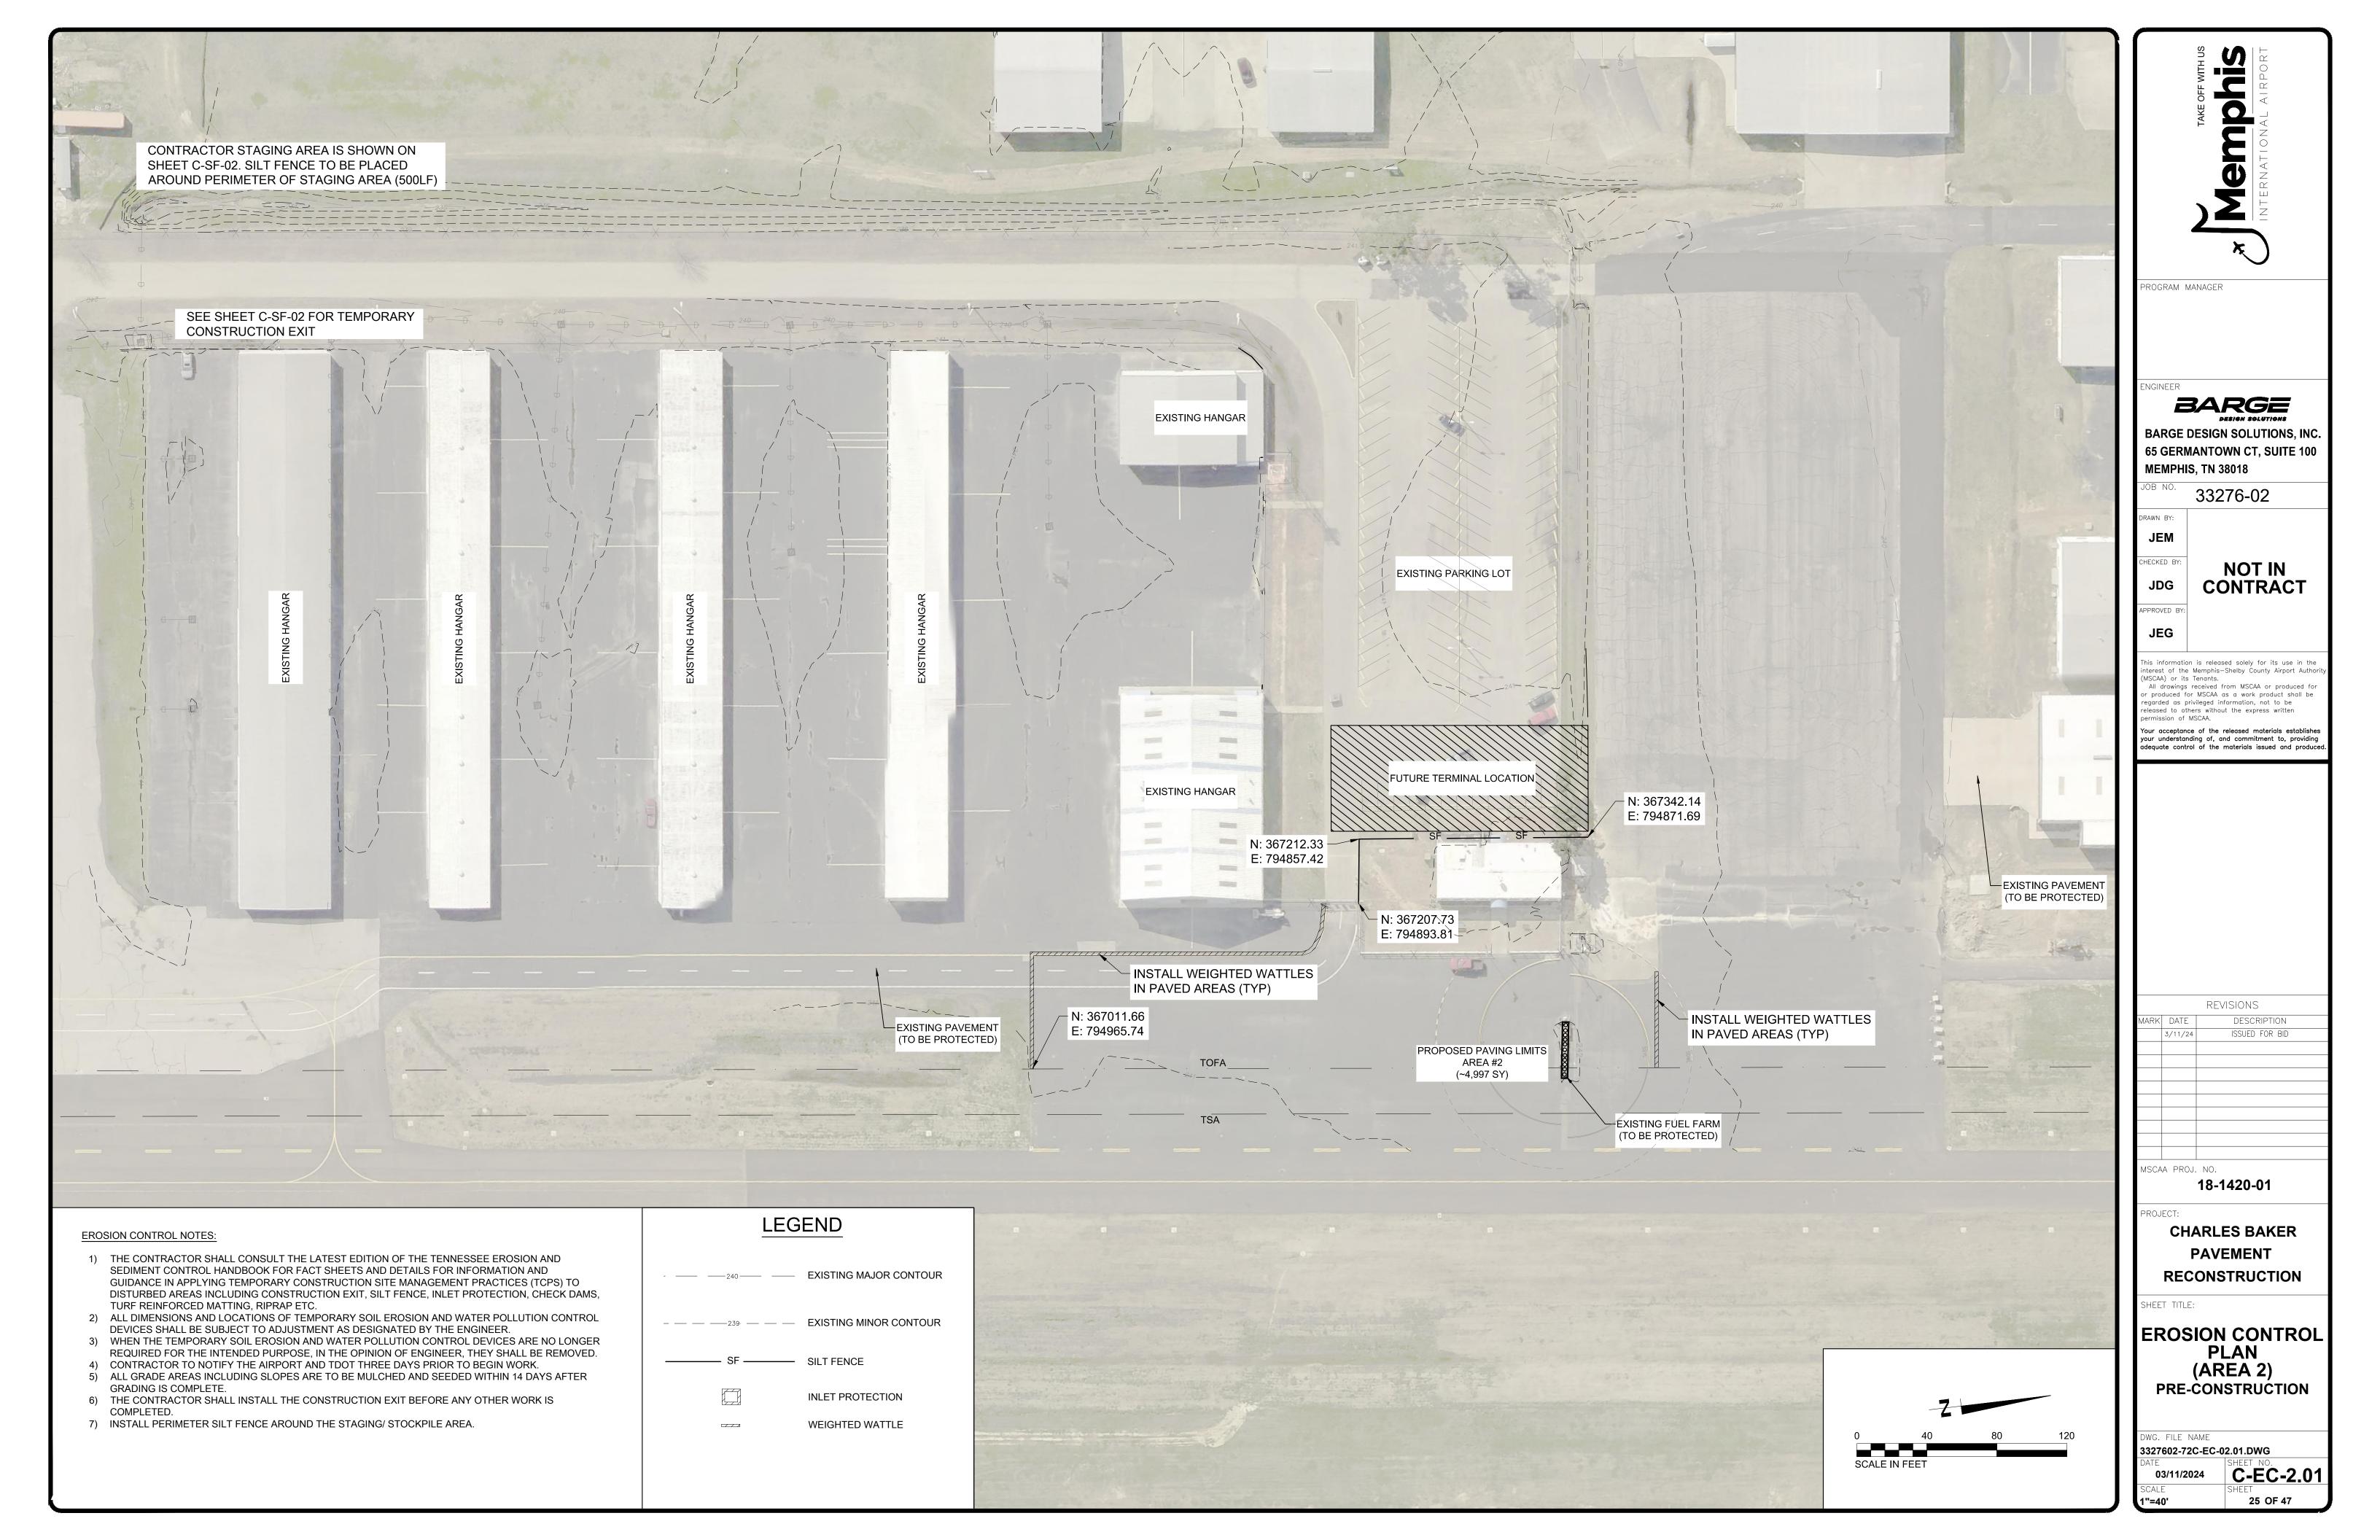


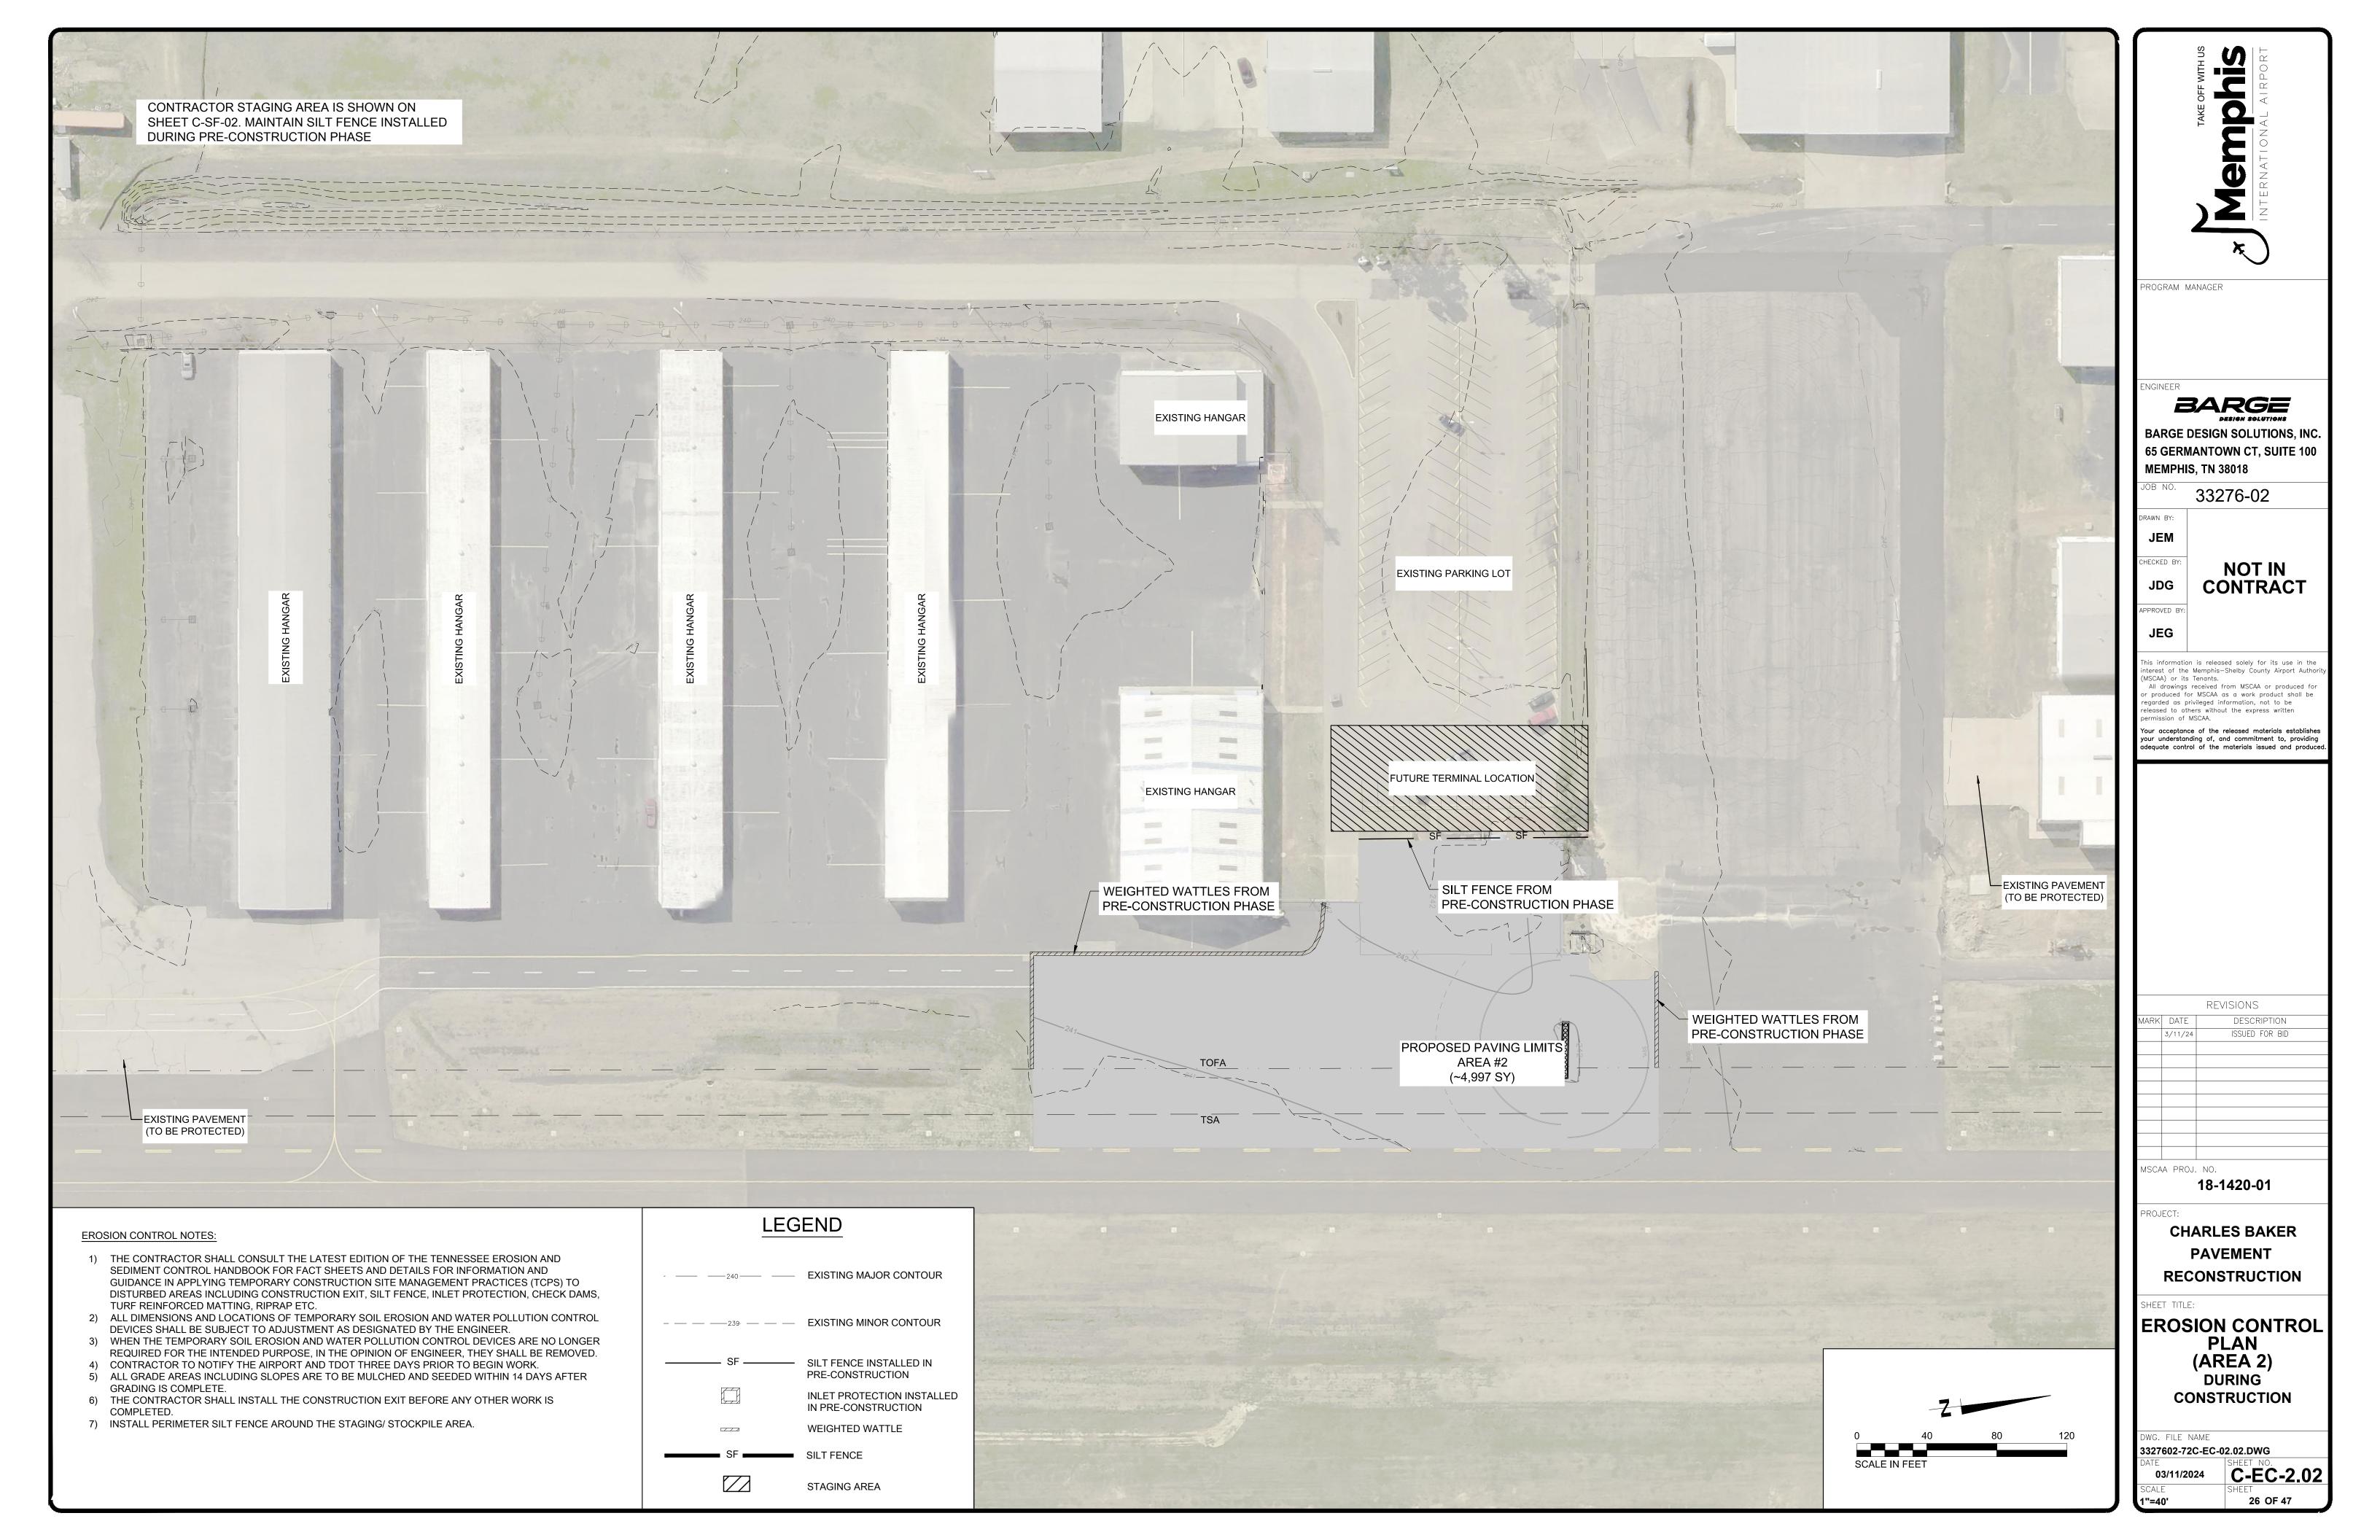


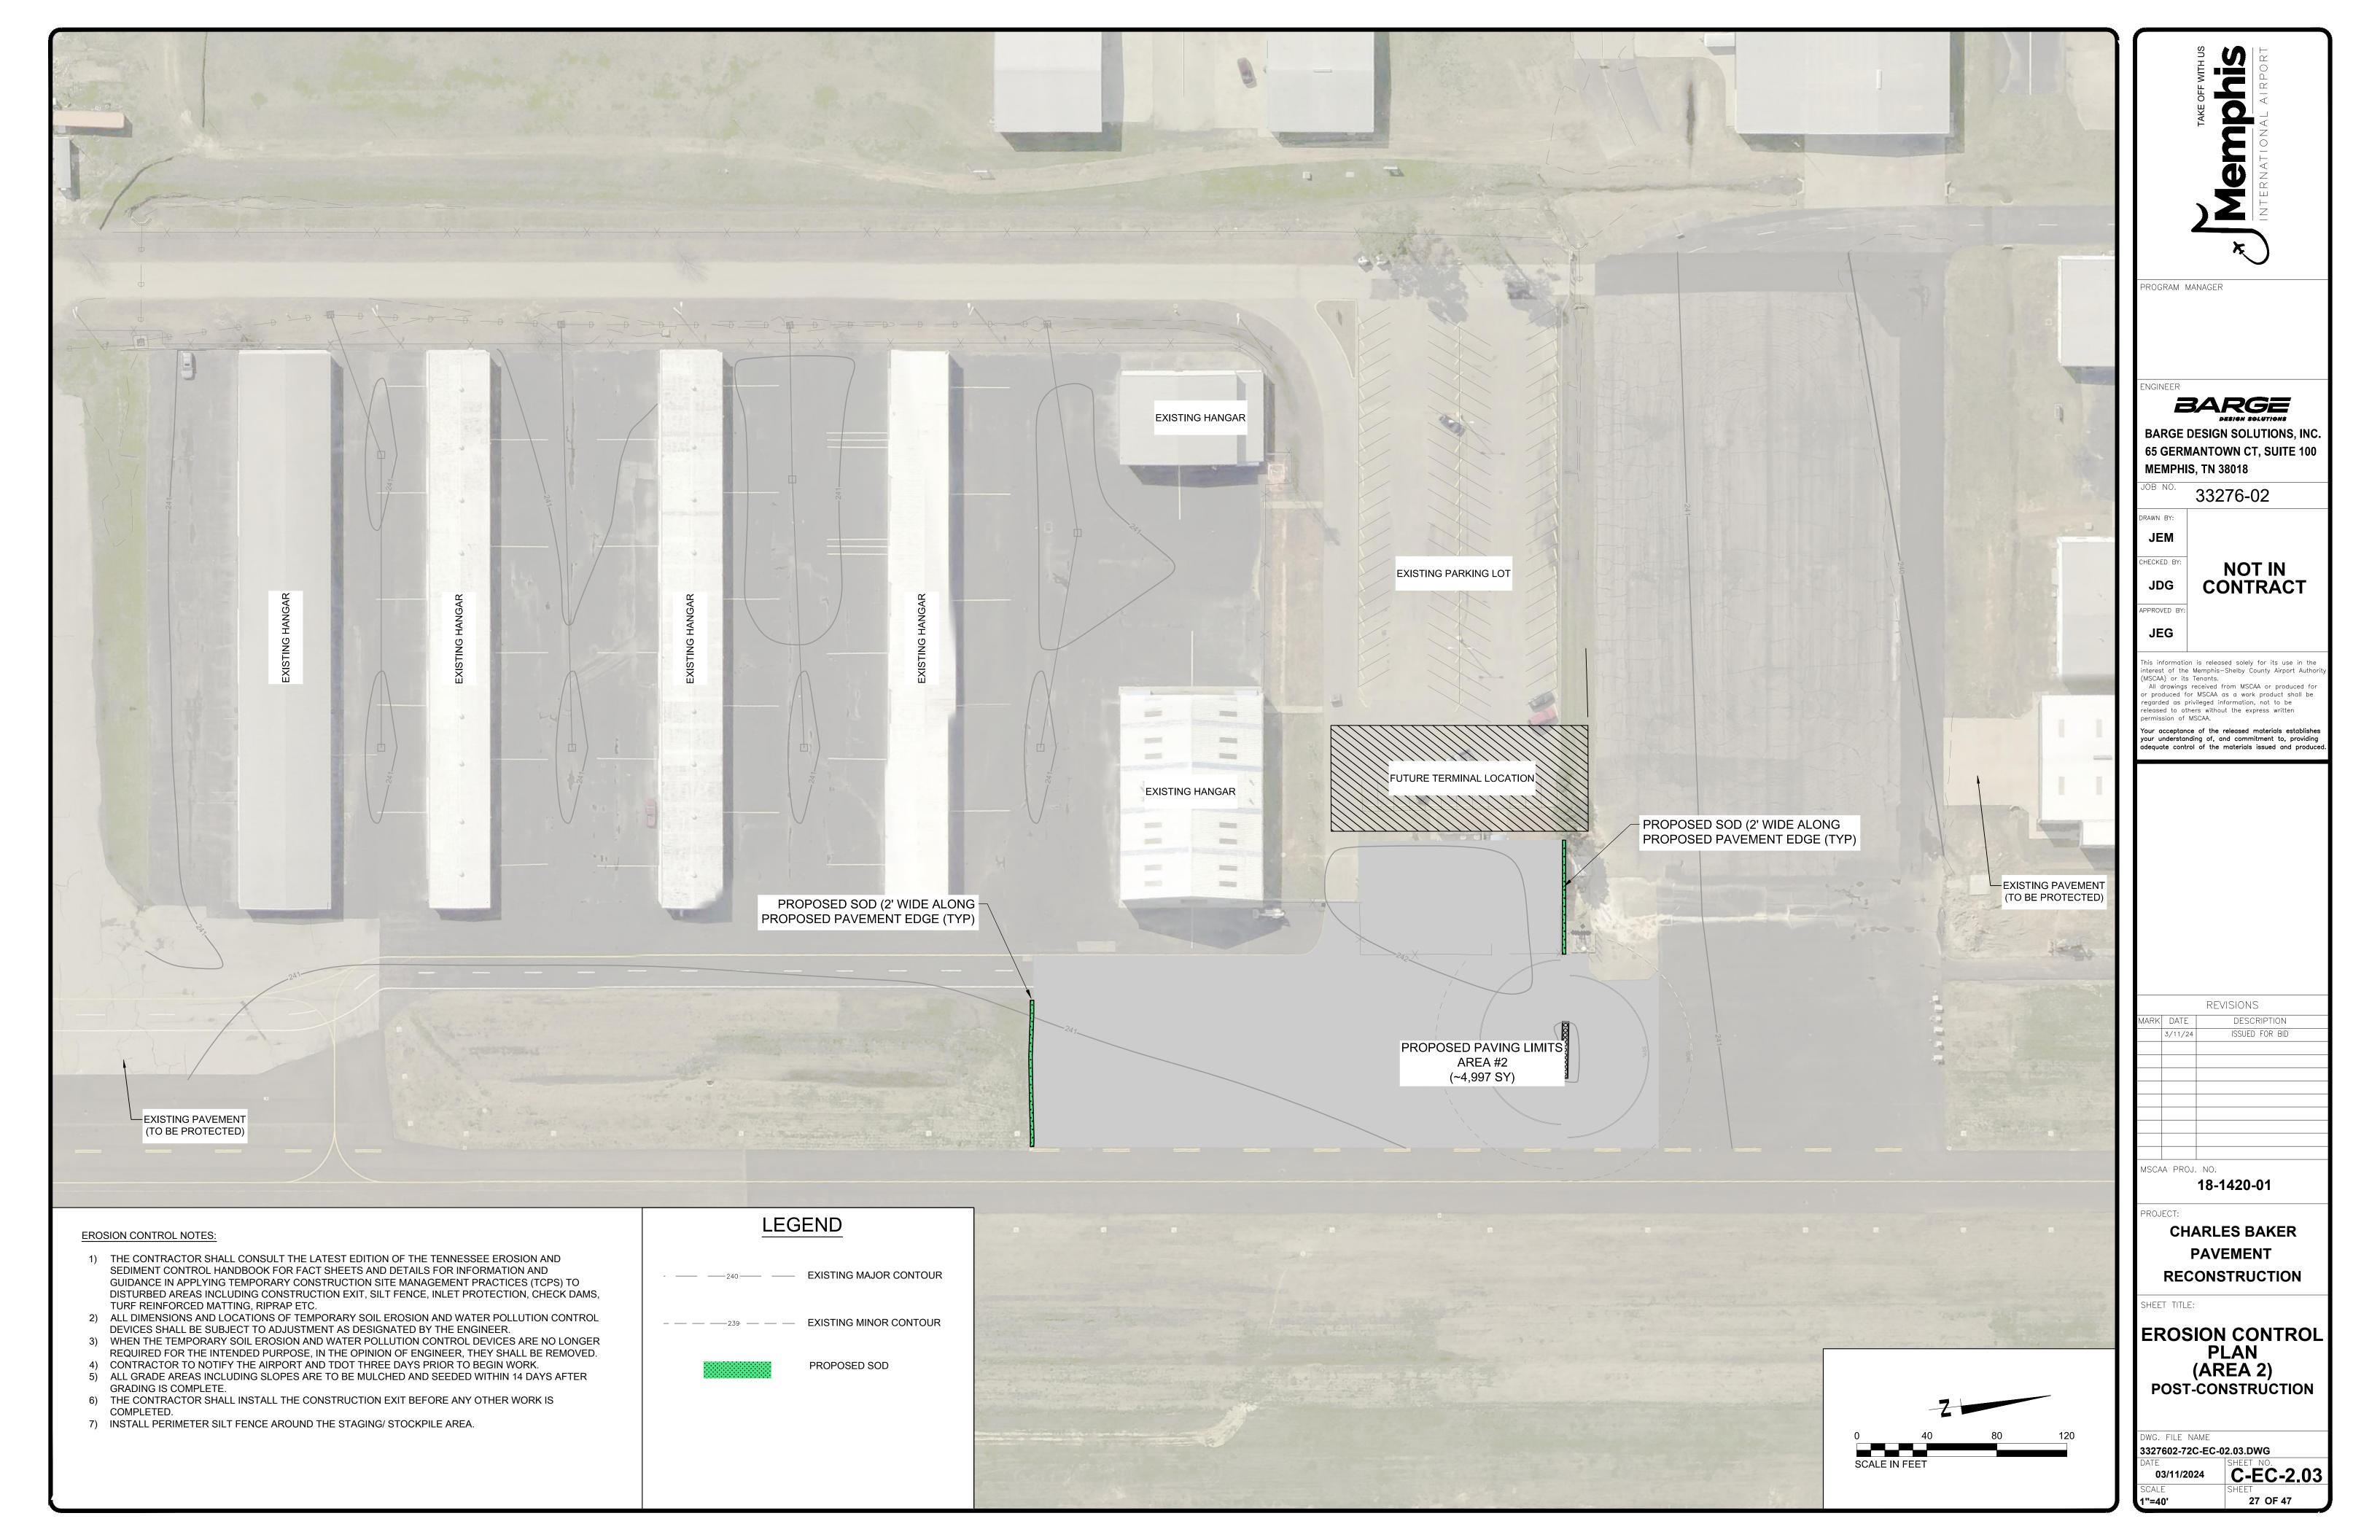


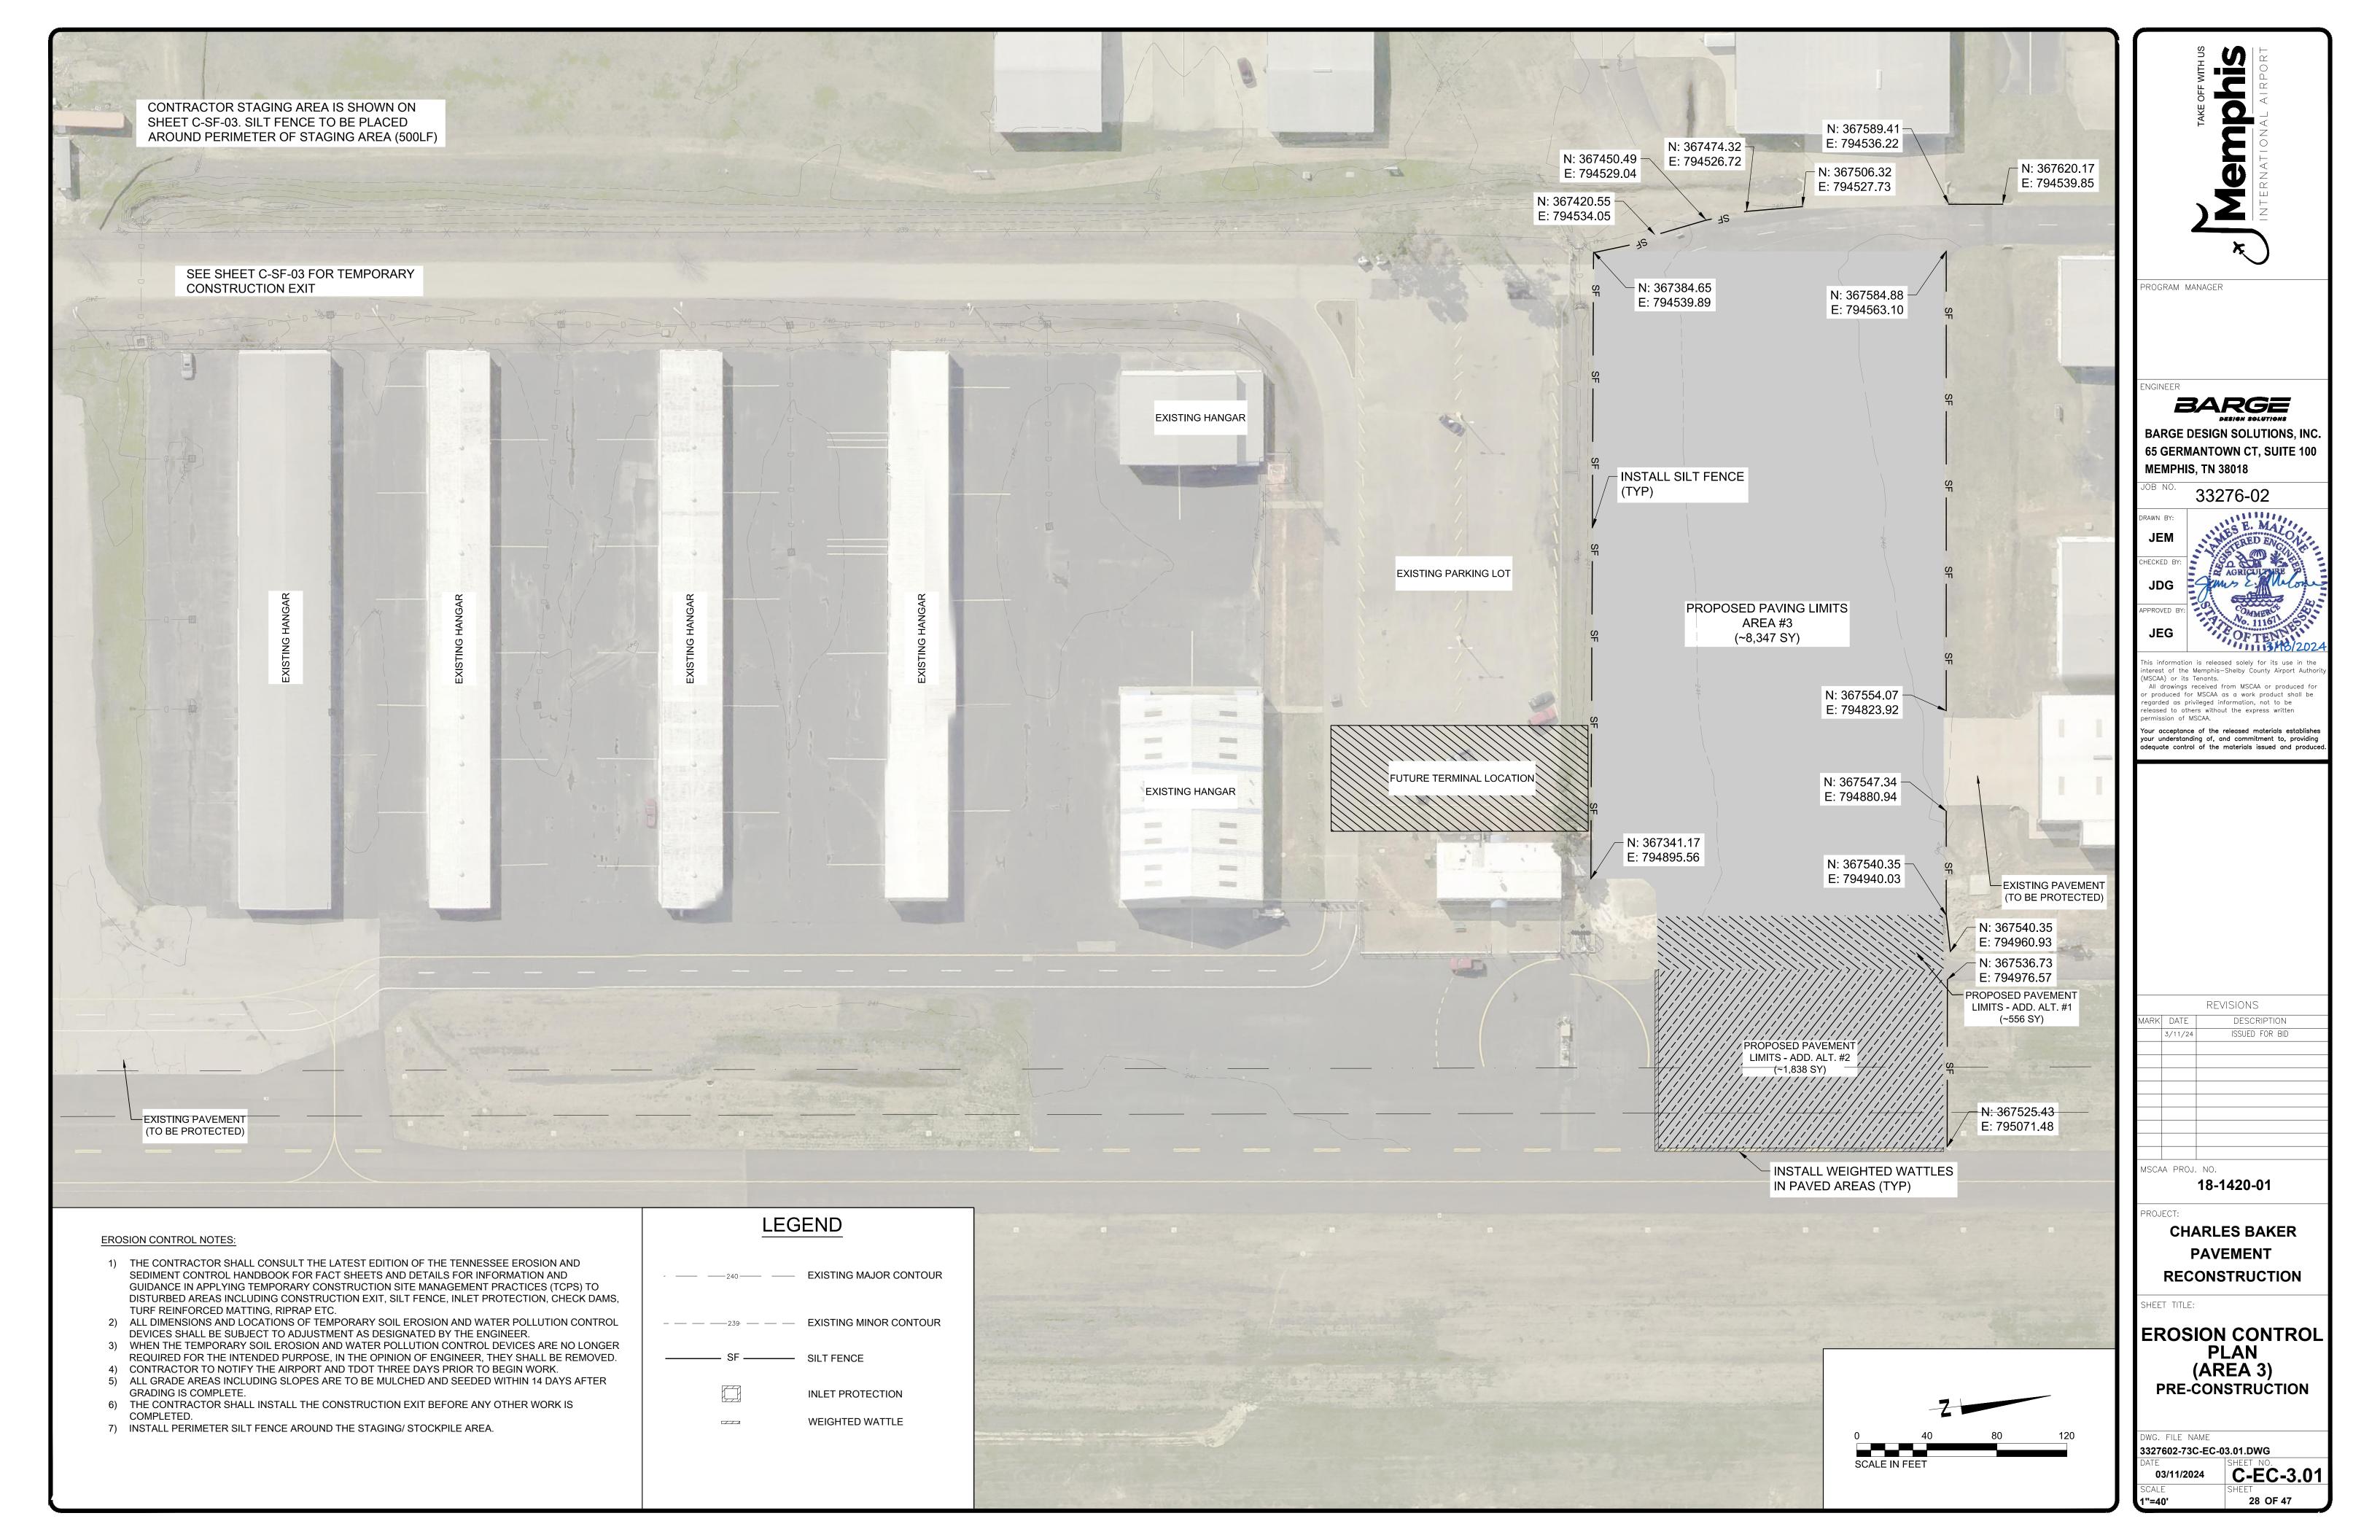


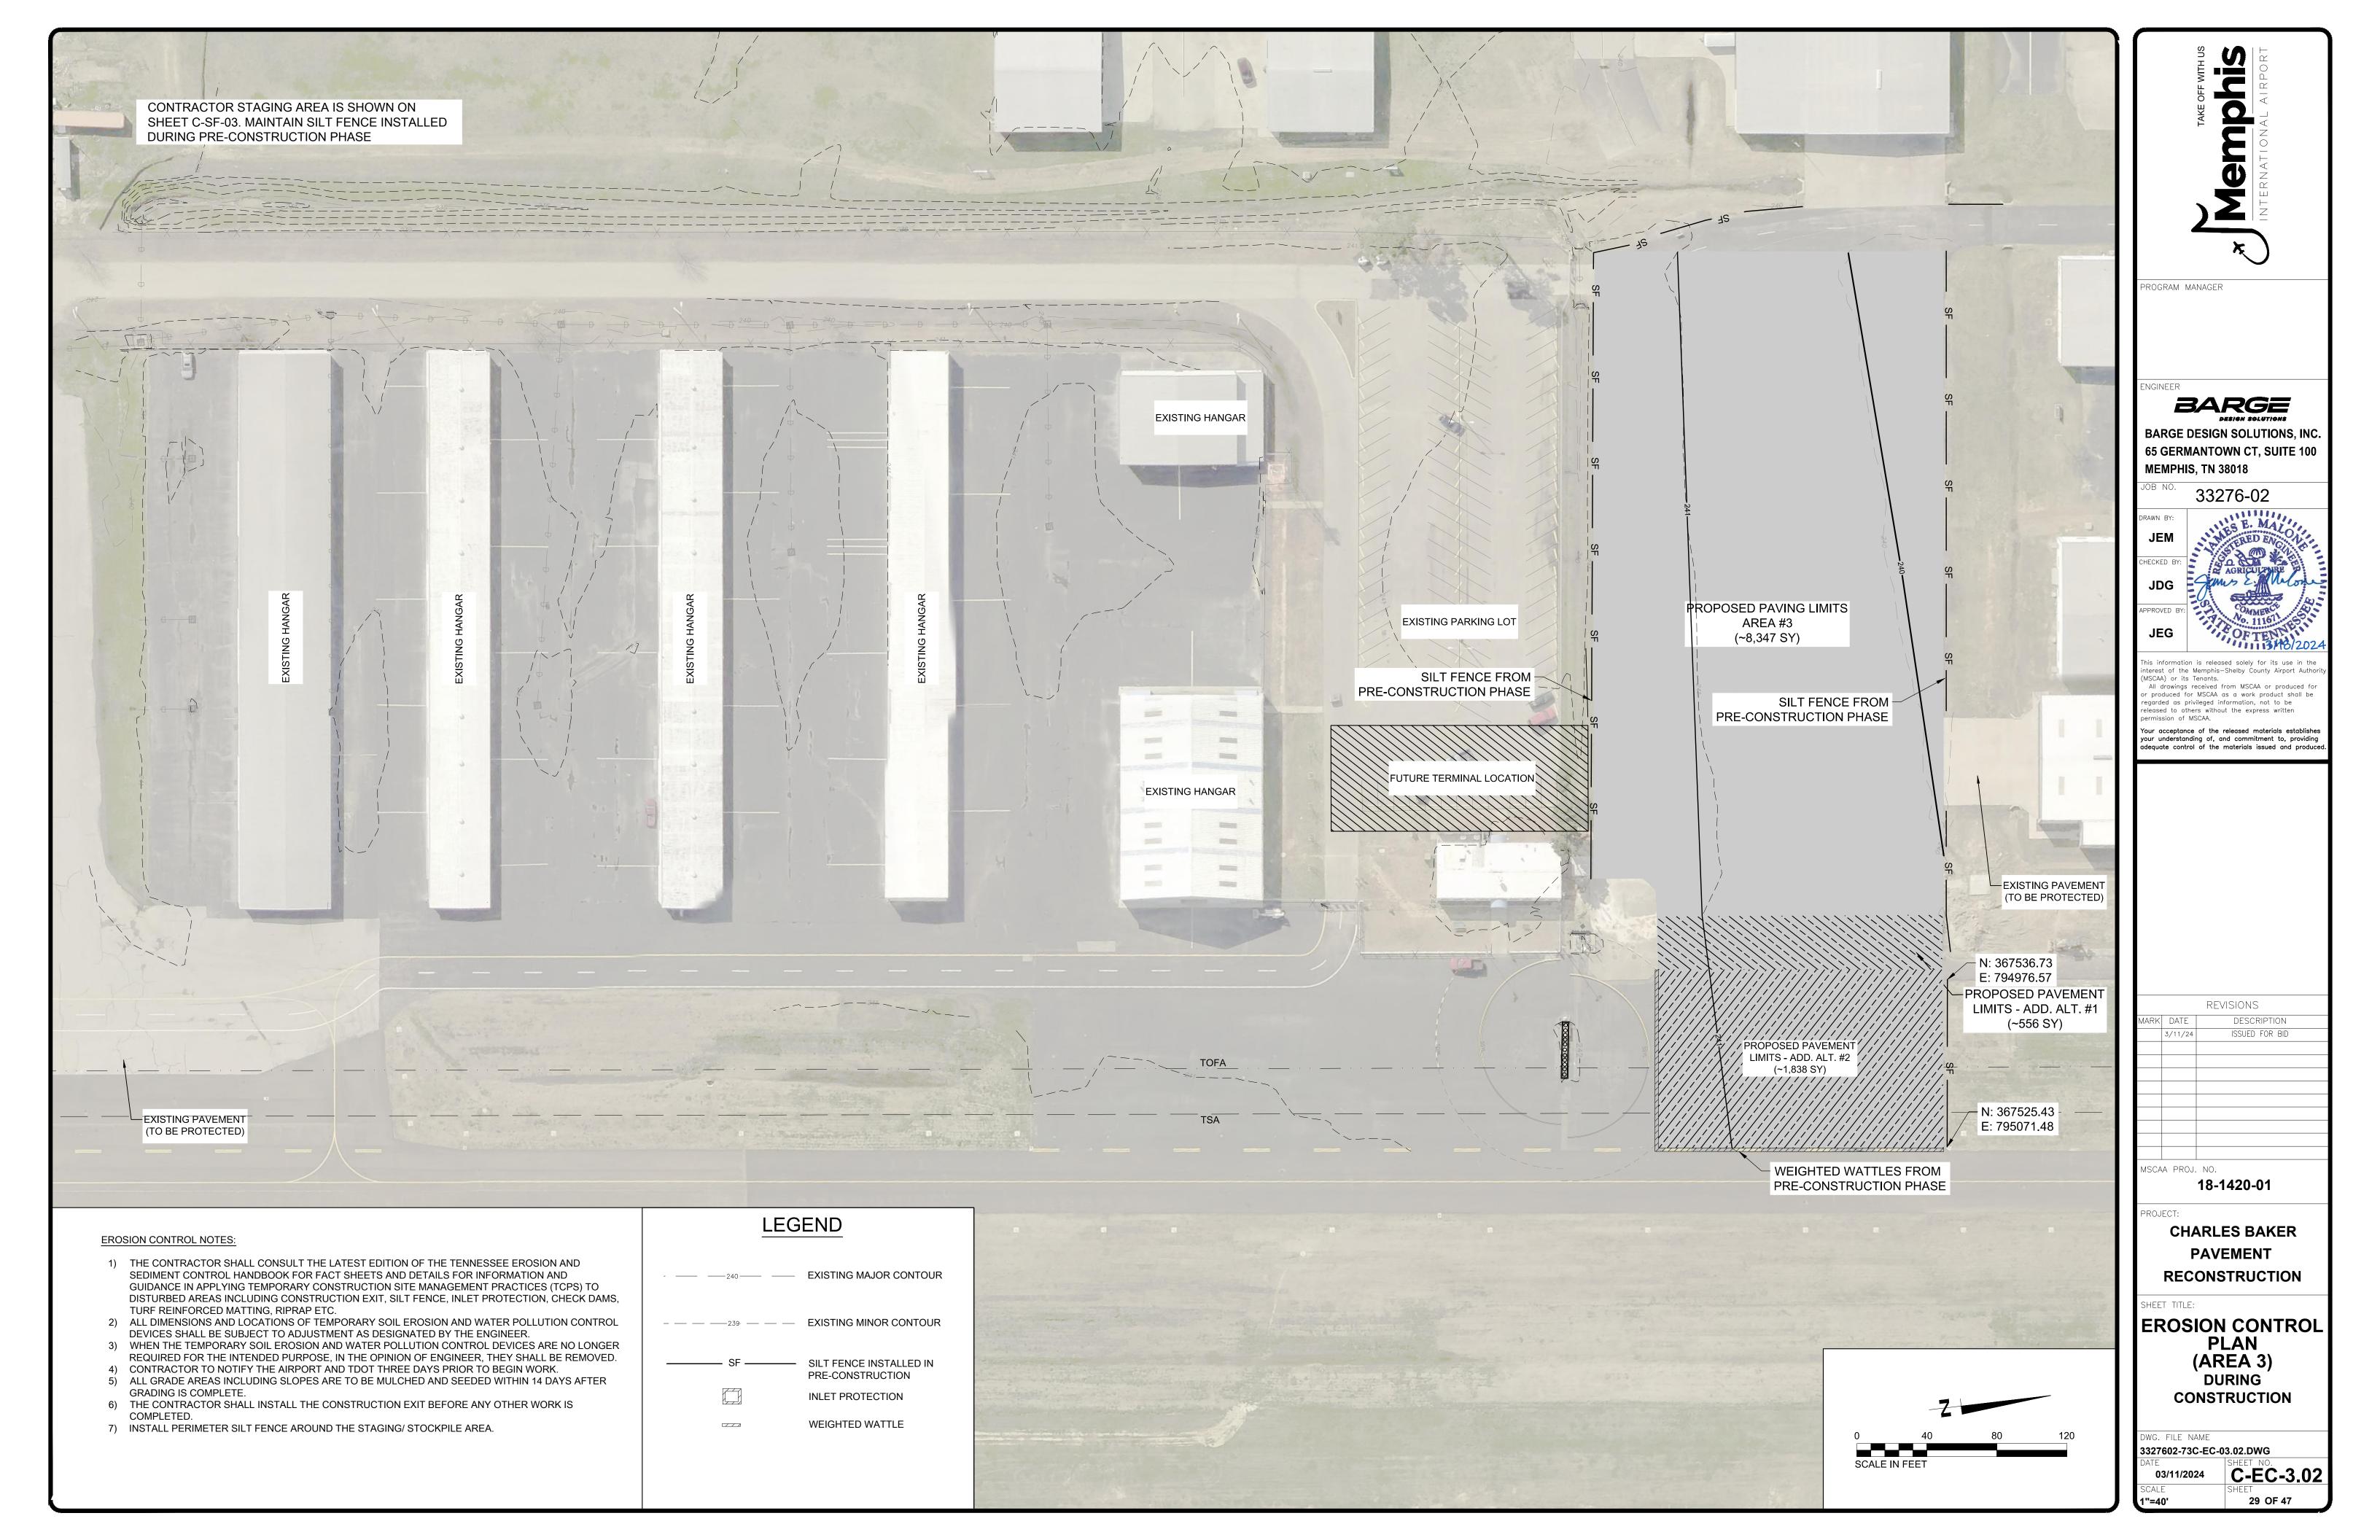


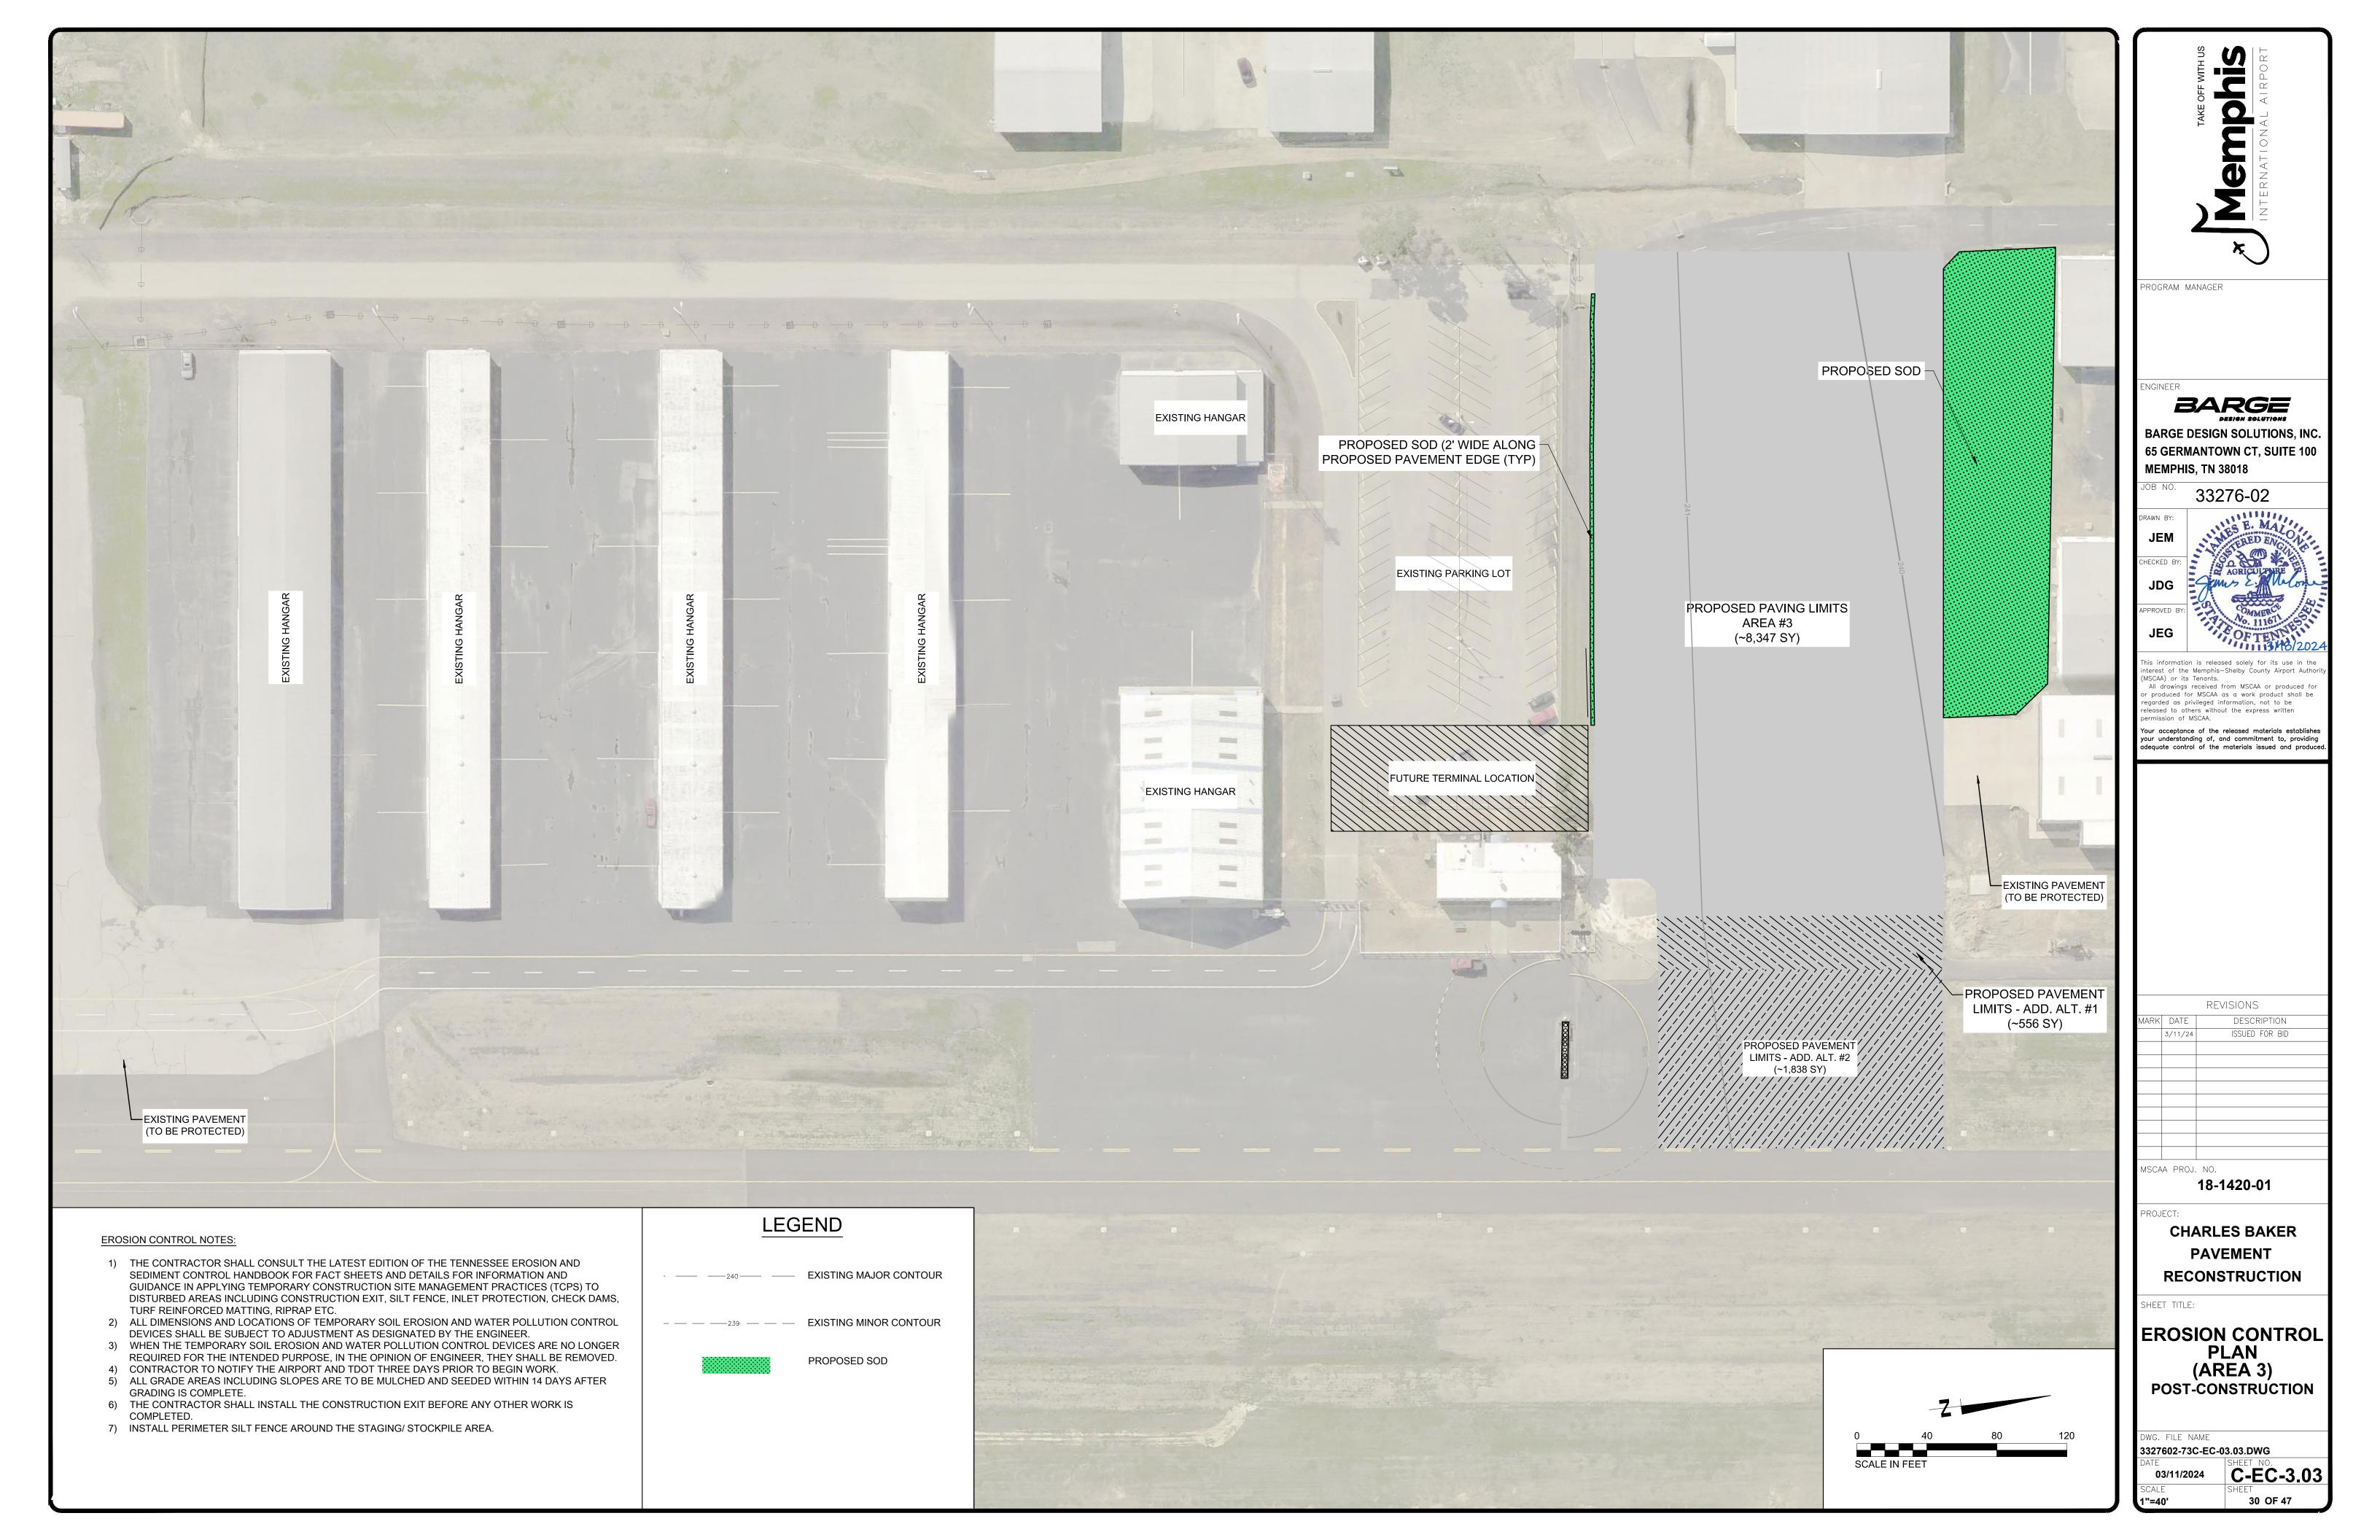


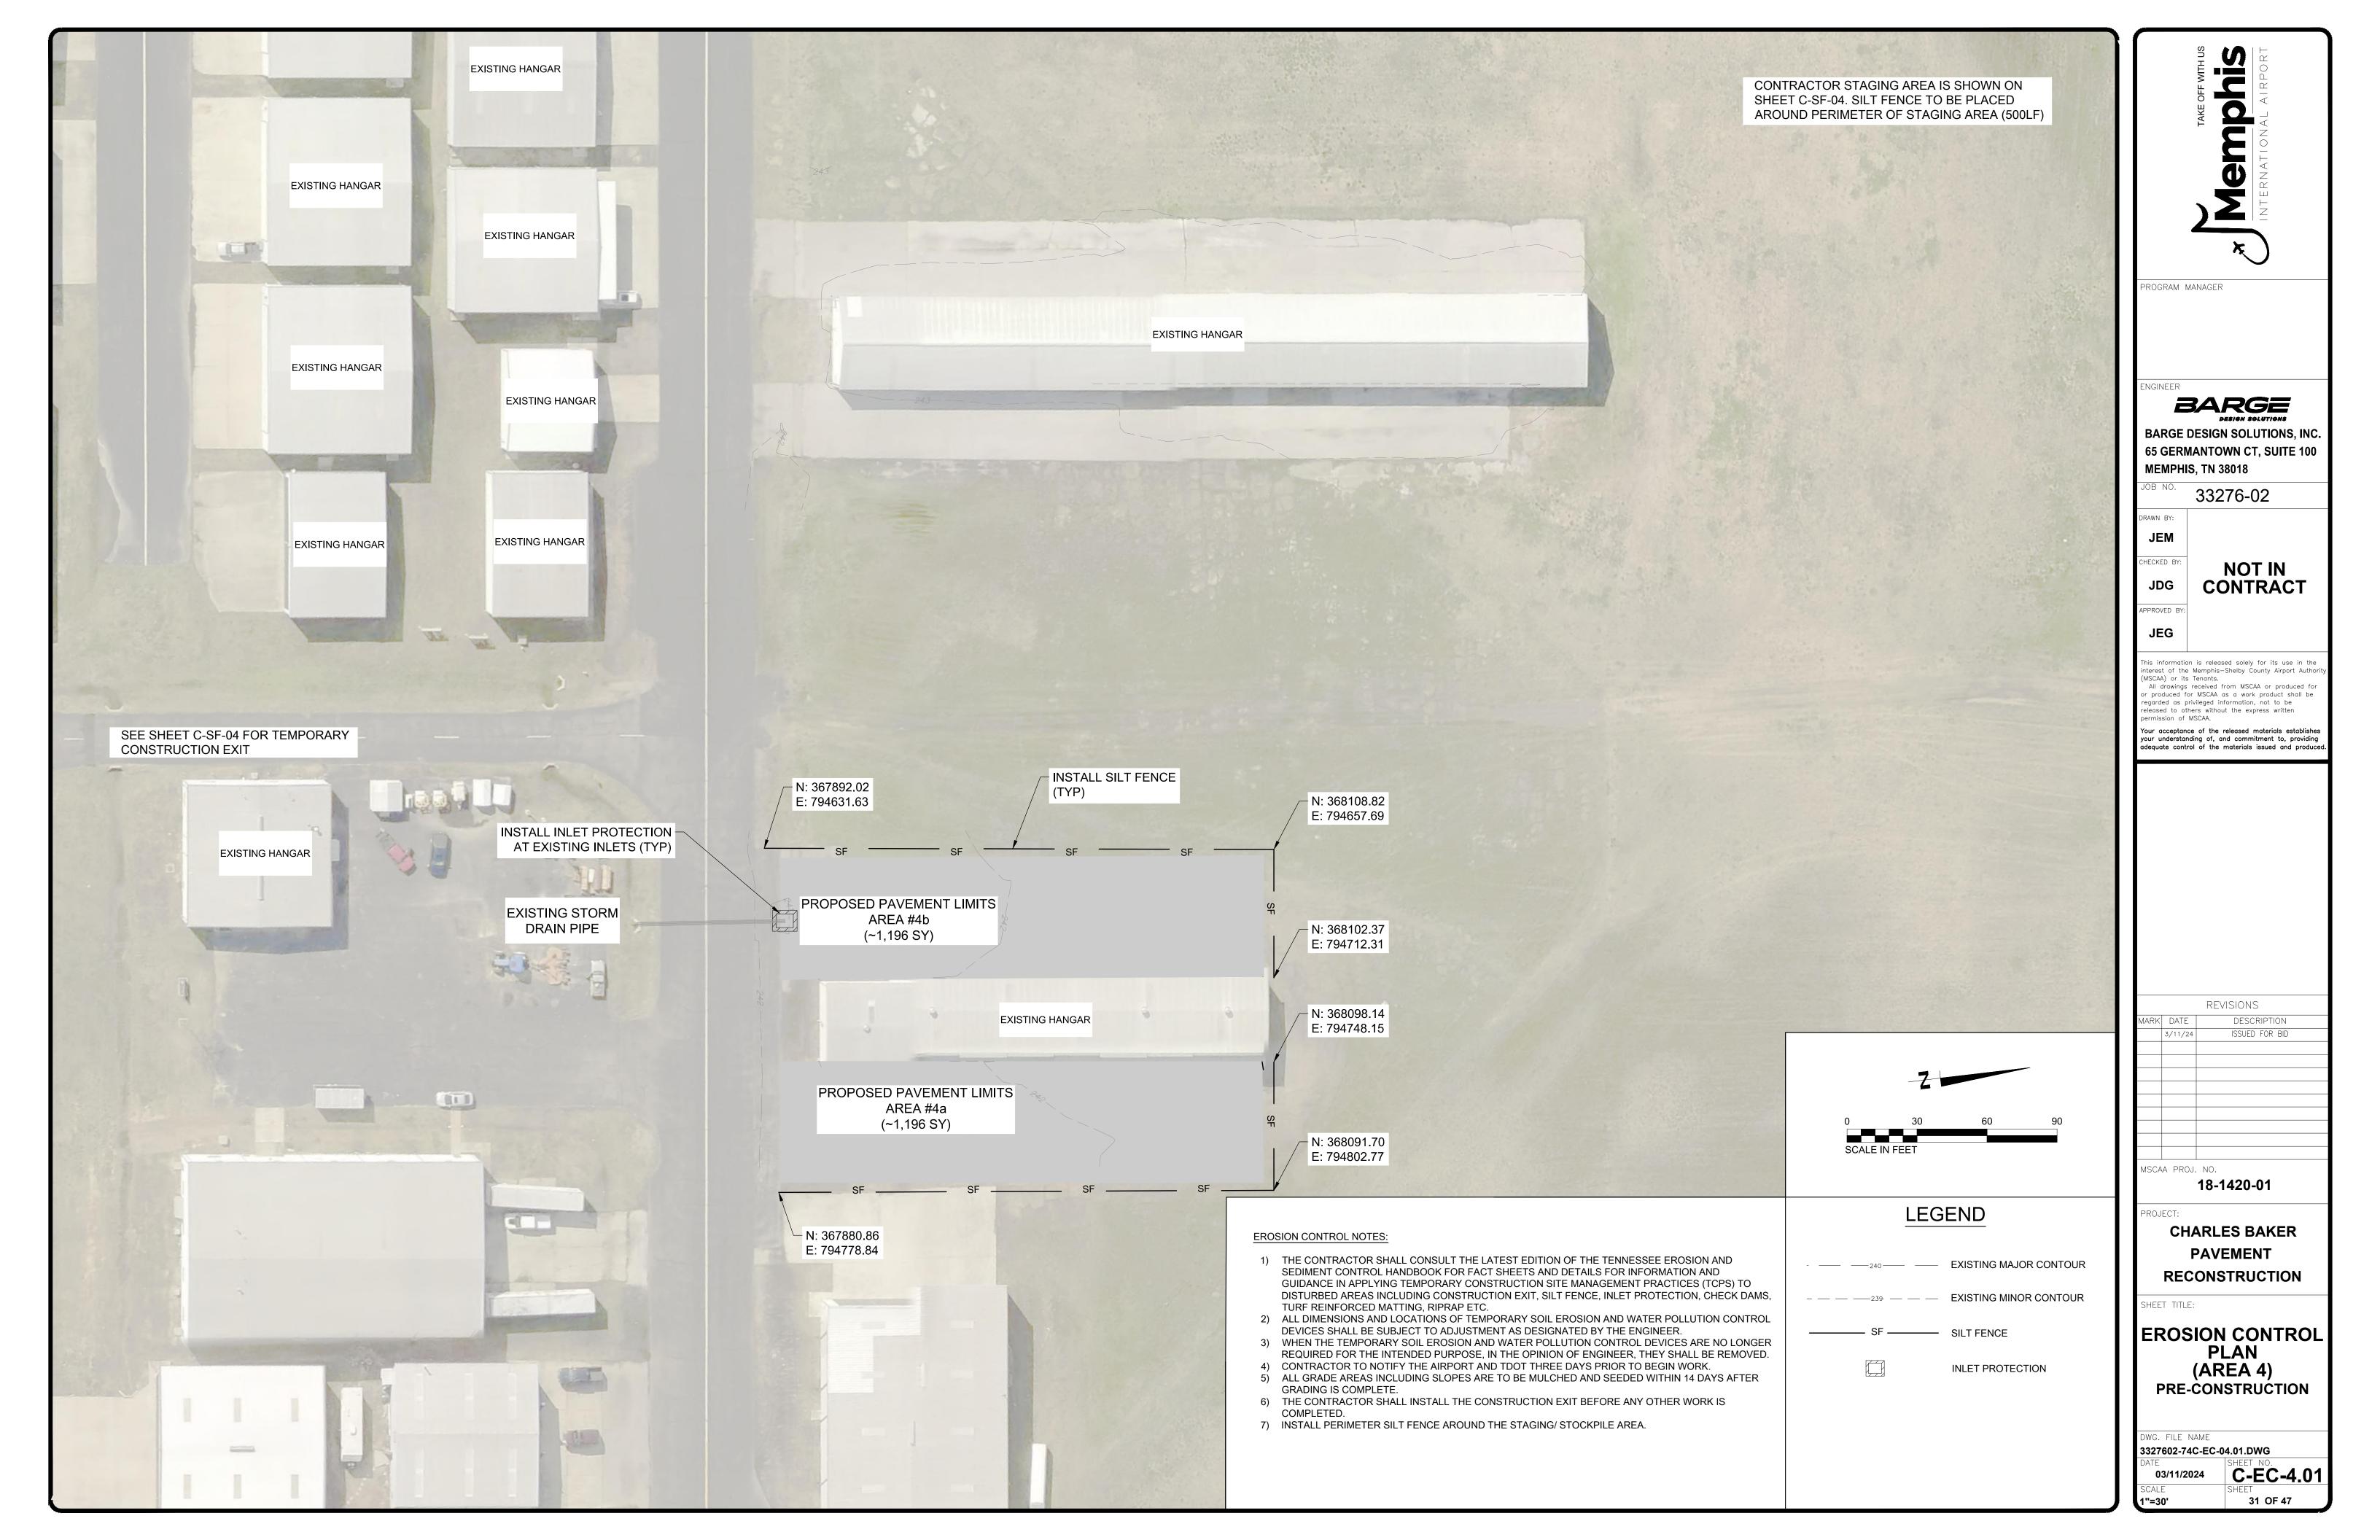


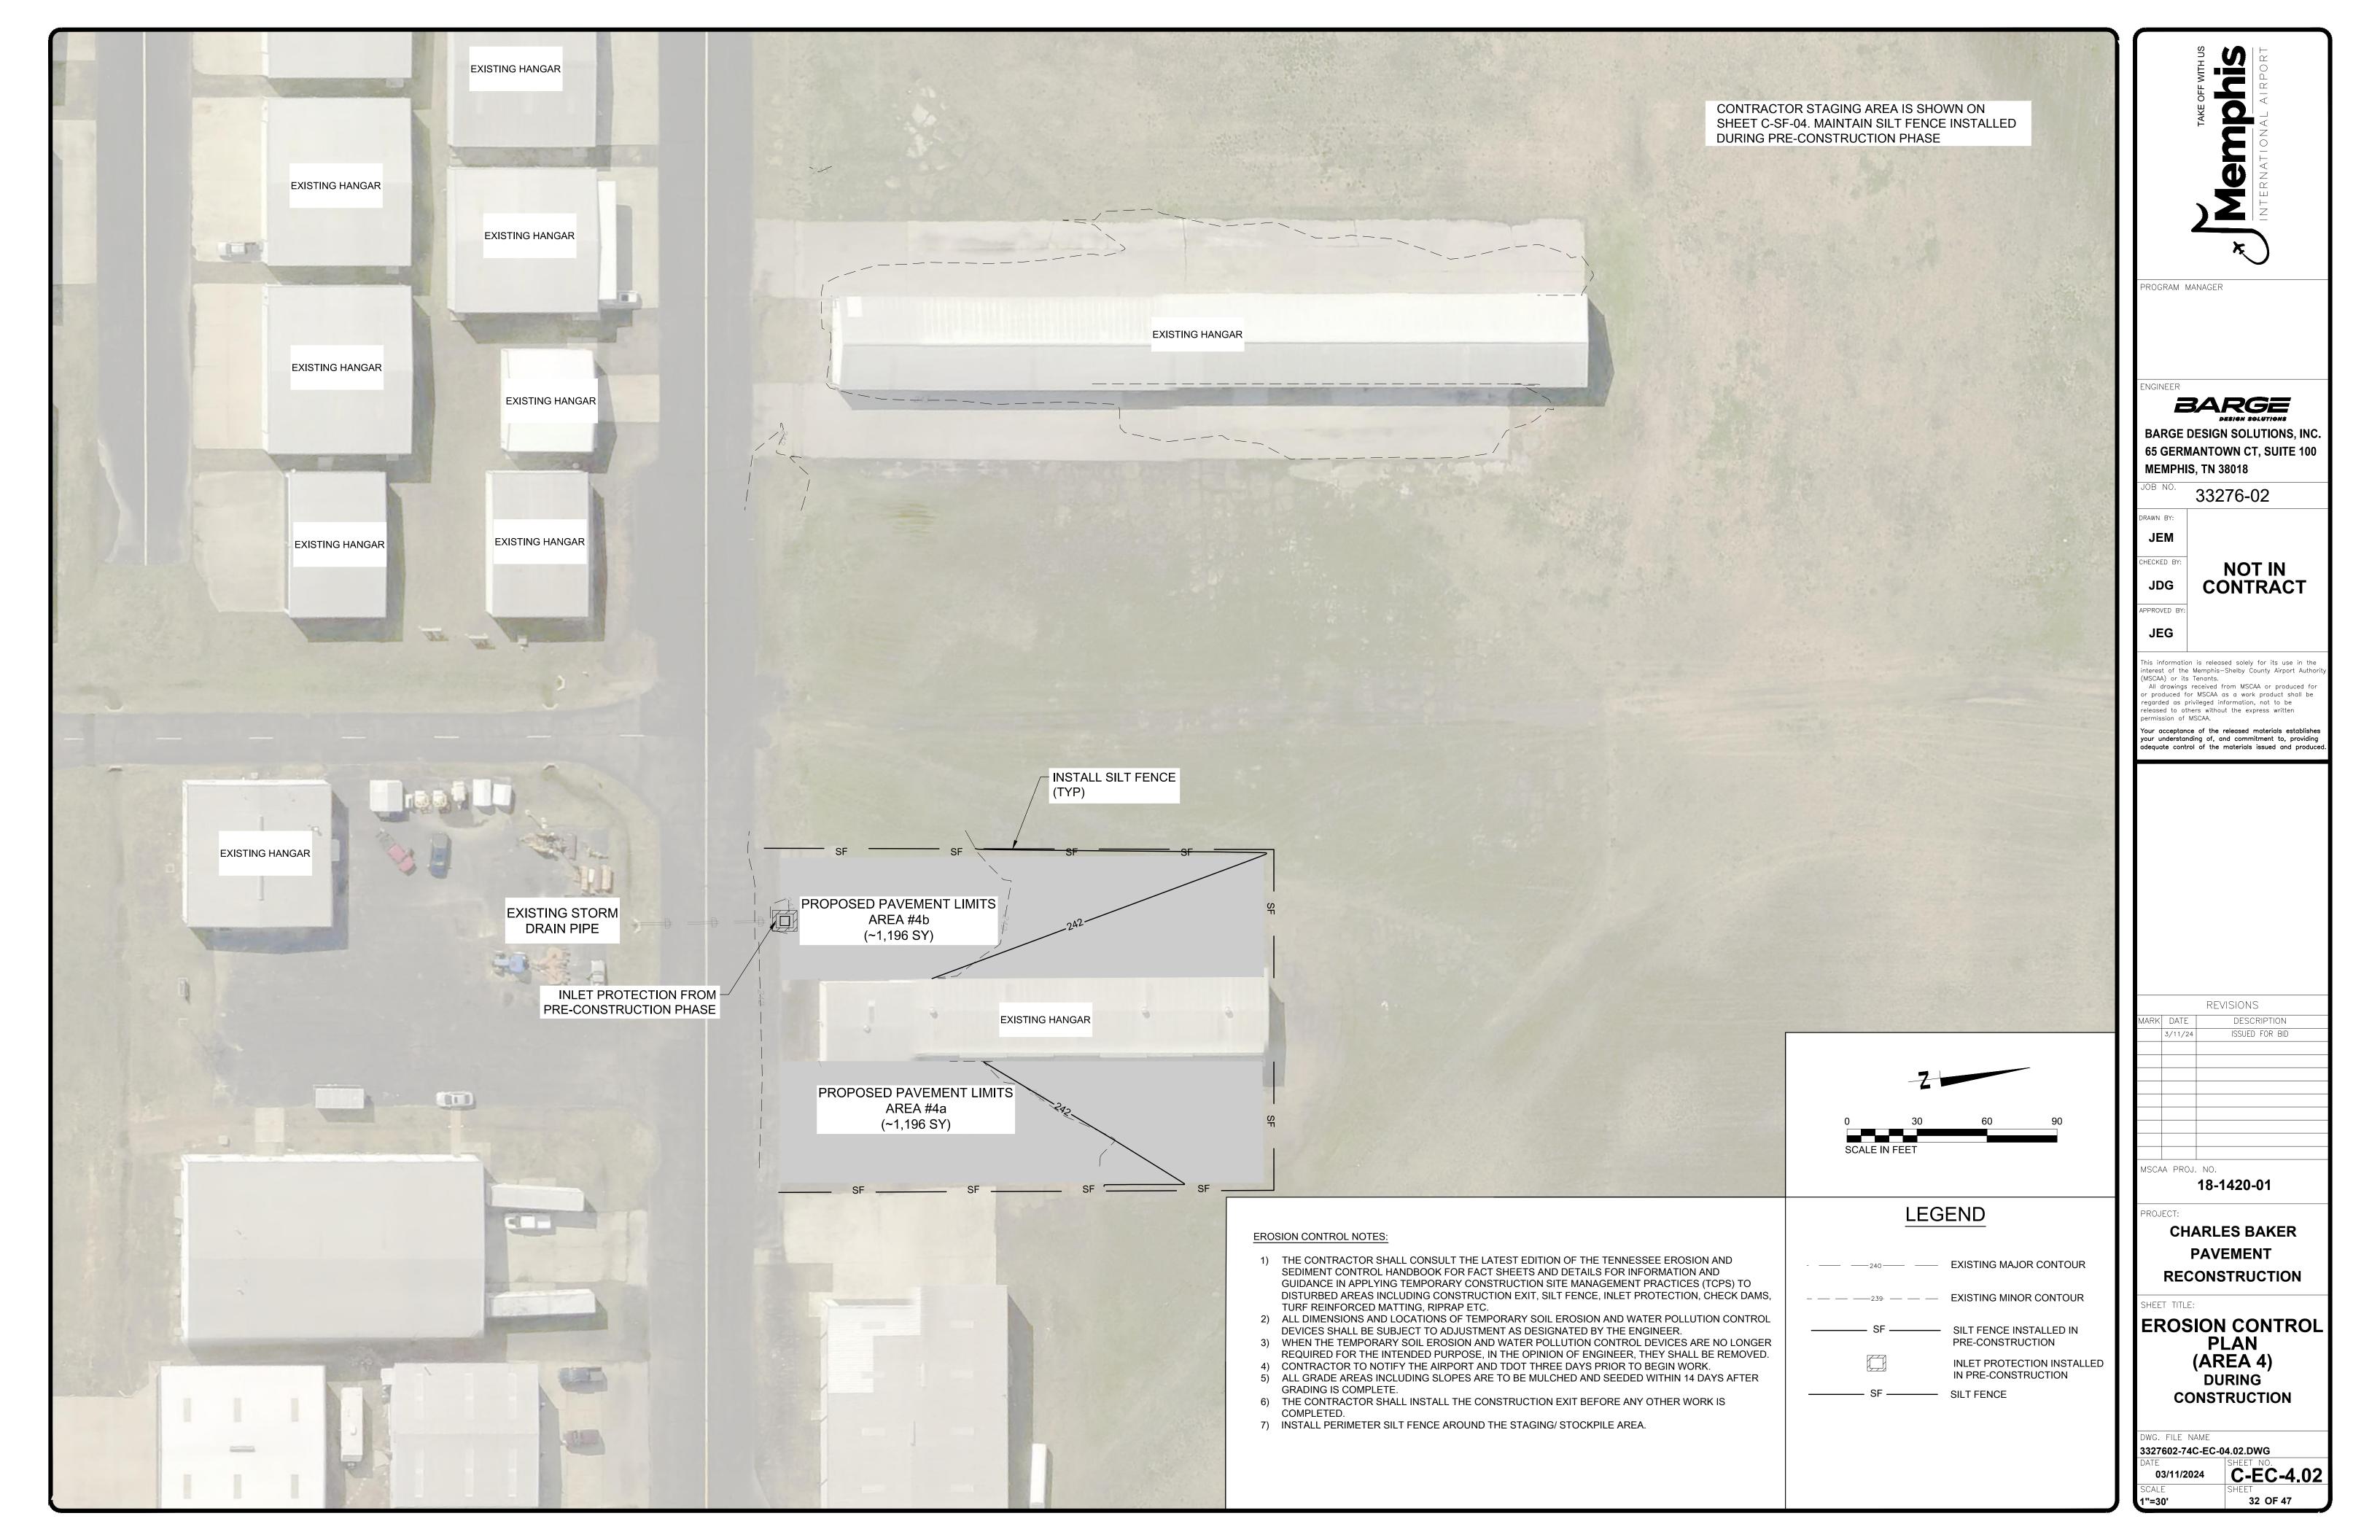


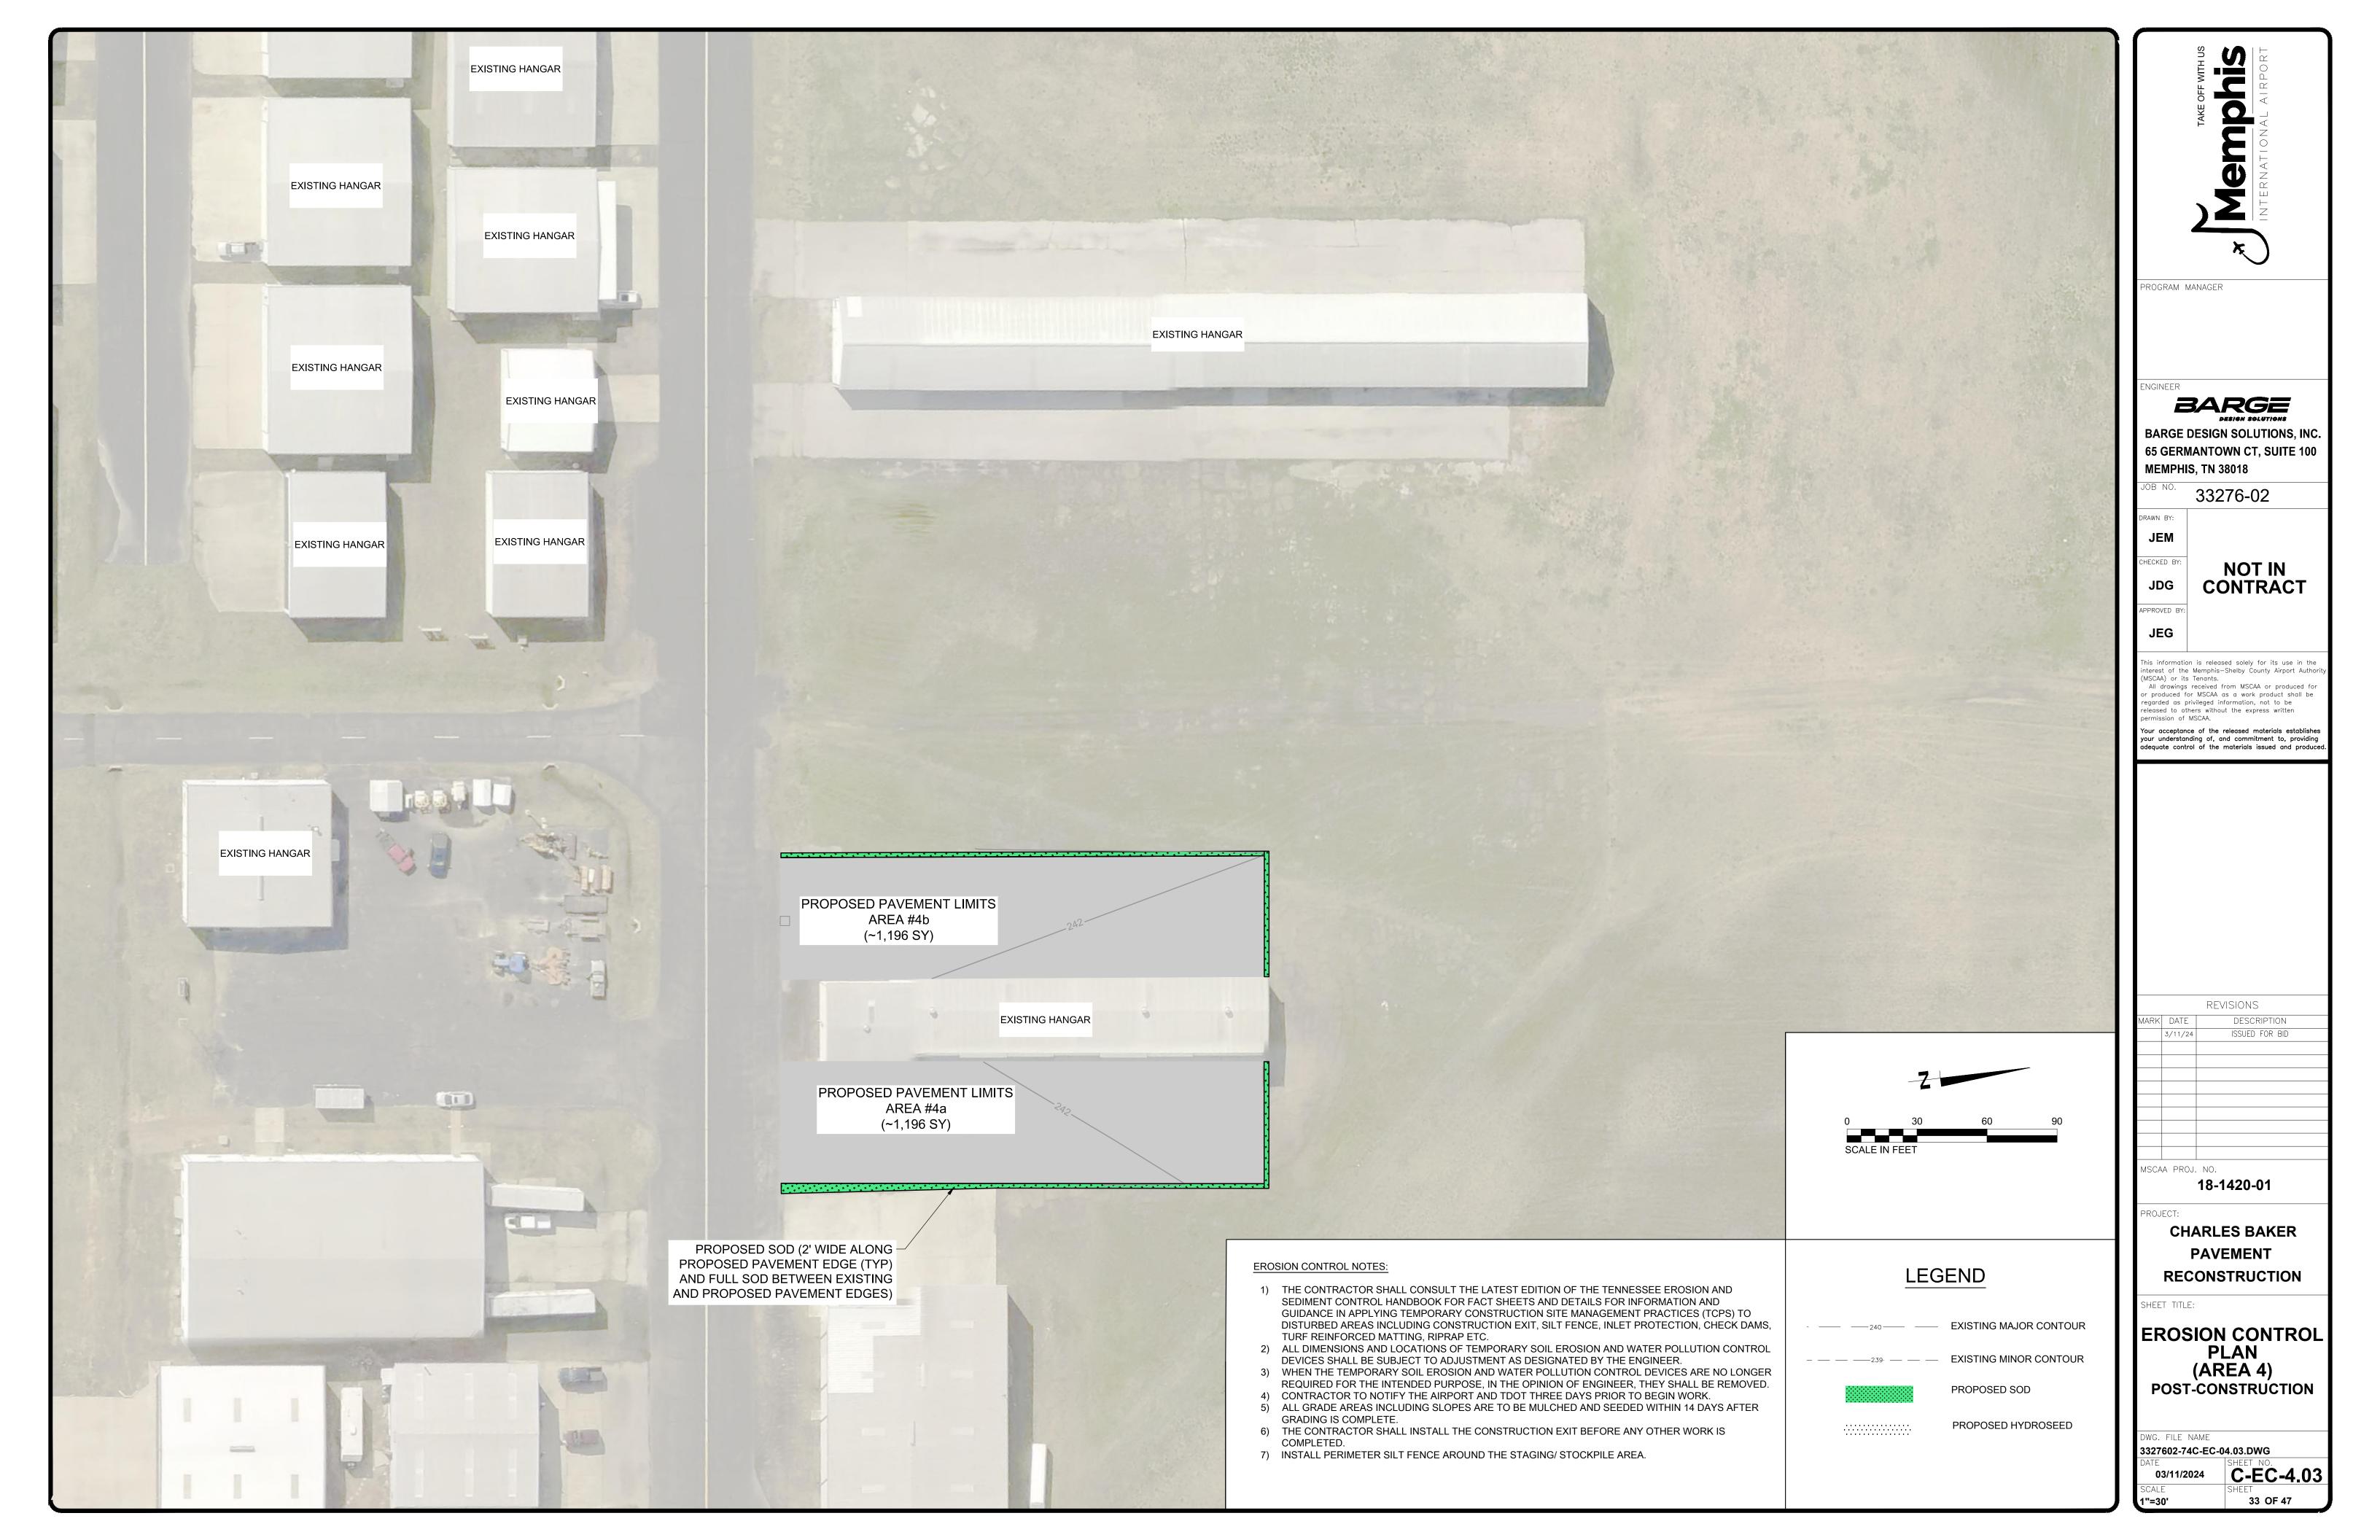


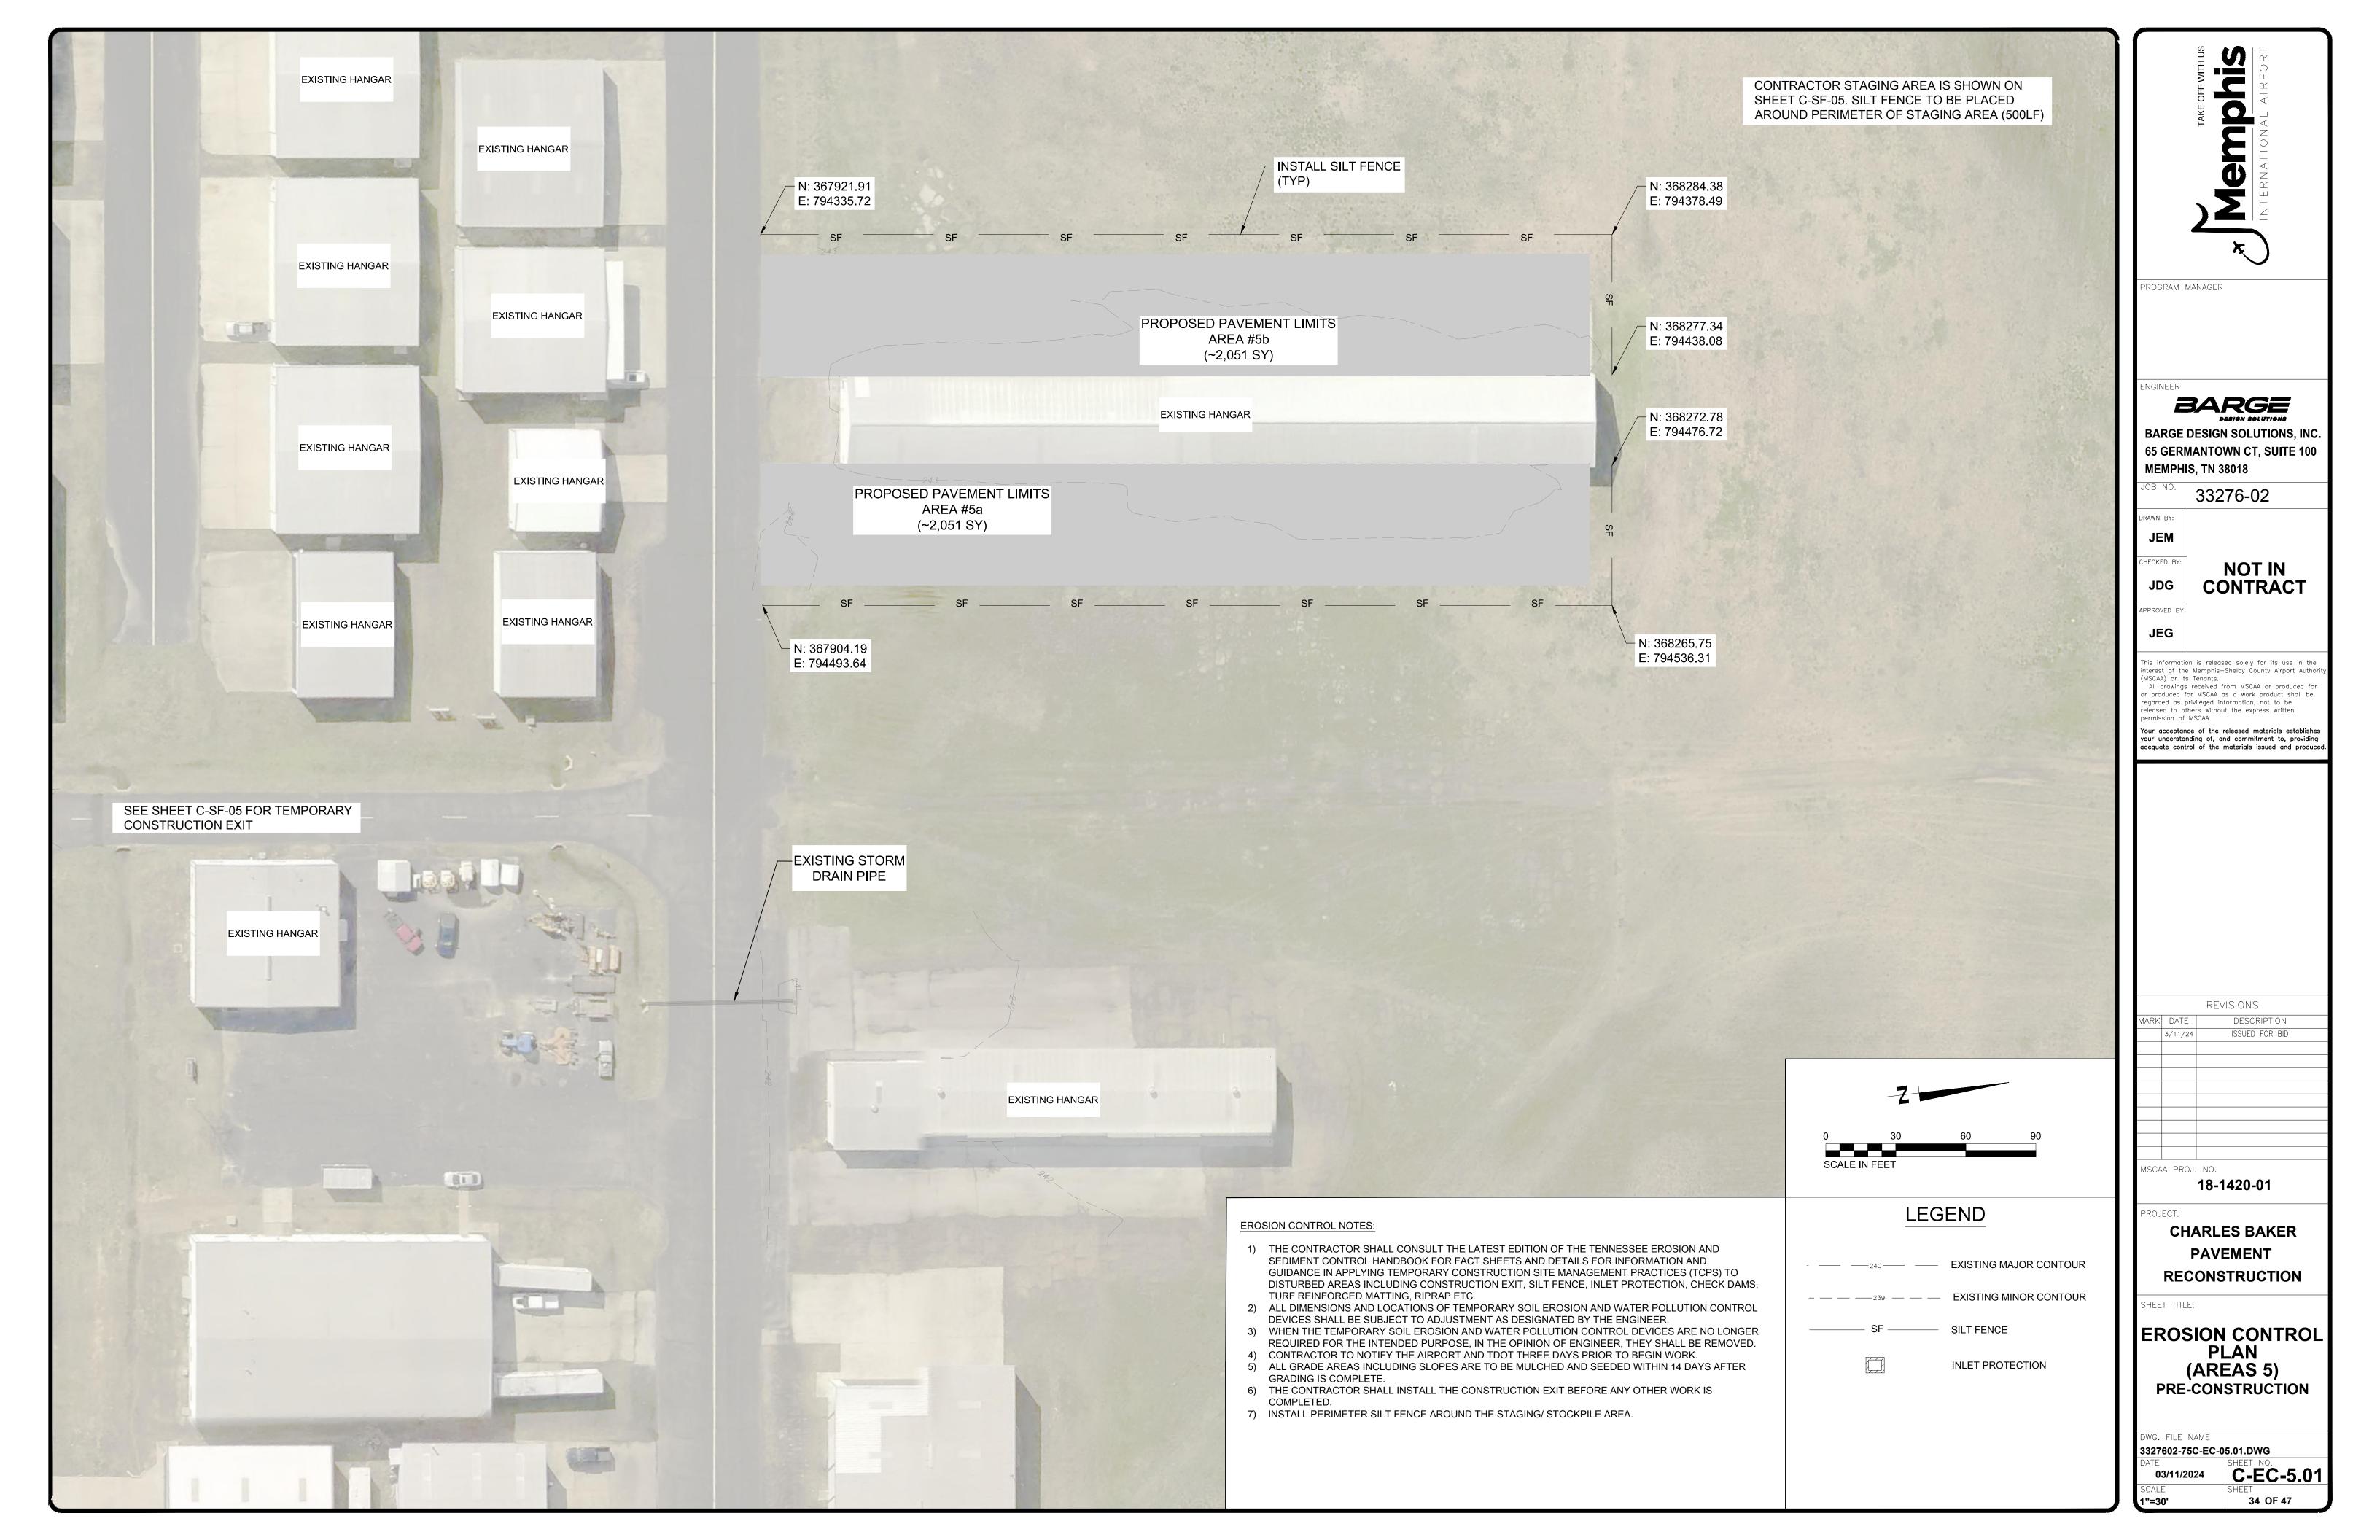


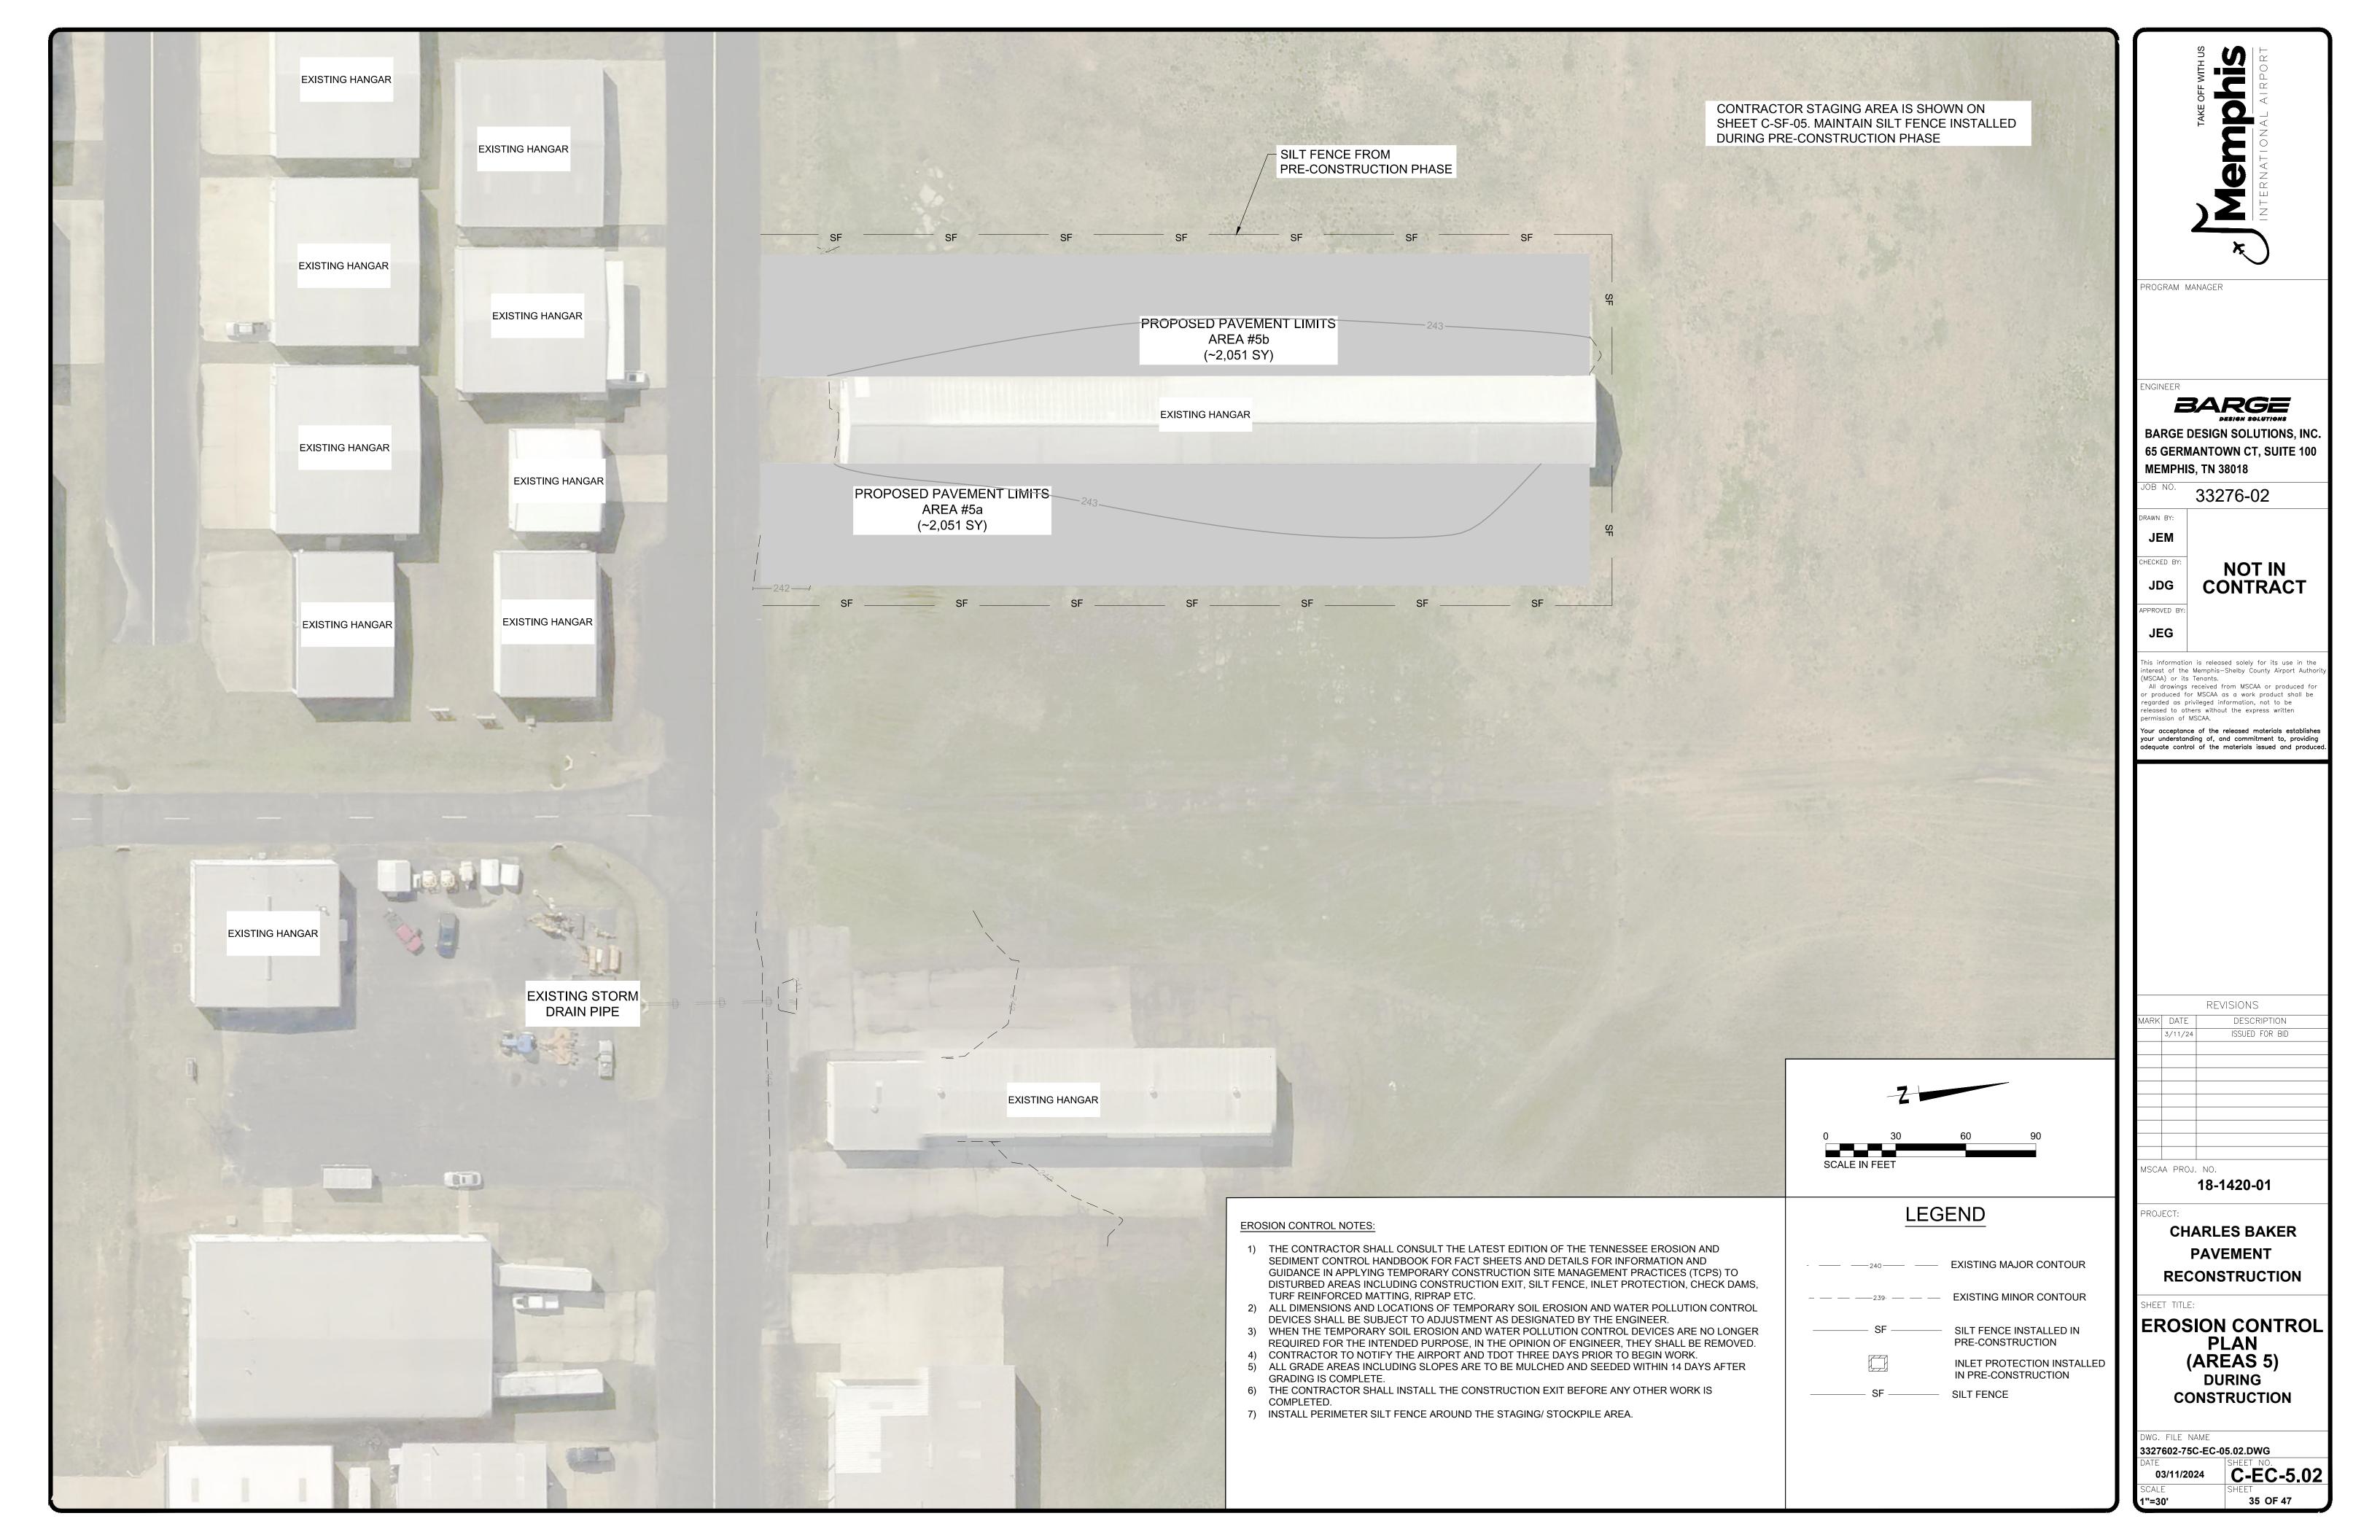


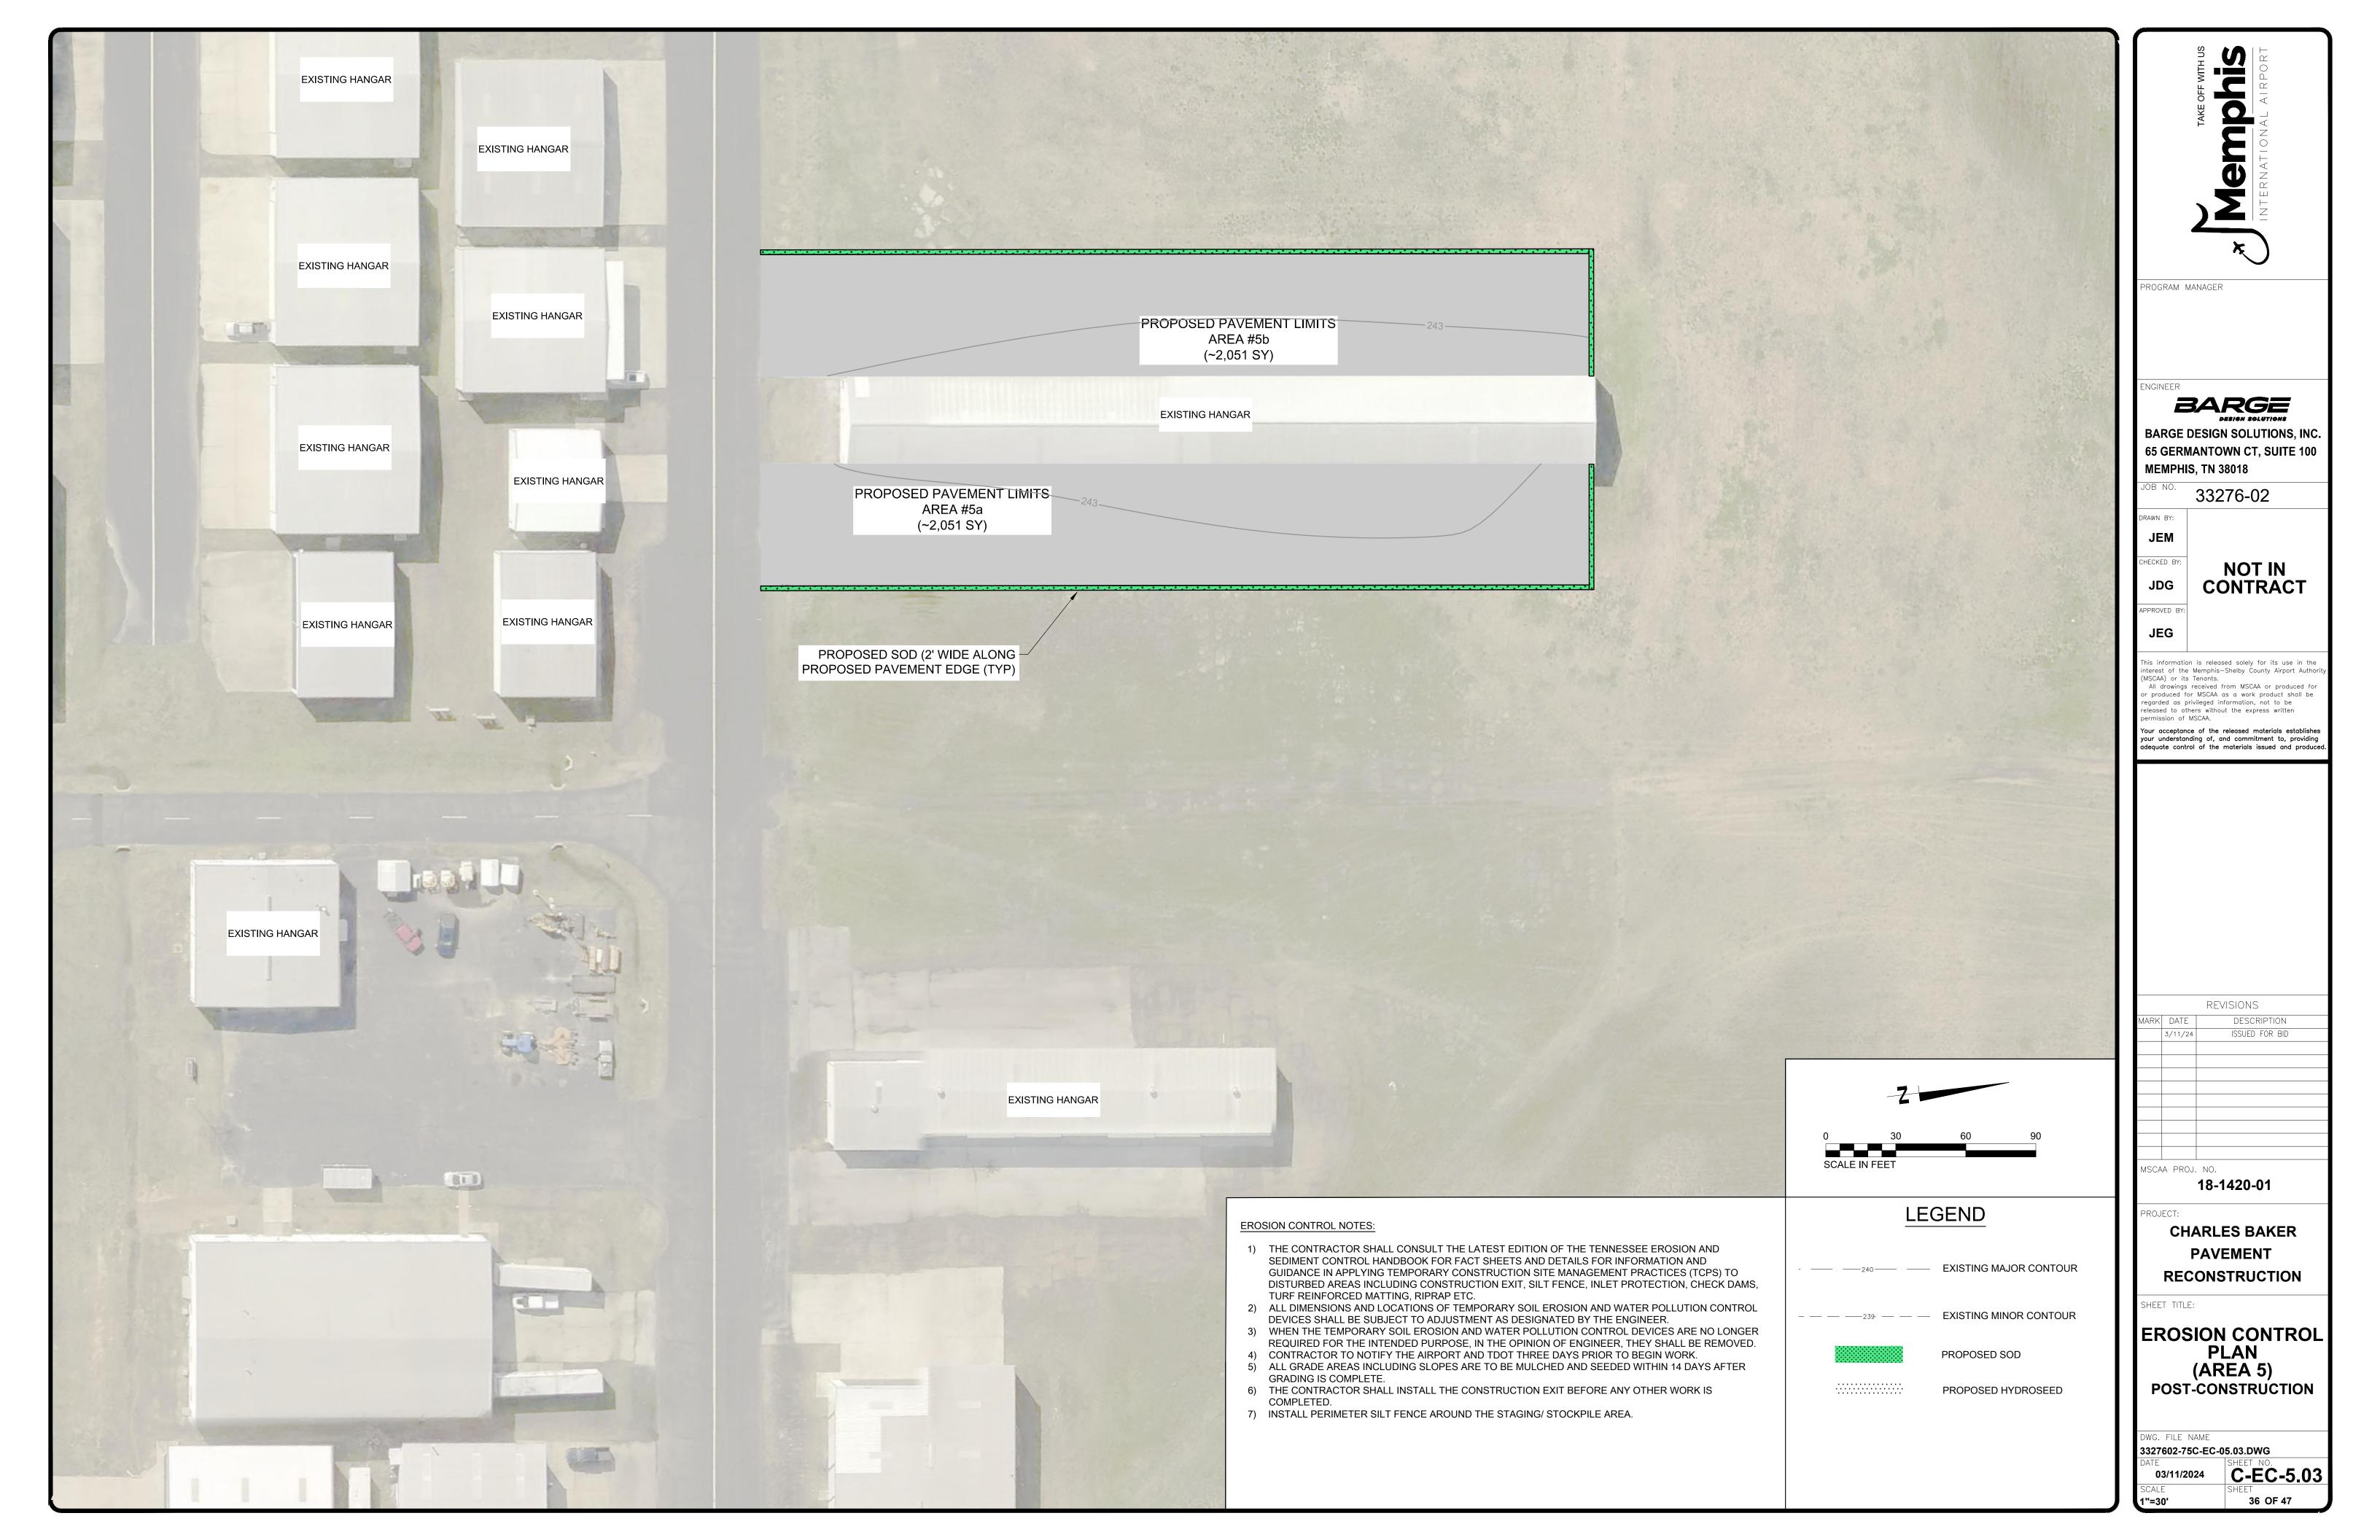

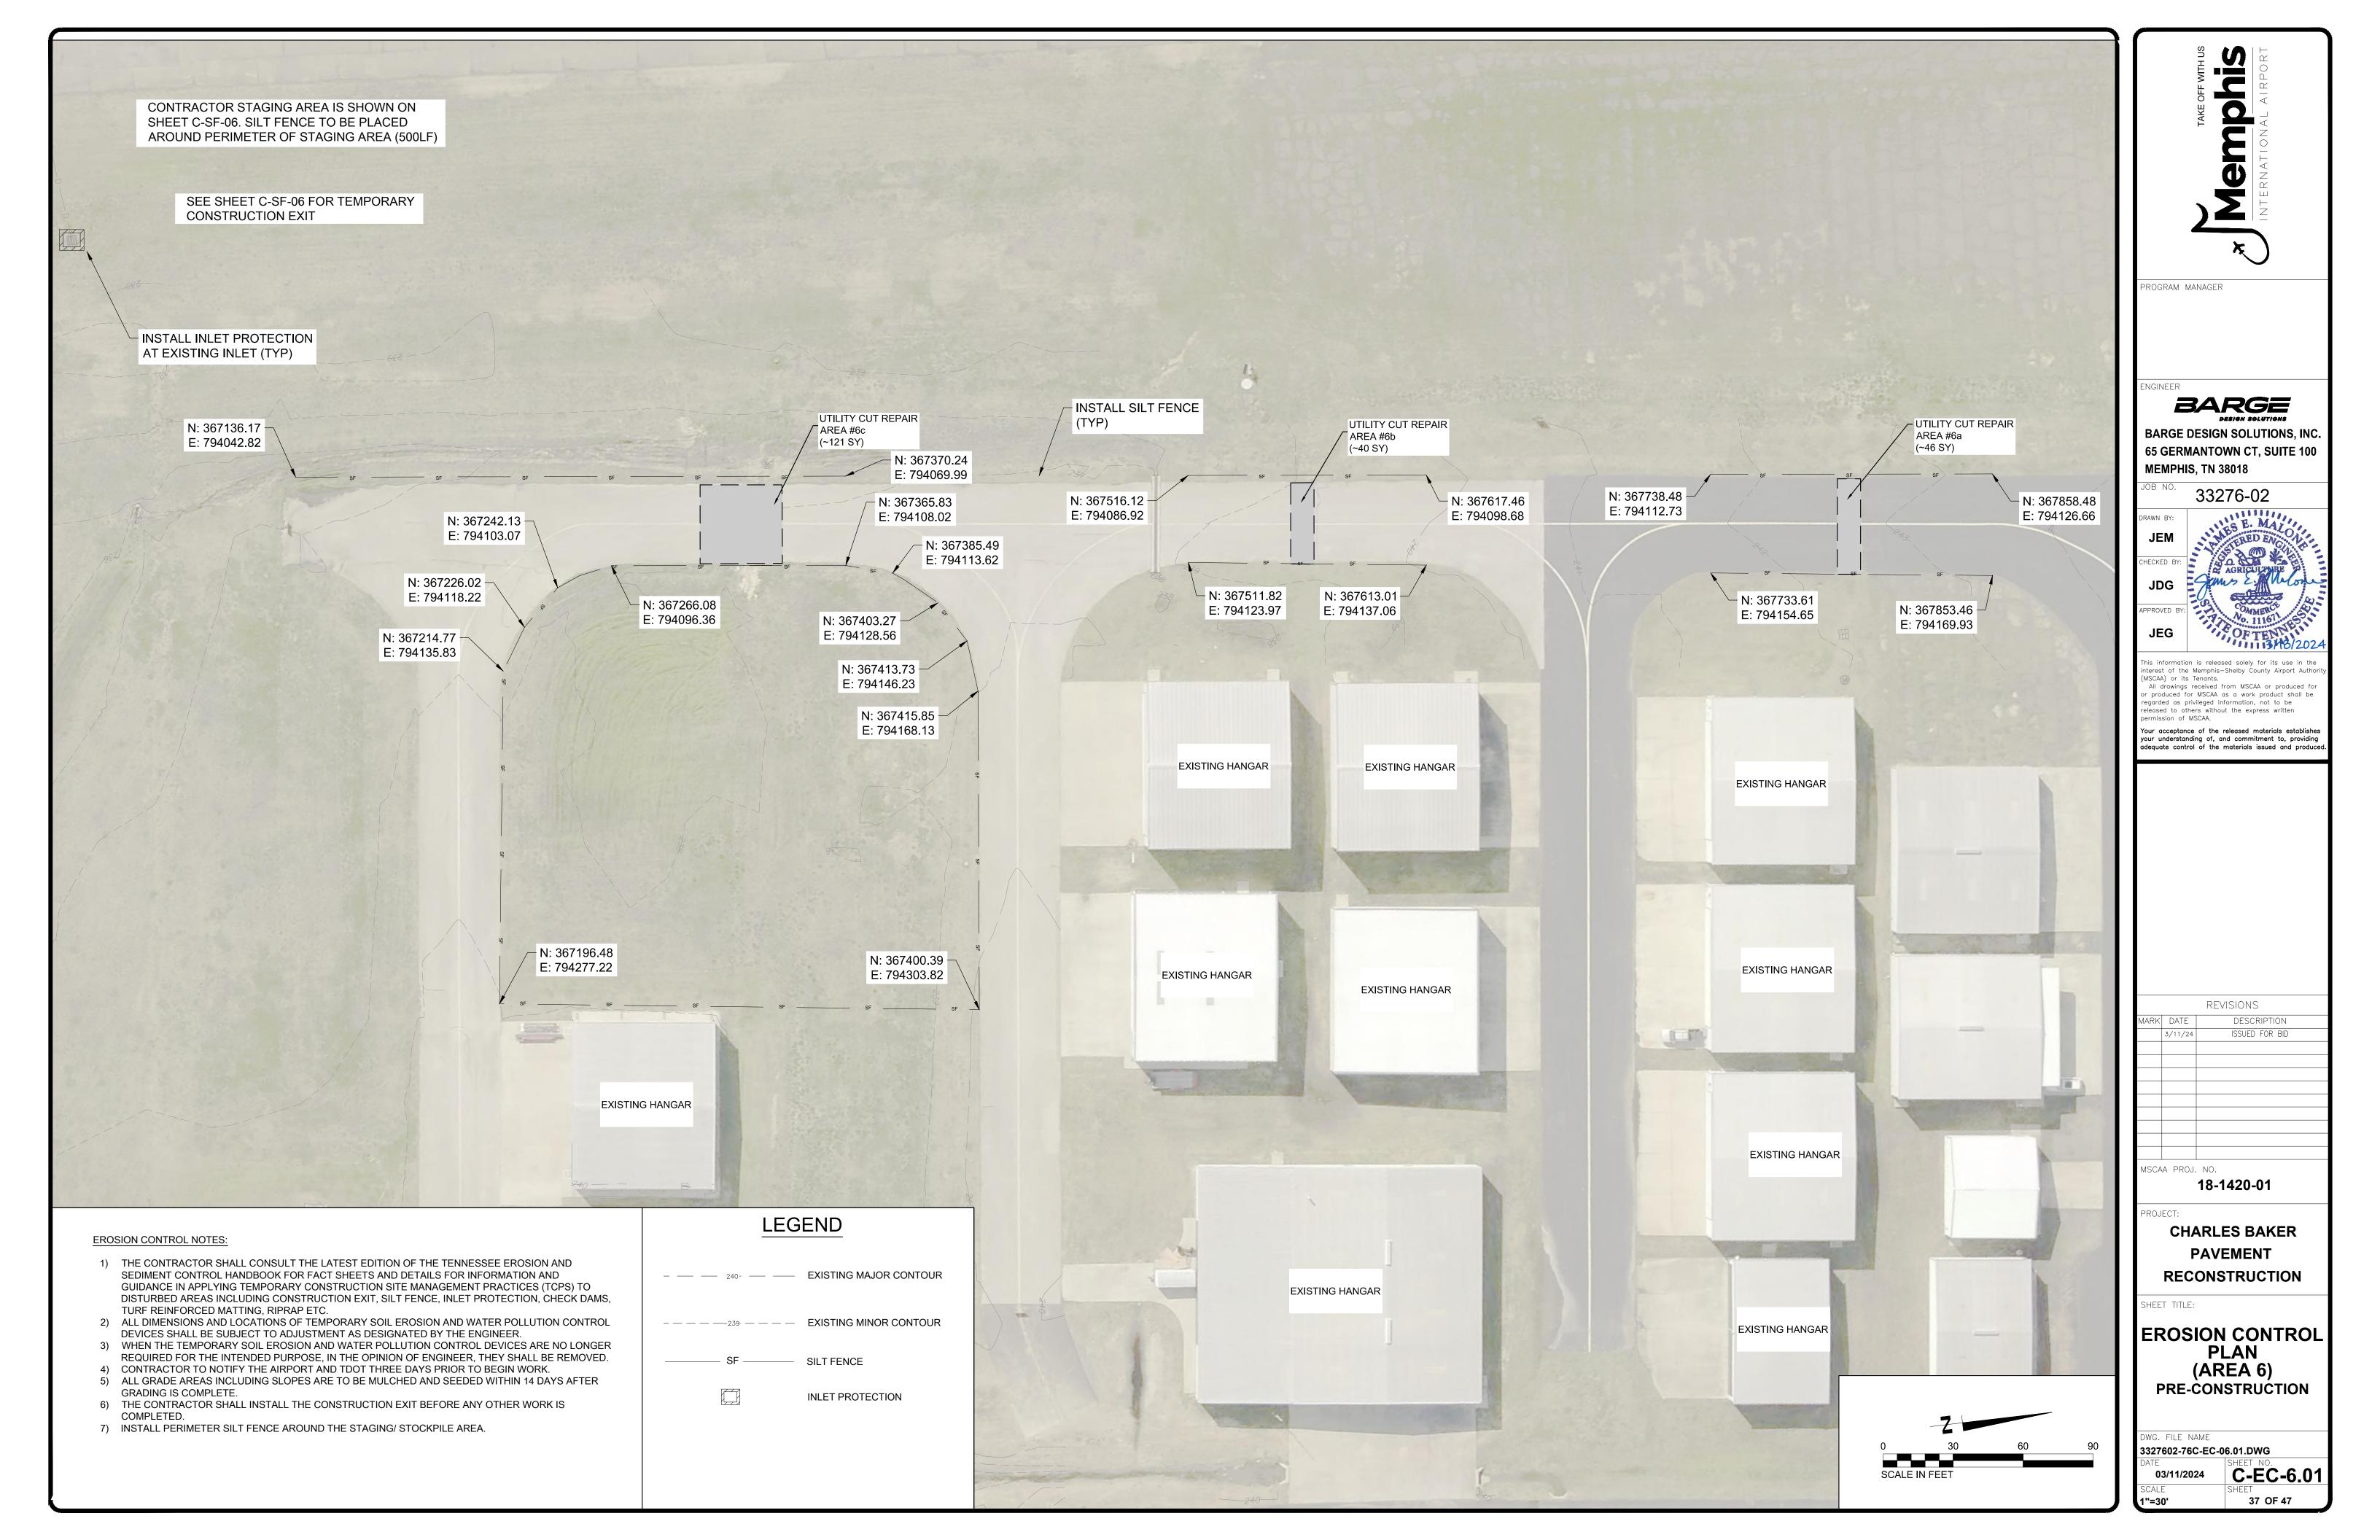

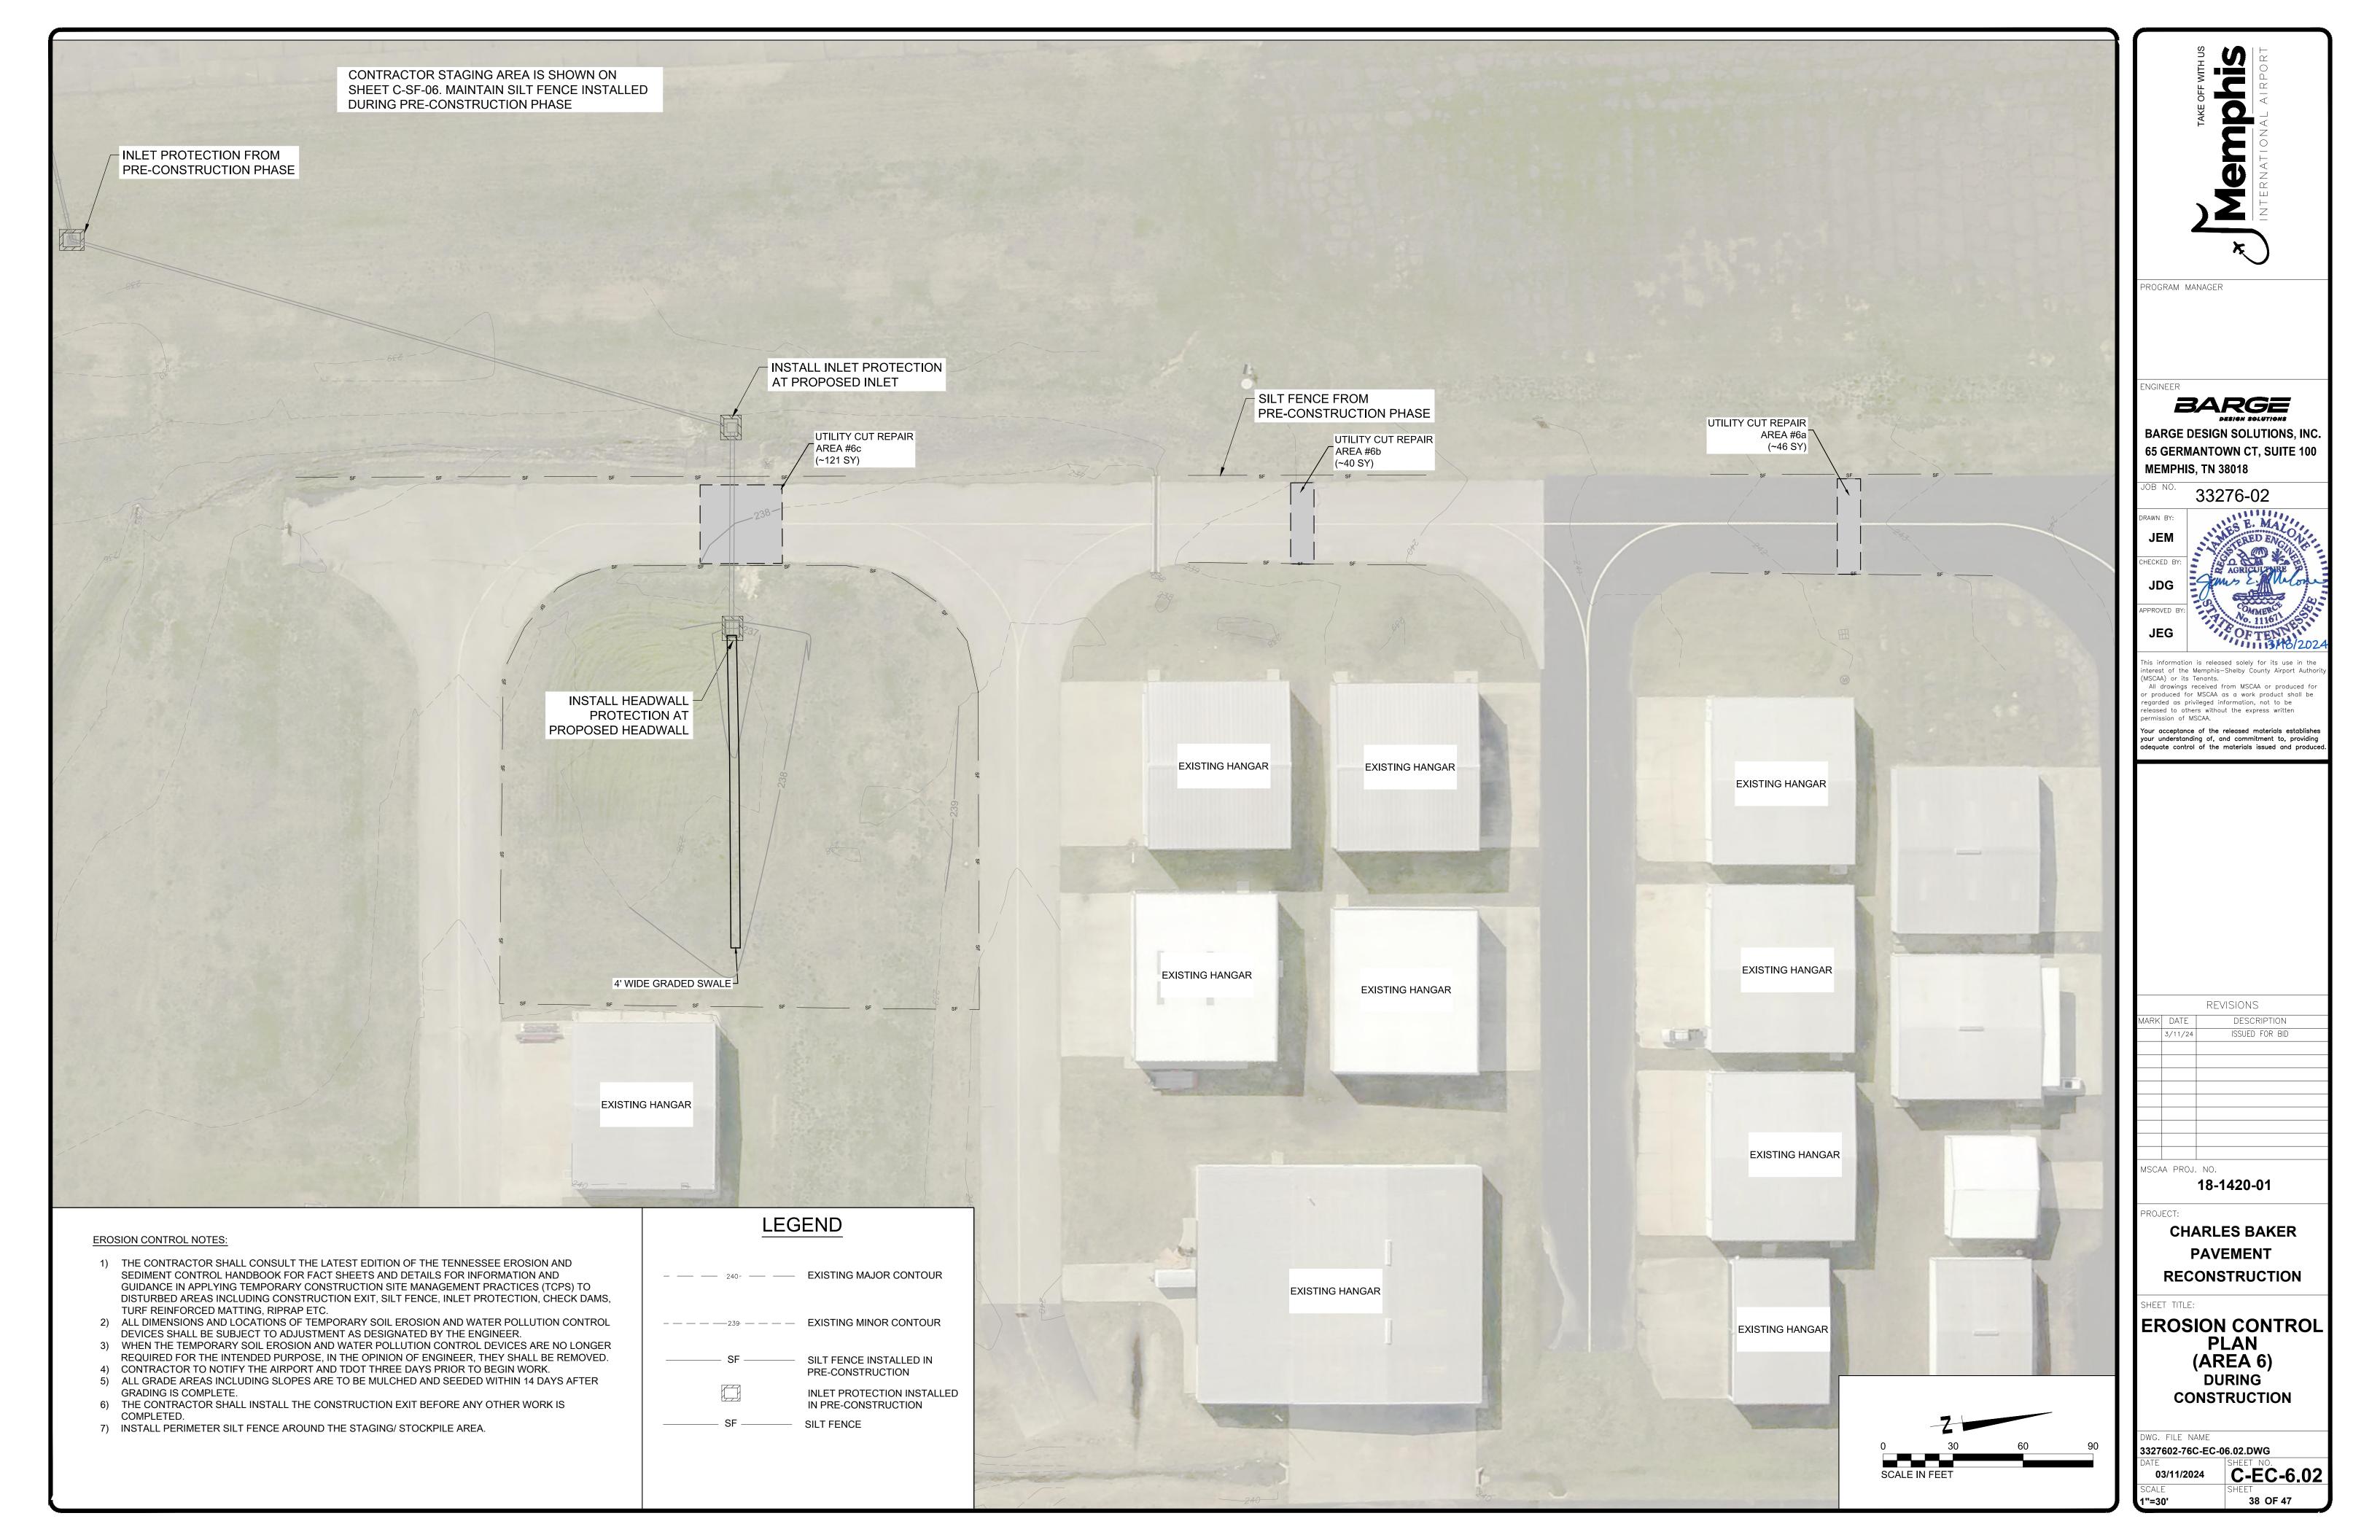

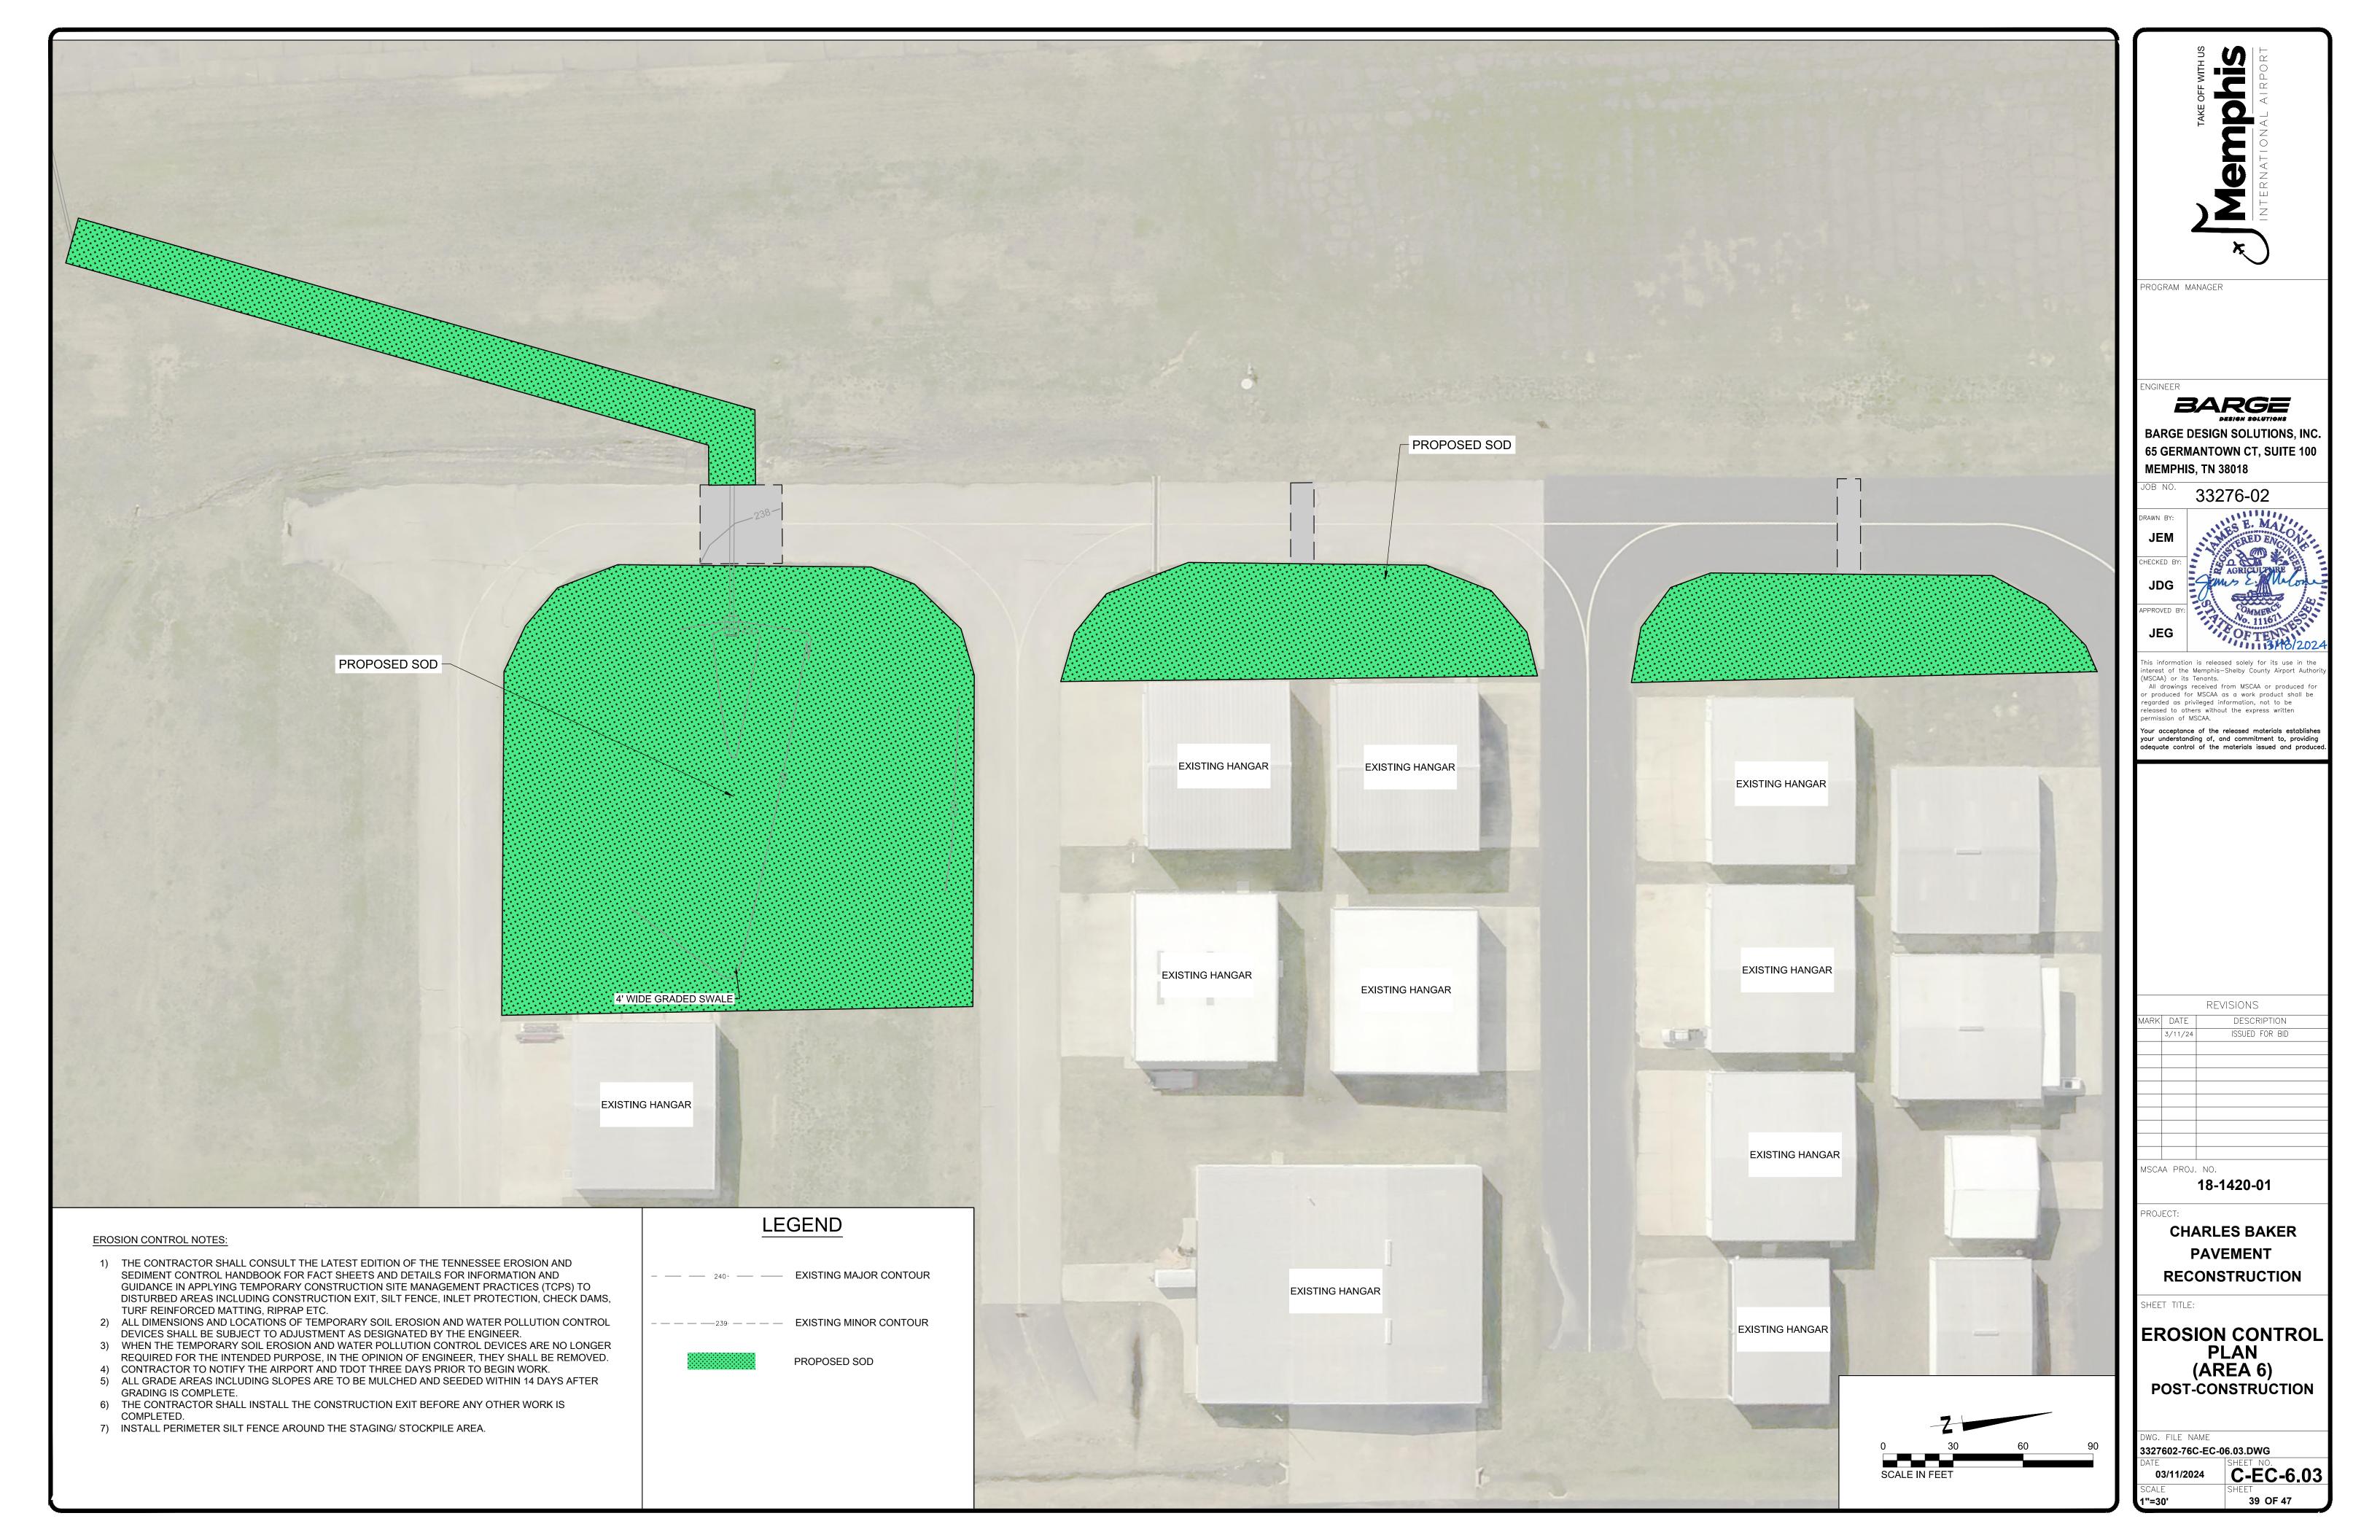

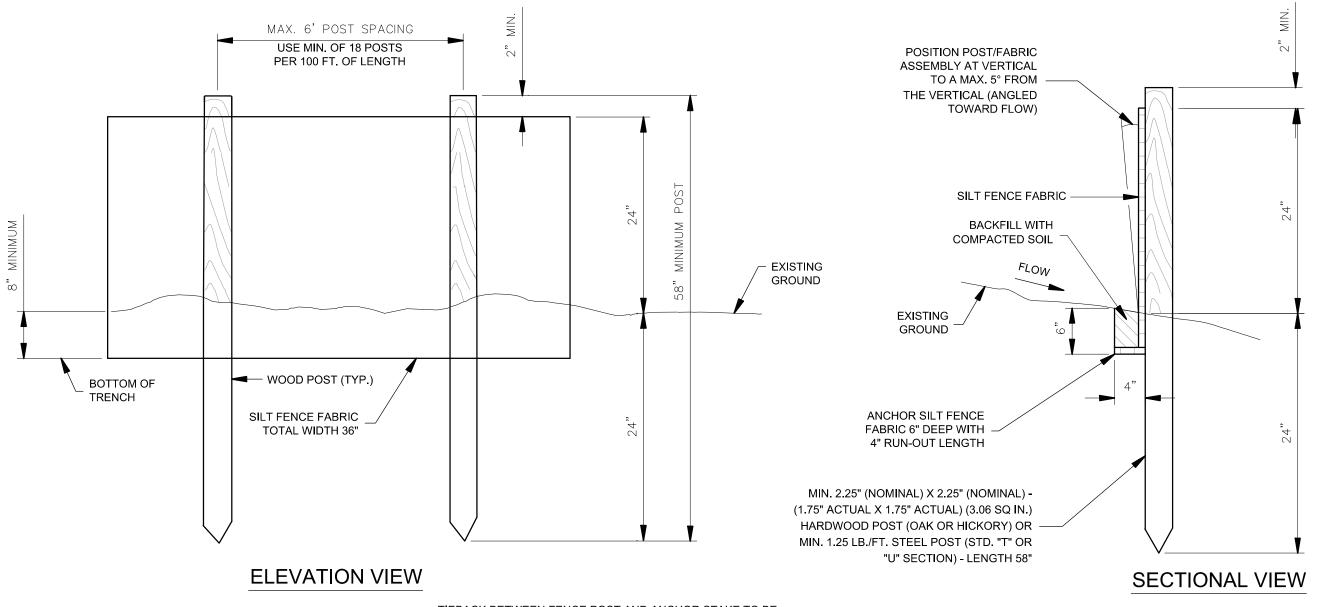


TIEBACK BETWEEN FENCE POST AND ANCHOR STAKE TO BE NO. 8 (0.25") HOLLOW BRAIDED POLYPROPYLENE ROPE WITH MINIMUM TENSILE STRENGTH OF 1,200 POUNDS SECURE TO POST BY WRAPPING SILT FENCE ANCHOR STAKE MIN. 18" LONG TO BE PLACED 12" INTO GROUND

SILT FENCE TIEBACK FOR STEEL POSTS OR WOOD POSTS


©1 EROSION CONTROL SILT FENCE

SILT FENCE NOTES

- FILTER CLOTH SHALL MEET THE REQUIREMENTS OF THE STANDARD SPECIFICATION FOR GEOTEXTILES AASHTO DESIGNATION: M288, SEDIMENT CONTROL, SELF SUPPORTED.
- 2. THE FILTER MATERIAL SHALL BE STAPLED TO THE STAKES. HEAVY DUTY WIRE STAPLES WITH 1/2 INCH WIDTH SHALL BE USED AND EVENLY SPACED WITH AT LEAST FOUR PER POST FOR SILT FENCES AND THREE (3) PER POST FOR FILTER BARRIERS. FILTER MATERIAL SHALL NOT BE STAPLED TO EXISTING TREES.
- MINIMUM (2" NOMINAL X 2" NOMINAL) (1.5" ACTUAL X 1.5" ACTUAL) (2.25 SQ. IN.) HARDWOOD POST (OAK OR HICKORY) - LENGTH 48" OR MINIMUM 1.33 LB./FT. STEEL POST (STD. OR U SECTION.
- 4. WHEN STEEL POSTS ARE USED THEY SHALL HAVE A PROTECTION FOR FASTENING WIRE TO THEM. THE WIRE FASTENERS SHOULD BE EVENLY SPACED WITH AT LEAST FIVE PER POST.
- 5. ACCUMULATED SEDIMENT SHALL BE REMOVED WHEN 12" DEEP.
- 6. INSTALL FENCE ALONG CONTOUR (NEVER UP AND DOWN SLOPE).
- 7. SILT FENCE SHALL BE MAINTAINED UNTIL CONTRIBUTING AREA IS STABILIZED WITH PAVEMENT OR VEGETATION. ALL FENCING SHALL BE REMOVED AFTER STABILIZATION AND DISPOSED OF IN AN APPROVED LANDFILL.

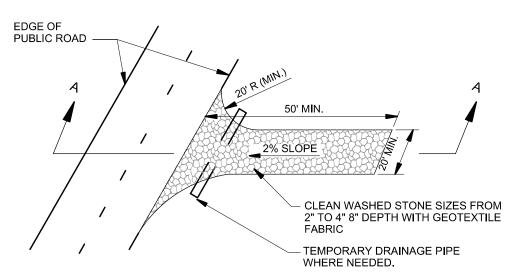

PLAN VIEW OF TEMPORARY CONSTRUCTION EXIT

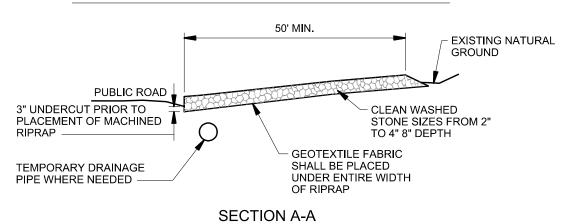


CONSTRUCTION SPECIFICATIONS

- 1. STONE FOR A STABILIZED CONSTRUCTION EXIT SHALL BE 2 INCH STONE, RECLAIMED STONE, OR RECYCLED CONCRETE EQUIVALENT.
- 2. THE LENGTH OF THE STABILIZED EXIT SHALL NOT BE LESS THAN 50 FEET.
- 3. THE THICKNESS OF THE STONE FOR THE STABILIZED EXIT SHALL NOT BE LESS THAN 6 INCHES.
- 4. THE WIDTH OF THE EXIT SHALL NOT BE LESS THAN THE FULL WIDTH OF THE EXIT WHERE INGRESS OR EGRESS OCCURS OR 20 FEET, WHICH EVER IS GREATER.
- 5. GEOTEXTILE FILTER CLOTH SHALL BE PLACED OVER THE ENTIRE AREA PRIOR TO PLACING THE STONE. FABRIC SHALL BE 12 OZ./S.Y. NON-WOVEN.
- 6. ALL SURFACE WATER THAT IS FLOWING TO OR DIVERTED TOWARD THE CONSTRUCTION EXIT SHALL BE PIPED BENEATH THE EXIT. IF PIPING IS IMPRACTICAL, A BERM WITH 5:1 SLOPES THAT CAN BE CROSSED BY VEHICLES MAY BE SUBSTITUTED
- 7. THE EXIT SHALL BE MAINTAINED IN A CONDITION THAT WILL PREVENT TRACKING OR FLOWING OF SEDIMENT ONTO PUBLIC RIGHTS-OF-WAY. THIS MAY REQUIRE PERIODIC TOPDRESSING WITH ADDITIONAL STONE AS CONDITIONS DEMAND AND REPAIR AND/OR CLEANOUT OF ANY MEASURES USED TO TRAP SEDIMENT. ALL SEDIMENT SPILLED, WASHED, OR TRACKED ONTO PUBLIC RIGHT-OF-WAY MUST BE

TEMPORARY CONSTRUCTION EXIT

C-102-5.4

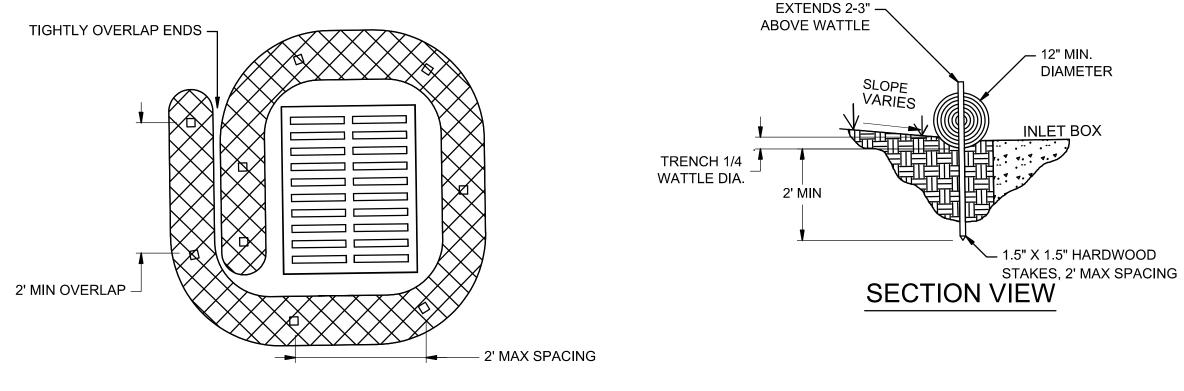

PLAN VIEW

NOTES:

- WATTLE MATERIAL SHALL COMPLY WITH TDOT HIGHWAY CONSTRUCTION SPECIFICATIONS.
- 2. SLOPE BARRIERS SHALL BE PLACED ALONG CONTOUR LINES, WITH A SHORT SECTION TURNED UPGRADE AT EACH END OF THE BARRIER. MAXIMUM LENGTH OF THE SLOPE BARRIER SHALL NOT EXCEED 250'. BARRIER ENDS SHALL BE STAGGERED.
- 3. WITH APPROVAL OF THE ENGINEER, SILT FENCE MAY BE ALLOWED AS AN ALTERNATIVE SLOPE BARRIER.
- 4. WATTLES USED TO CONTROL SHEET FLOW AT PAVEMENT EDGES SHALL BE WEIGHTED WITH GRAVEL BAGS OR APPROVE EQUAL.

NOTES:

1. WATTLE MATERIAL SHALL COMPLY WITH TDOT HIGHWAY CONSTRUCTION SPECIFICATIONS OR EQUAL.



WATTLE INLET PROTECTION

SCALE: NONE C-102-5.2

WATTLES CAN ALSO BE WEIGHTED WITH GRAVEL BAGS WHERE STAKING IS NOT POSSIBLE.

TAKE OFF WITH US

WEEN ATTONAL AIRPORT

ROGRAM MANAGER

BARGE DESIGN SOLUTIONS, INC
65 GERMANTOWN CT, SUITE 100

33276-02

JEM

ECKED BY:

JDG

PROVED BY:

JEG

MEMPHIS, TN 38018

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REVISIONS

MARK DATE DESCRIPTION

3/11/24 ISSUED FOR BID

MSCAA PROJ. NO. **18-1420-01**

CHARLES BAKER
PAVEMENT
RECONSTRUCTION

SHEET TITLE:


EROSION CONTROL DETAILS


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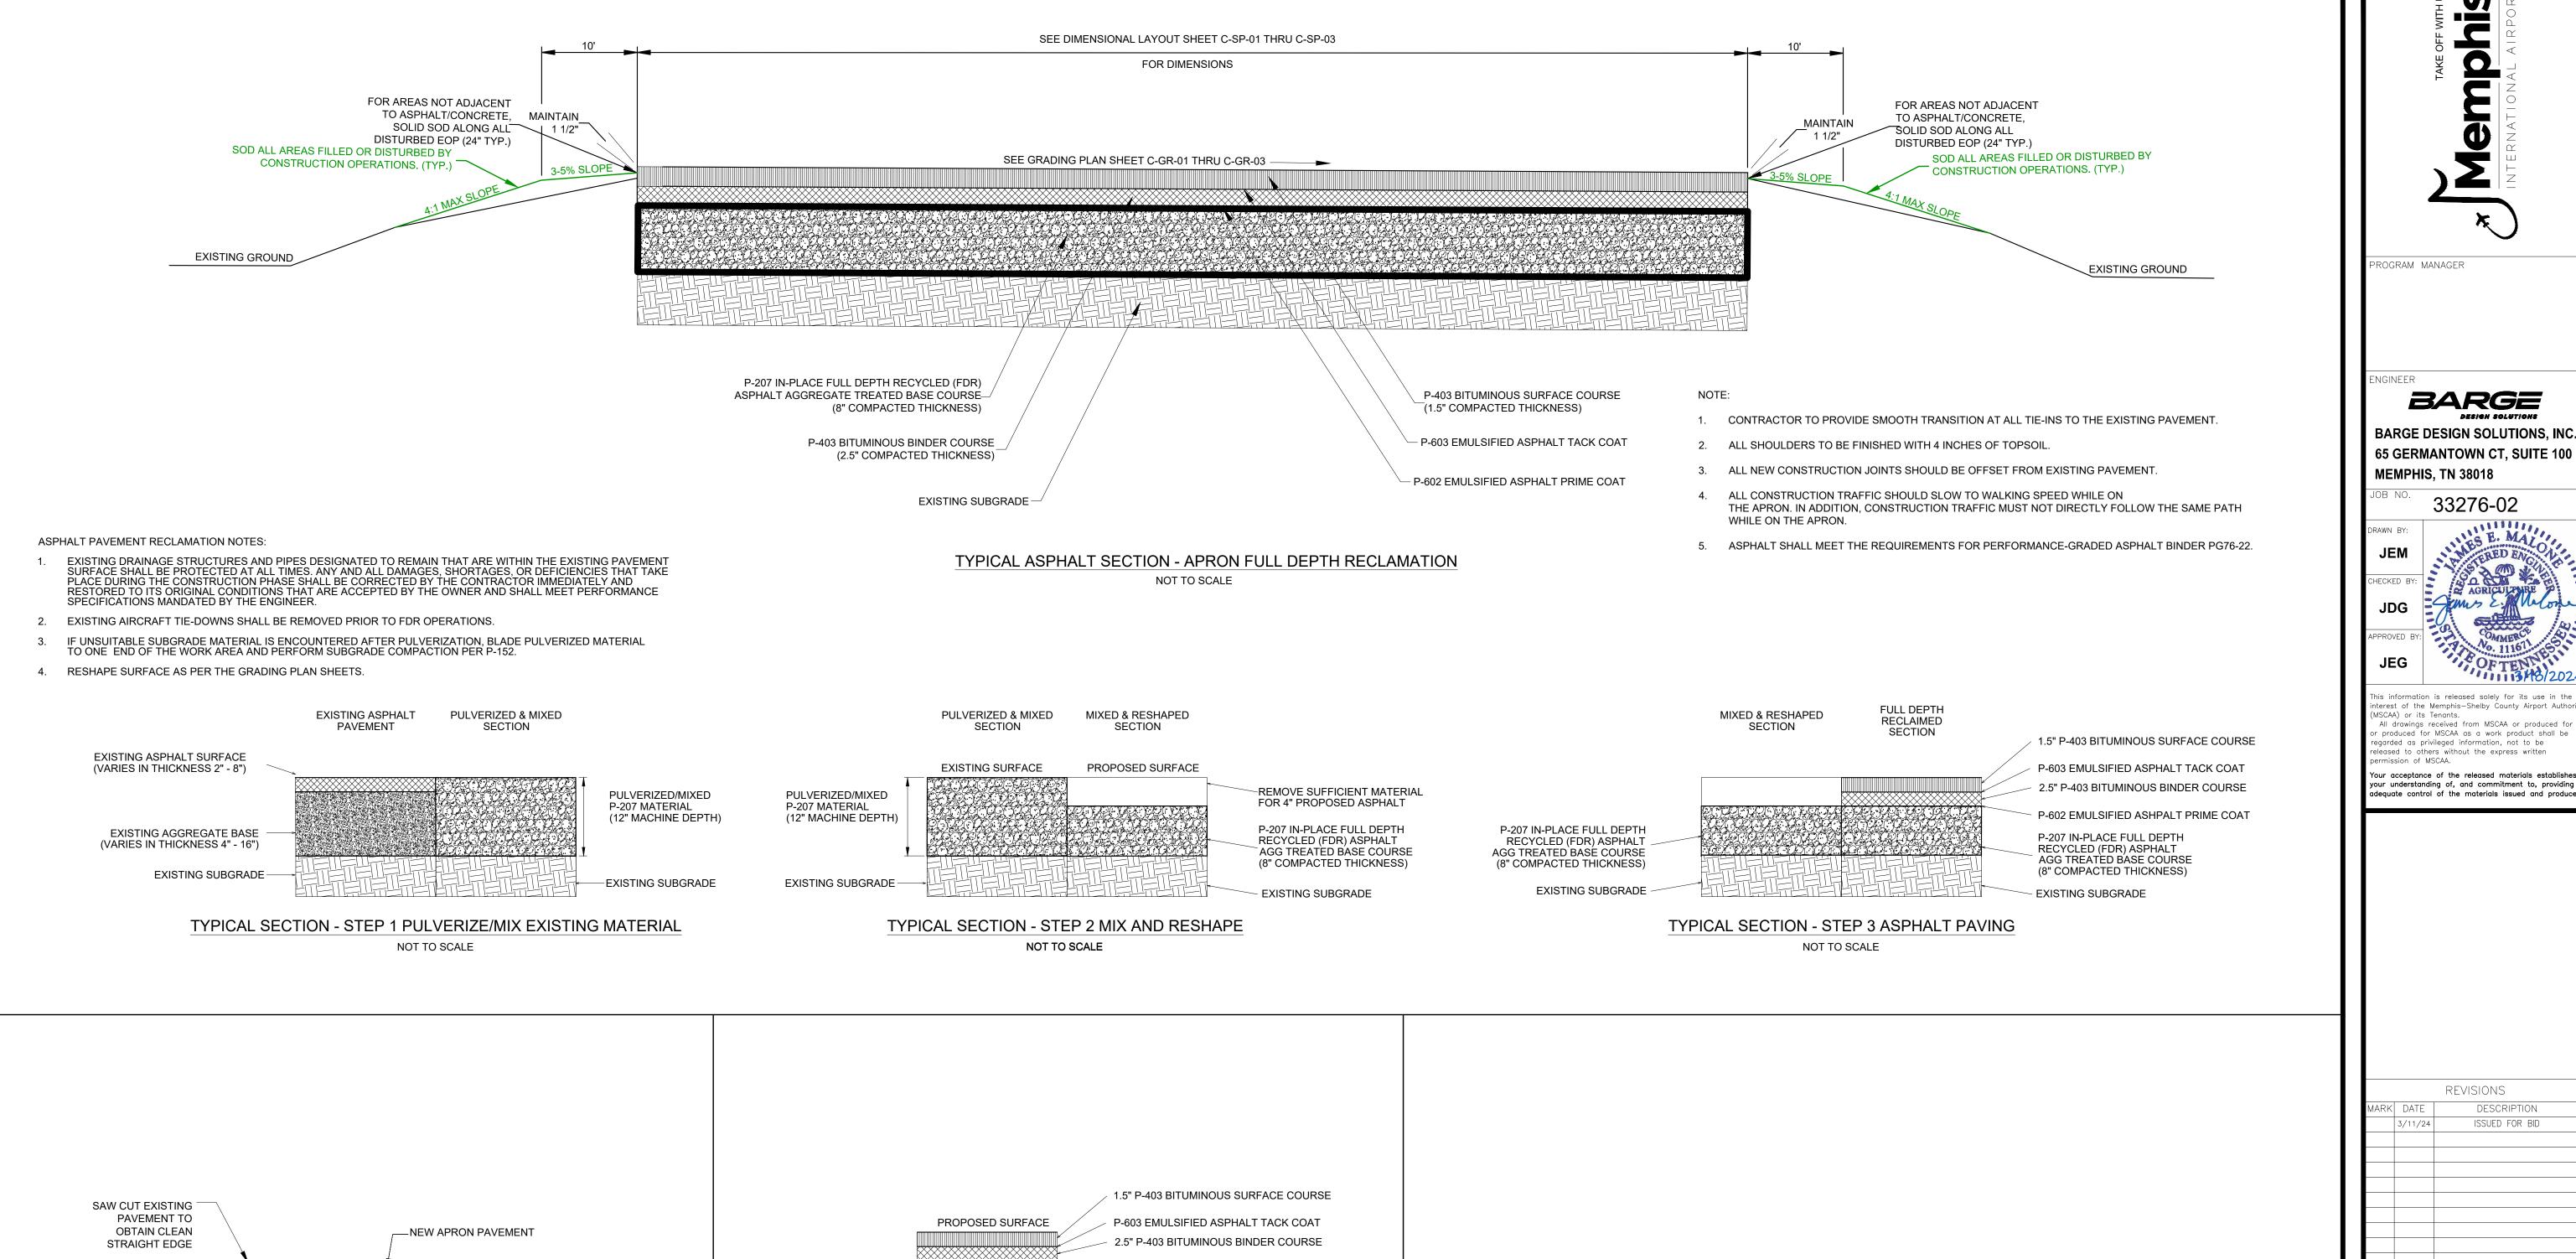
3327602-77C-EC-07.01.DWG

03/11/2024 SHEET NO. C-EC-7.01

SHEET 40 OF 47



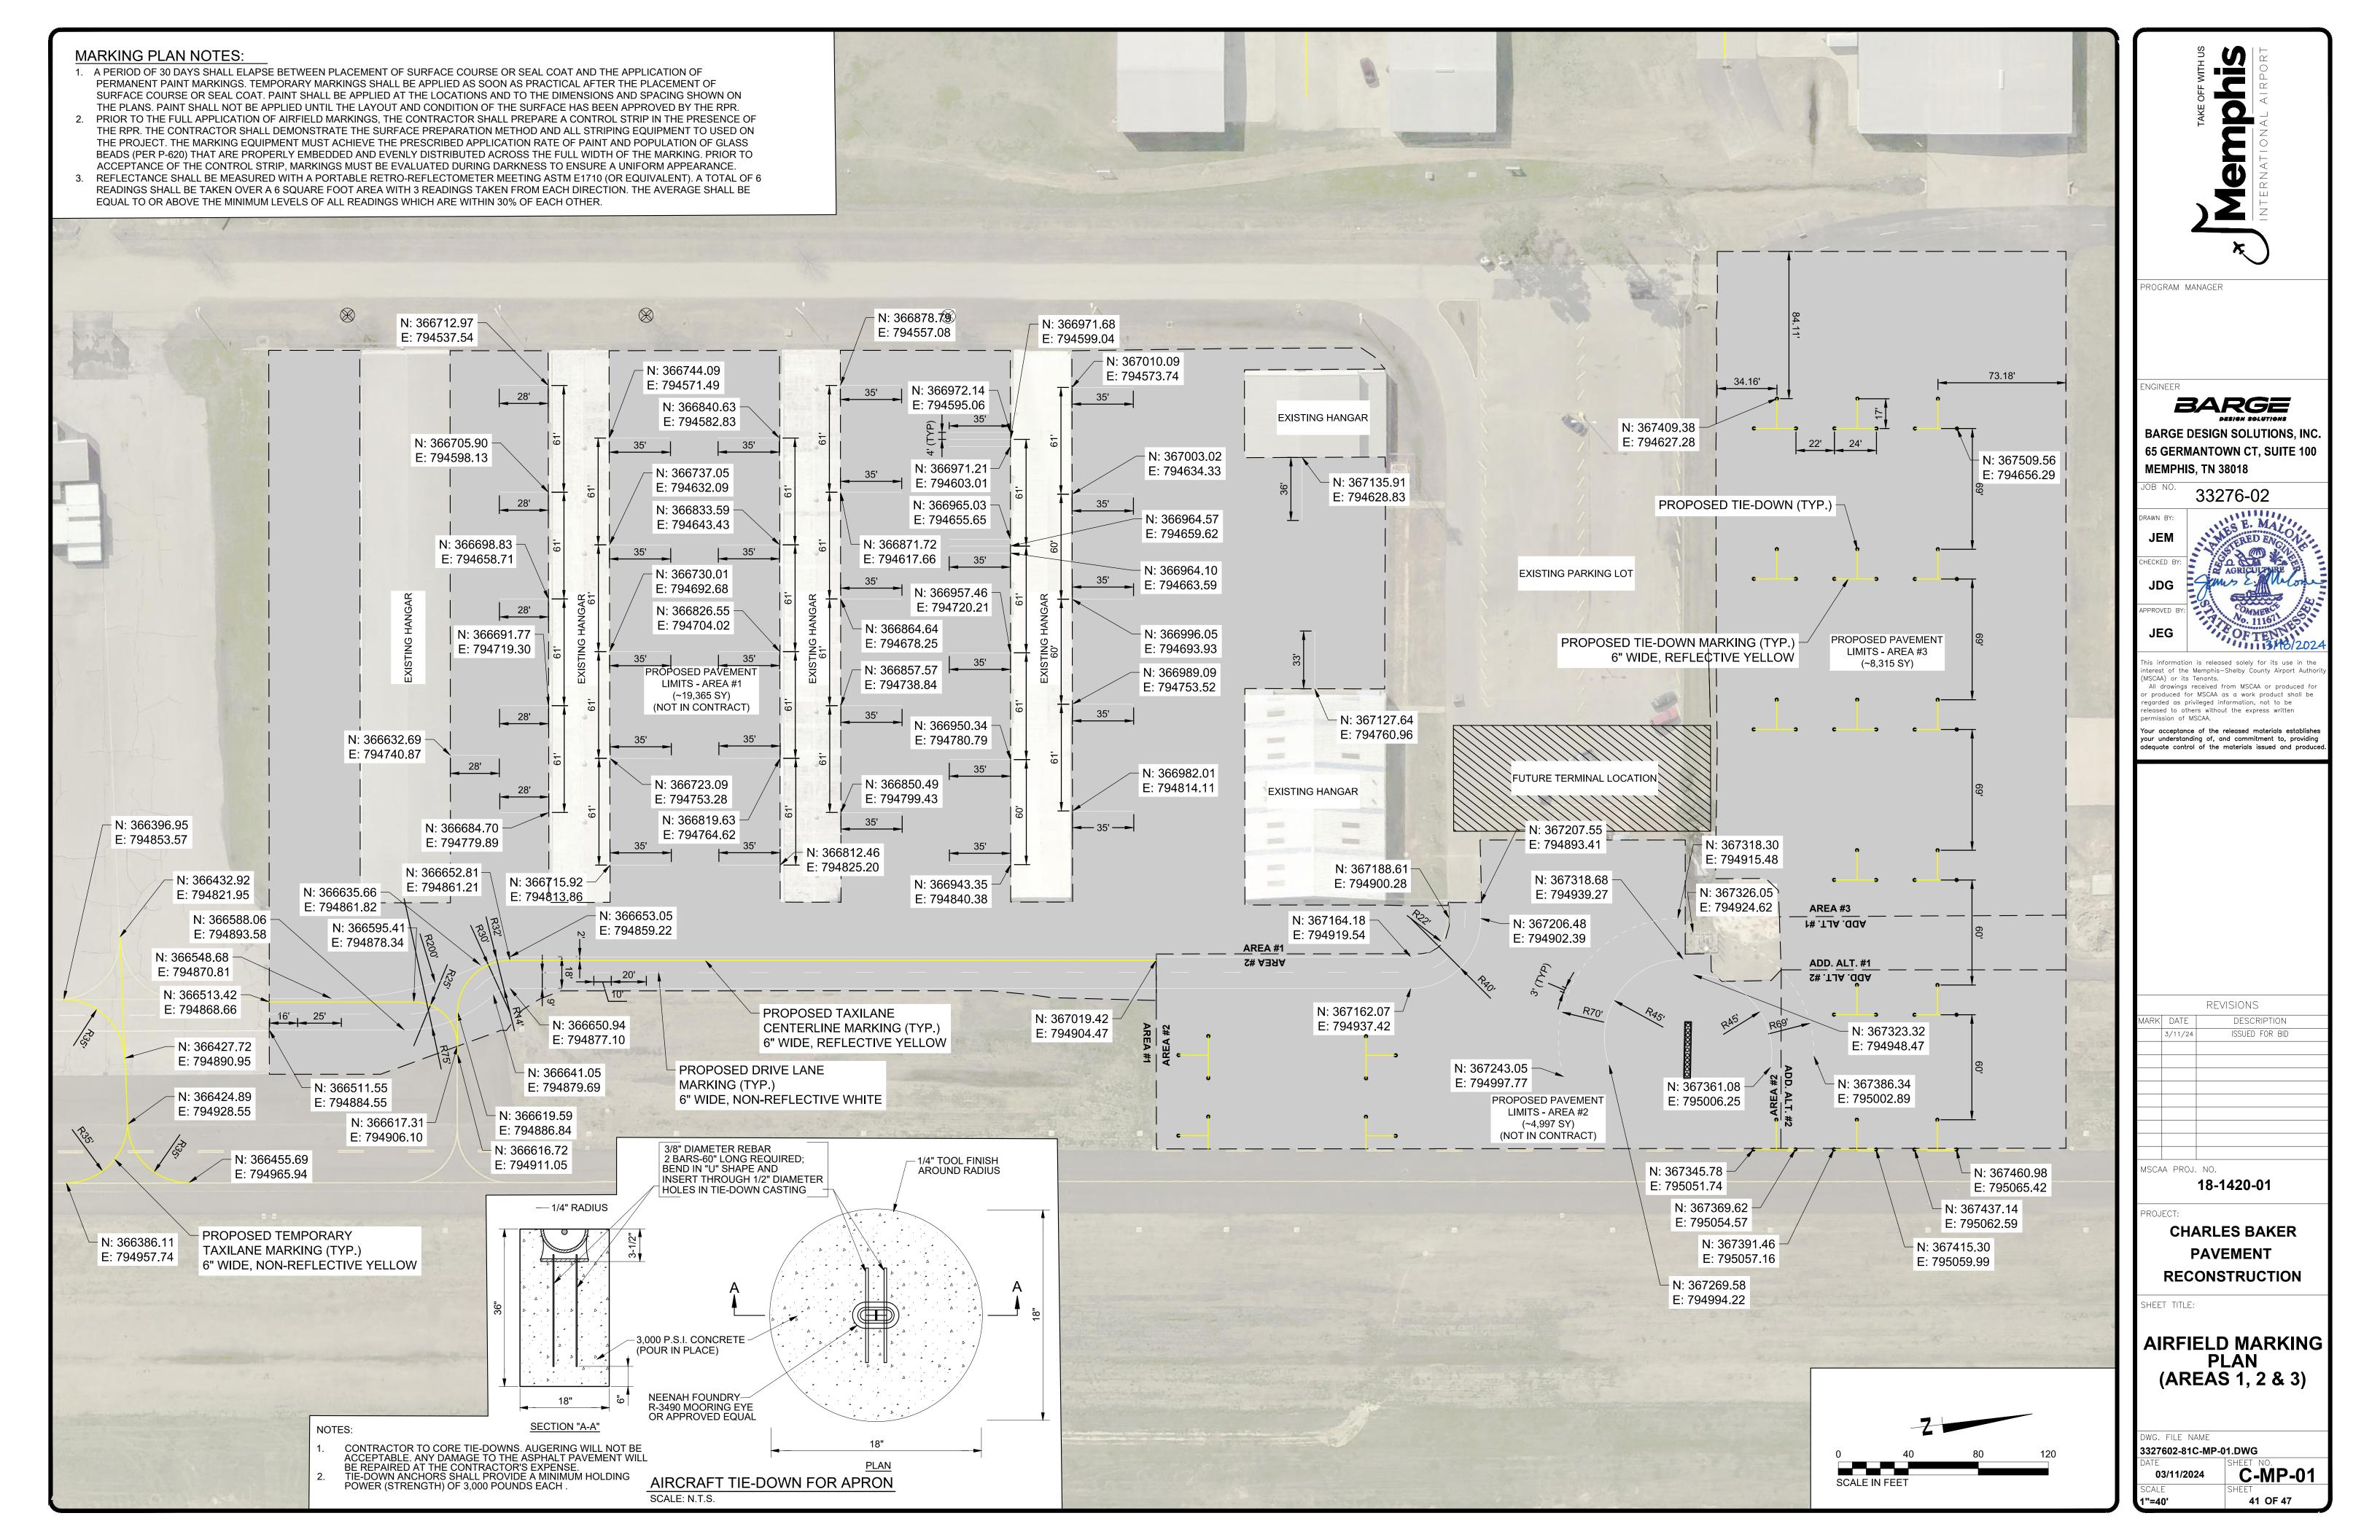

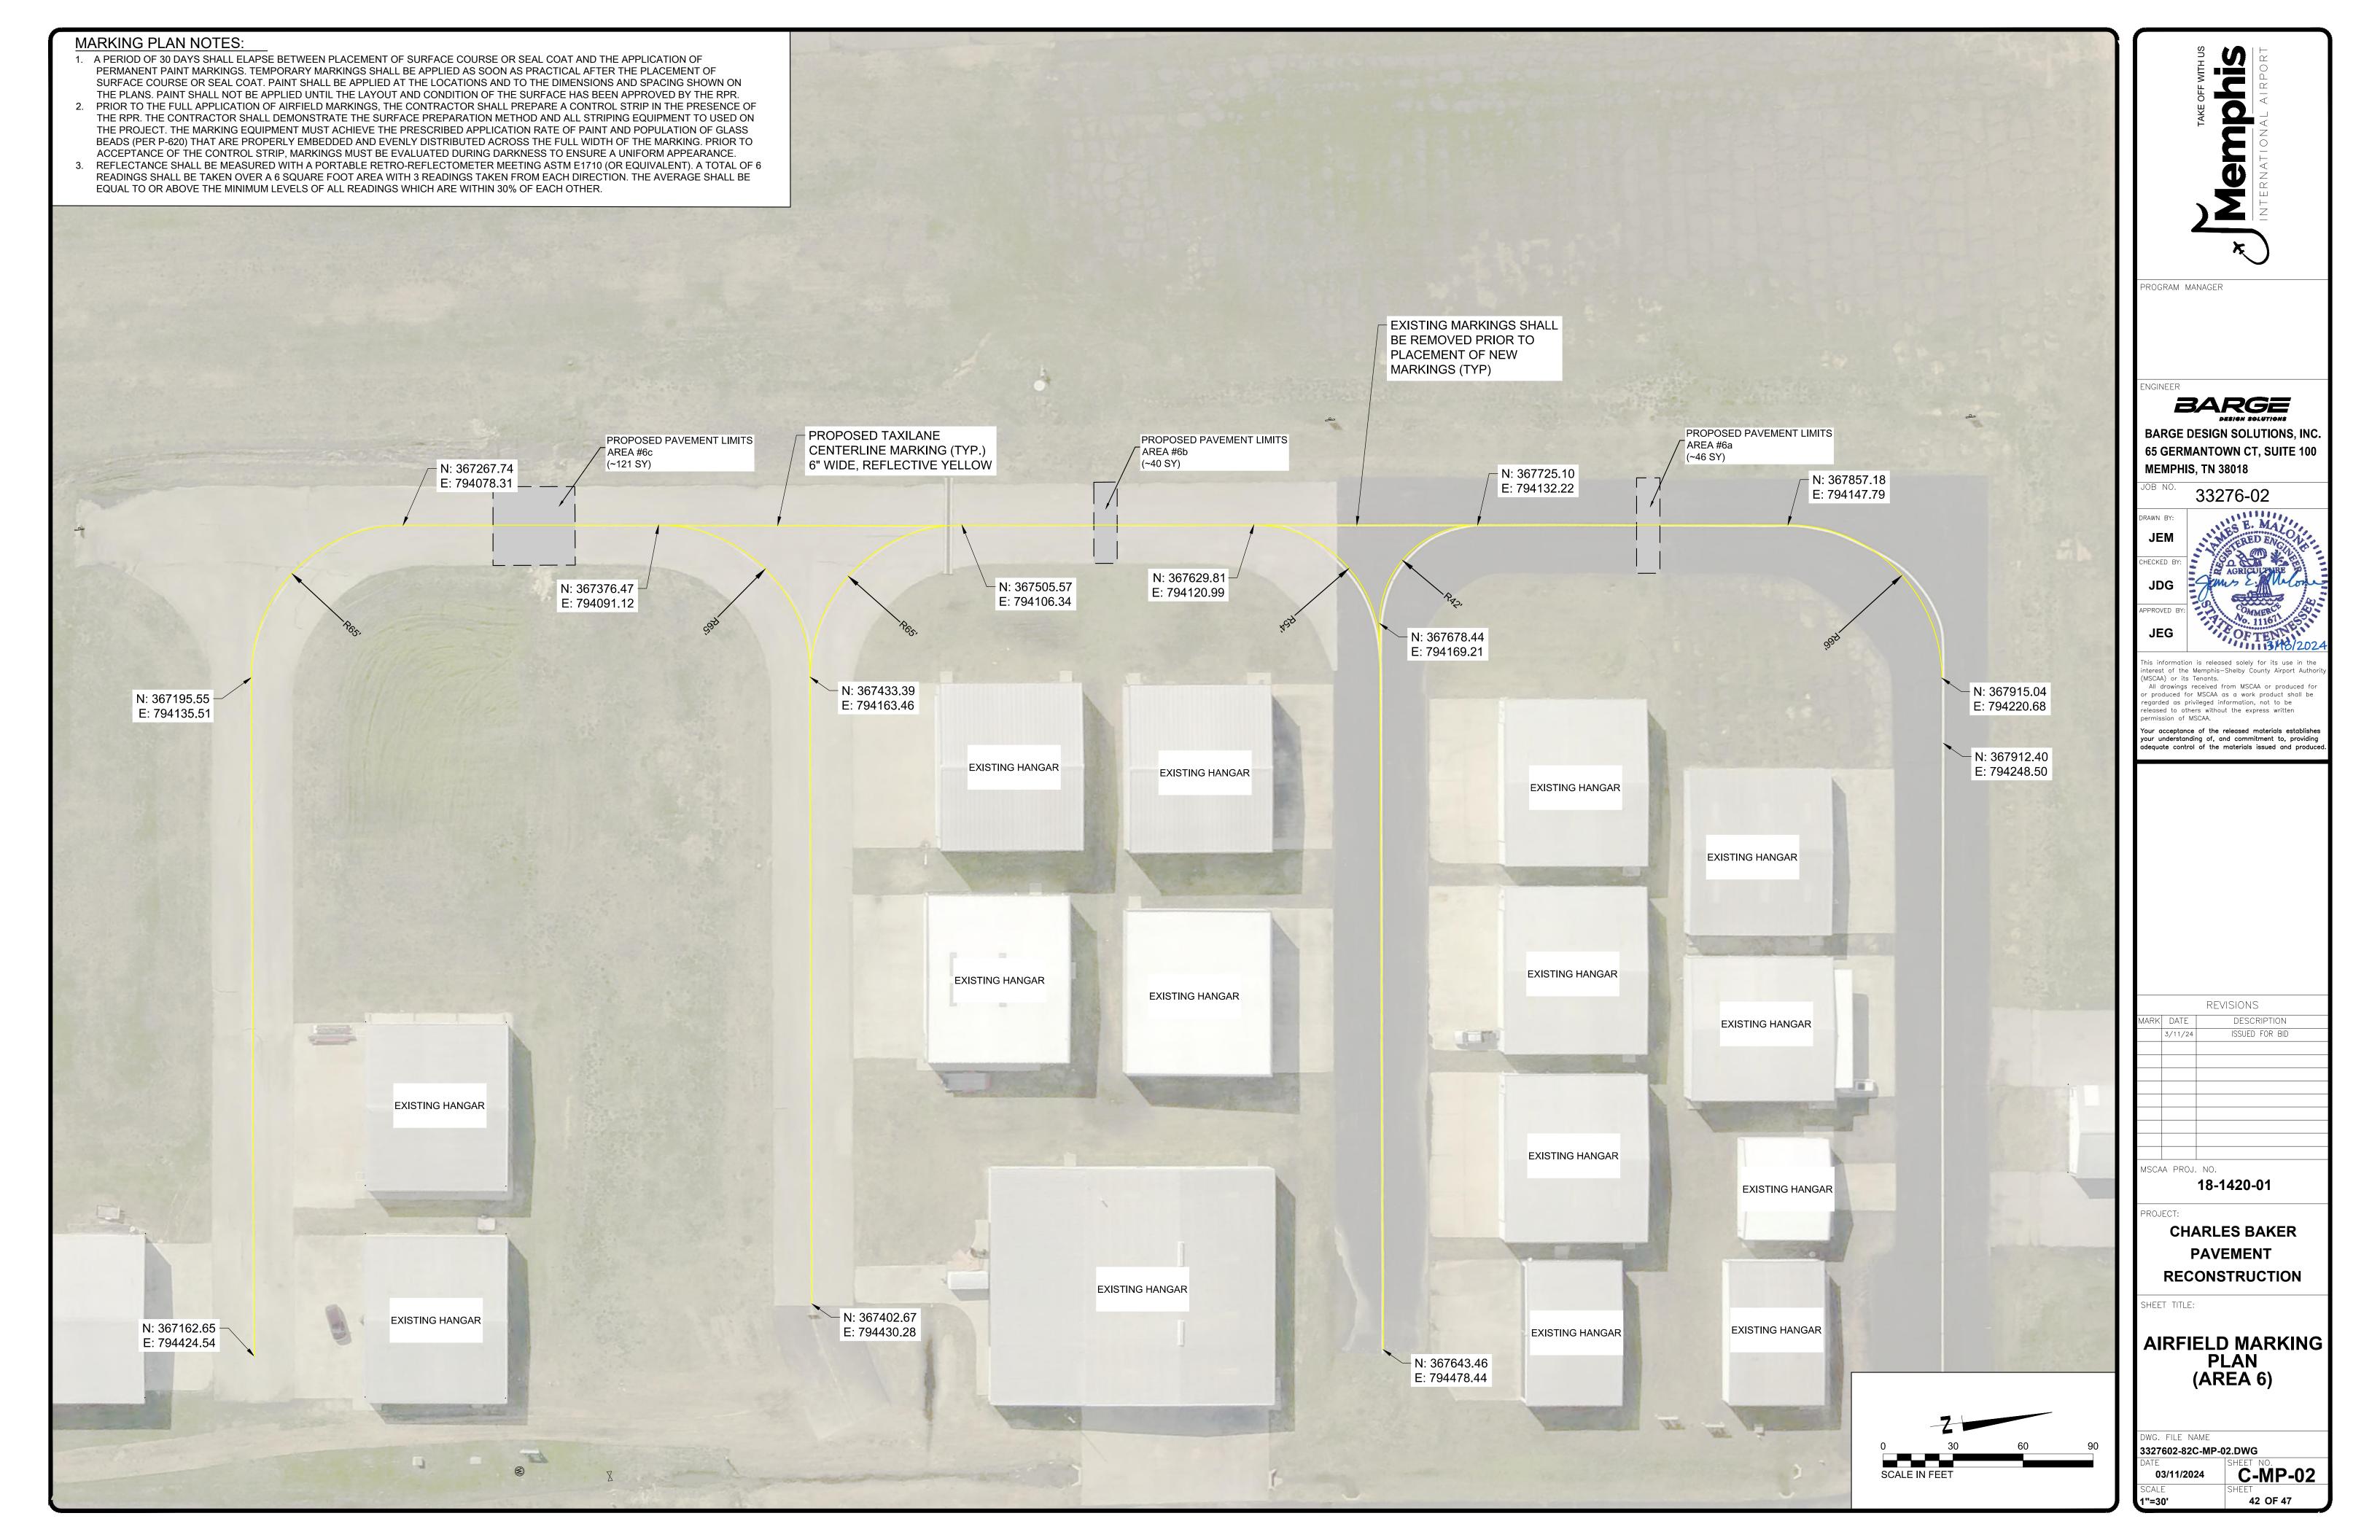

P-209 CRUSHED AGGREGATE BASE COURSE

(6" COMPACTED THICKNESS)

- EXISTING BASE & SUBGRADE

1. UTILITY CUT DEMOLITION TO REMOVE ASPHALT SURFACE AND BASE MATERIAL TO A DEPTH OF 10" TO

BINDER COURSE, P-603 EMULSIFIED ASPHALT TACK COAT, AND 1.5" P-403 BITUMINOUS SURFACE

COURSE IS CONSIDERED INCIDENTAL TO P-101-5.5. NO SEPARATE PAY ITEMS FOR THE ABOVE WHEN

2. P-209 CRUSHED AGGREGATE BASE COURSE (6" COMPACTED THICKNESS), 2.5" P-403 BITUMINOUS

PREPARE FOR UTILITY CUT REPAIR PATCH IS CONSIDERED INCIDENTAL TO P-101-5.5. NO SEPARATE

NOTES:

PAY ITEM FOR UTILITY CUT DEMOLITION.

USED TO CONSTRUCT THE UTILITY CUT REPAIR.

TYPICAL SECTION - UTILITY CUT REPAIR

(P-101-5.5)

NOT TO SCALE

EXISTING APRON PAVEMENT

TRANSITIONAL TIE-IN NOTES:

EX. SUBGRADE

1. CONTRACTOR TO PROVIDE SMOOTH TRANSITION AT ALL EXISTING PAVEMENTS. (SEE DETAIL ABOVE)

TYPICAL SECTION - ASPHALT TIE-IN AT EXISTING PAVEMENT

NOT TO SCALE

TYPICAL SECTION - TRANSITIONAL TIE-IN

NOT TO SCALE

2. ALL NEW CONSTRUCTION JOINTS SHOULD BE OFFSET FROM EXISTING PAVEMENT.

REVISIONS

MARK DATE DESCRIPTION

3/11/24 ISSUED FOR BID

MSCAA PROJ. NO.

18-1420-01

PROJECT:

CHARLES BAKER

PAVEMENT

RECONSTRUCTION

SHEET TITLE:

DETAILS

DWG. FILE NAME

3327602-91C-DT-01.DWG

DATE


03/11/2024


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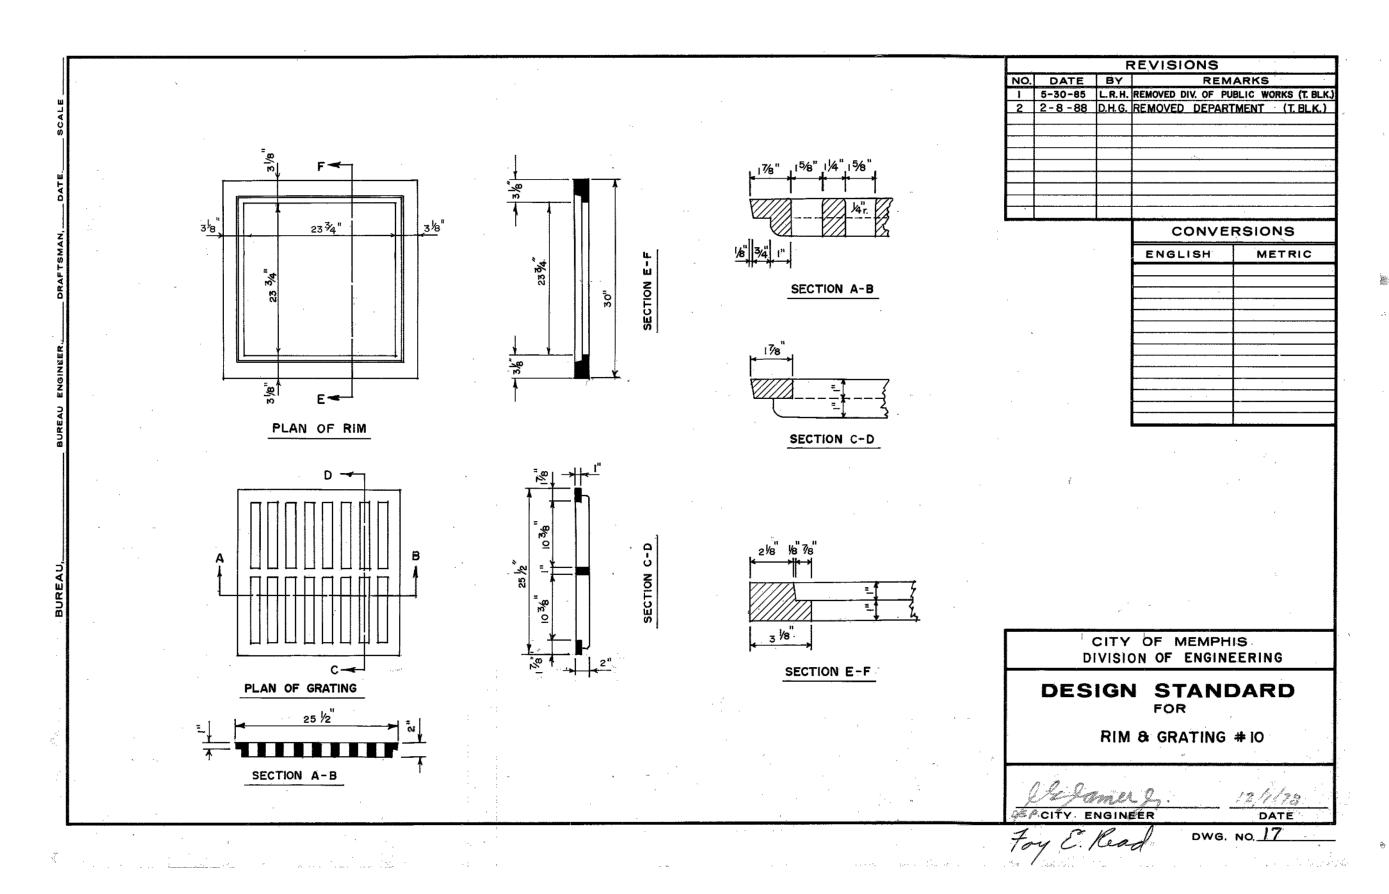
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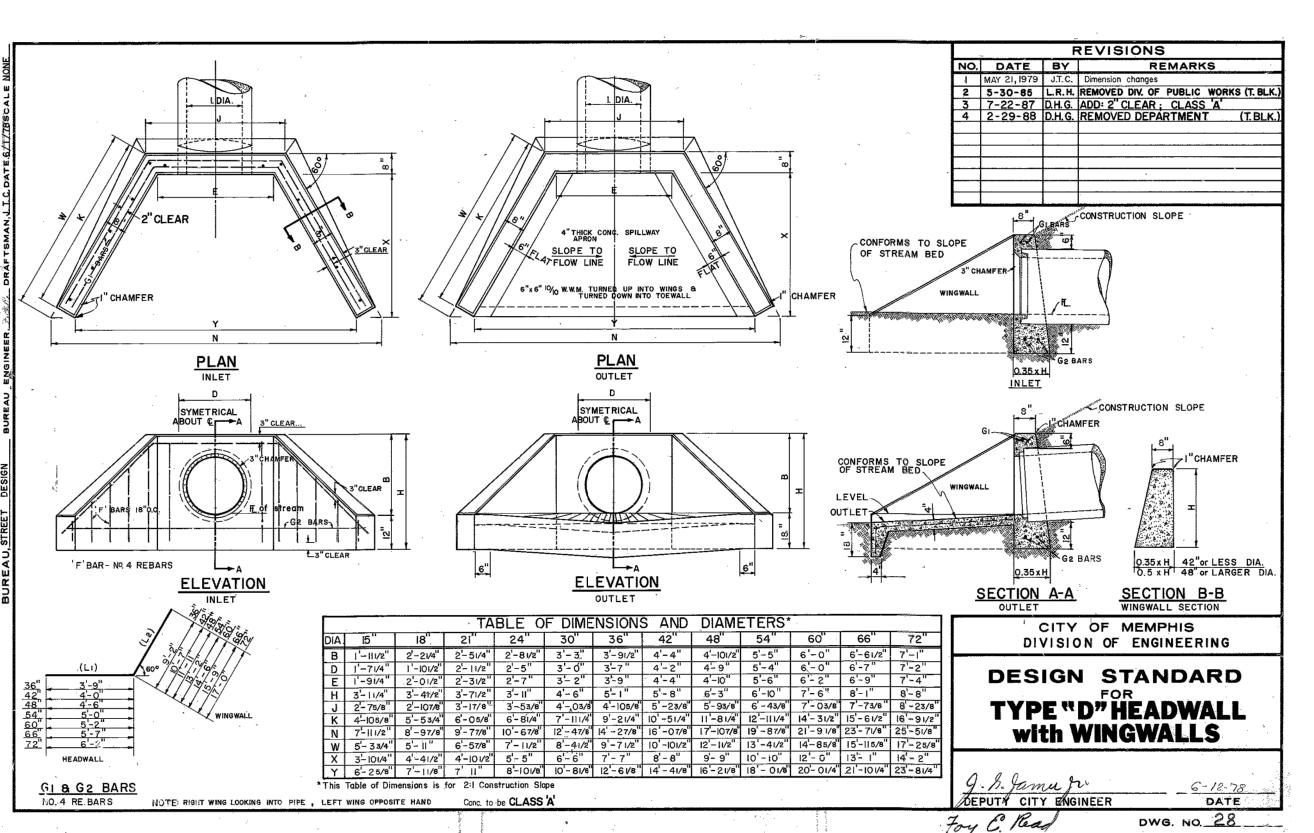
SHEET

A3 OF 47





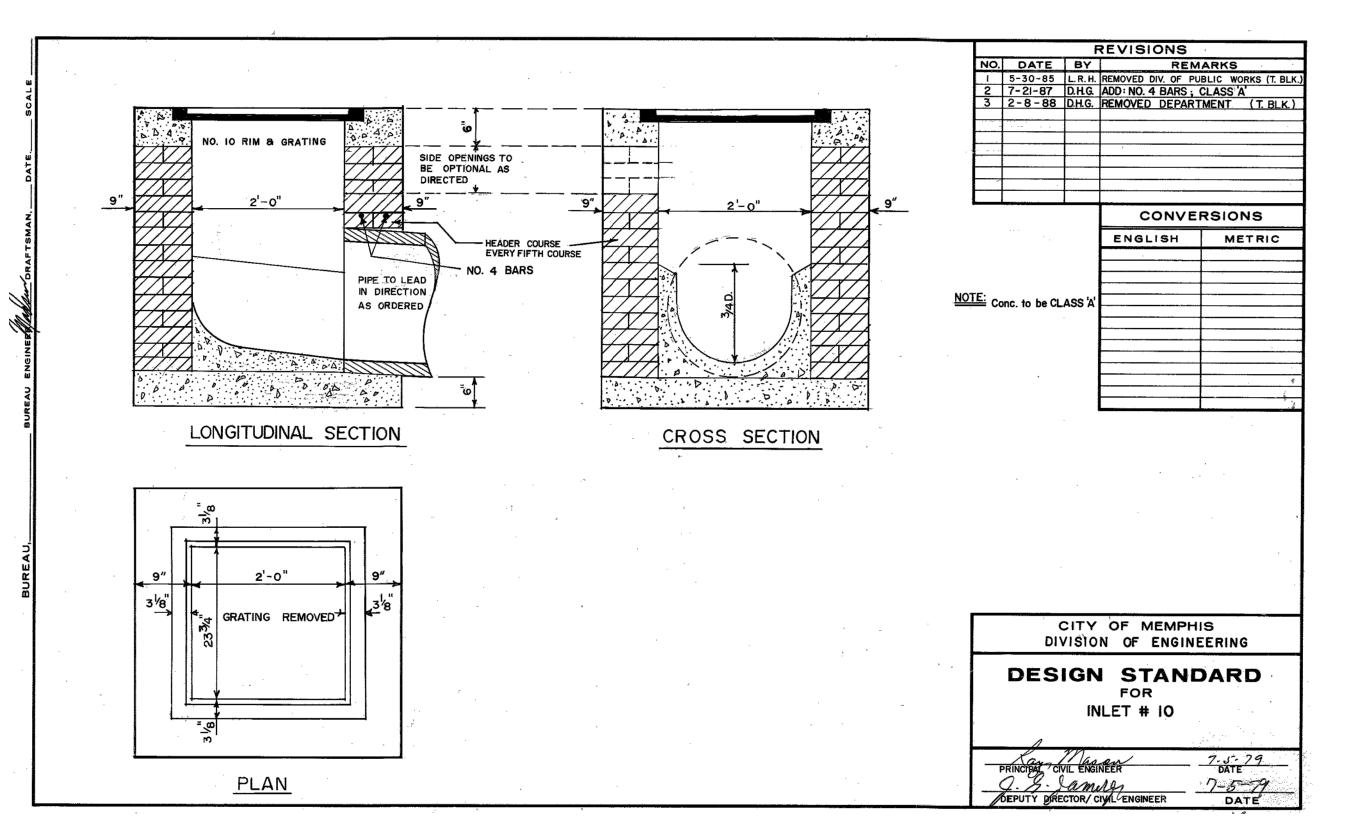

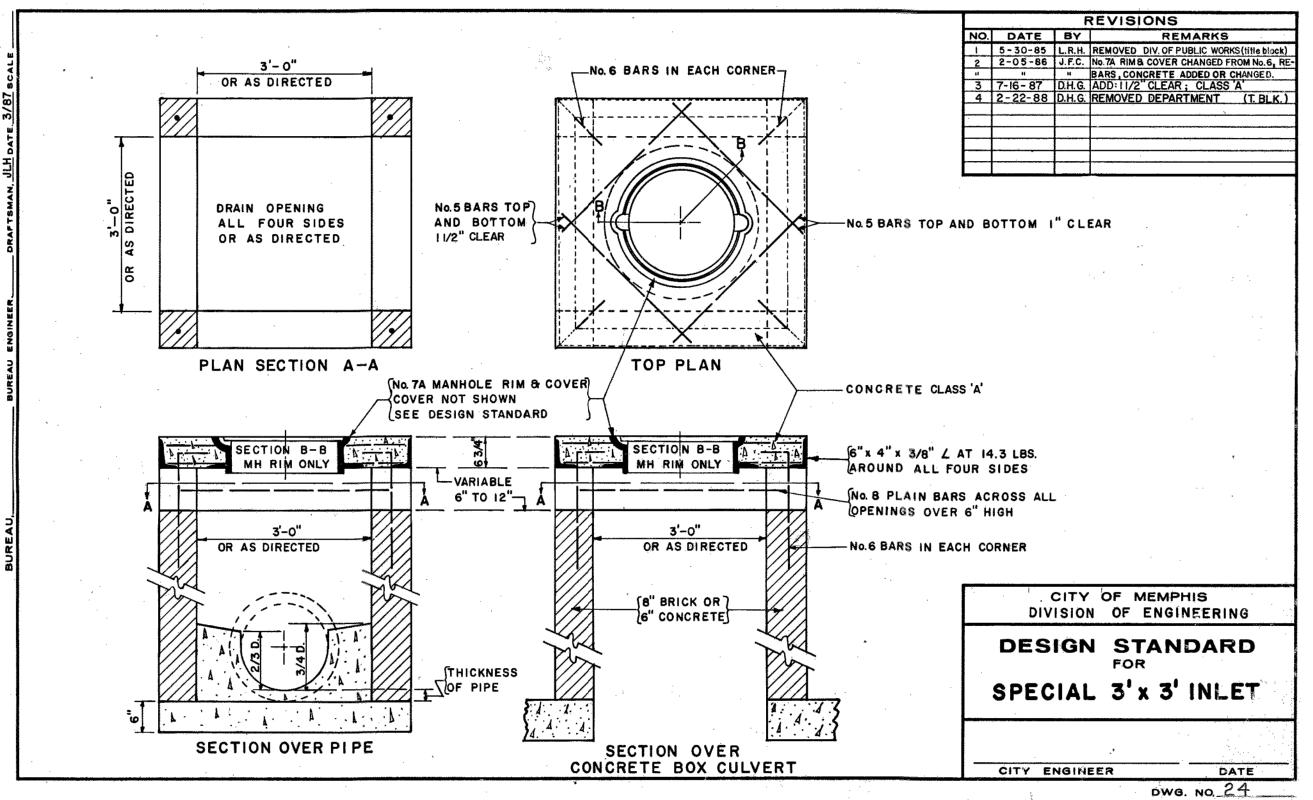



BARGE DESIGN SOLUTIONS, INC **65 GERMANTOWN CT, SUITE 100** MEMPHIS, TN 38018

33276-02

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DESCRIPTION ISSUED FOR BID

MSCAA PROJ. NO. 18-1420-01

> **CHARLES BAKER PAVEMENT RECONSTRUCTION**

> > **DETAILS**

3327602-92C-DT-02.DWG

SHEET TITLE:

C-DT-02 03/11/2024

44 OF 47


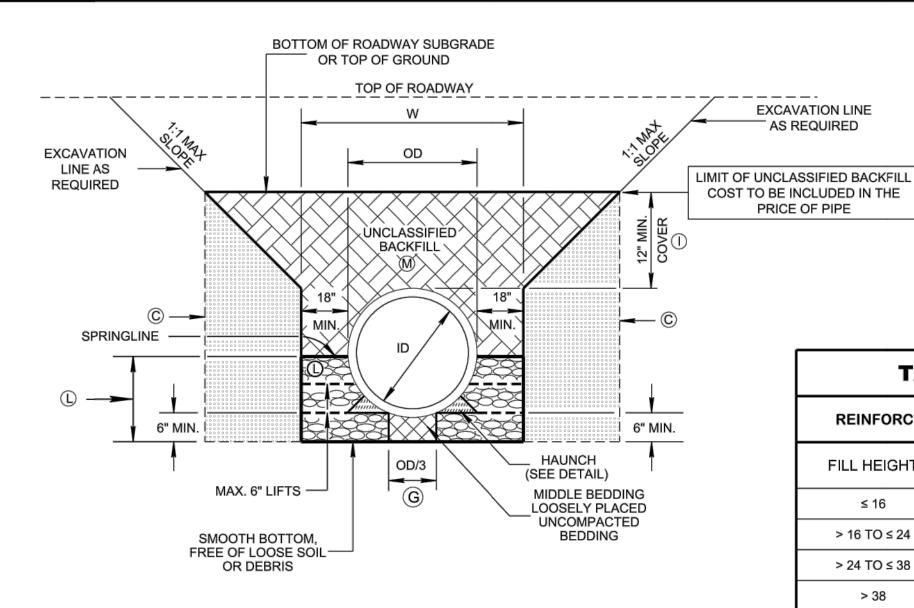



TABLE A REINFORCED CONCRETE PIPE CLASSIFICATION FILL HEIGHT (AASHTO M170) > 16 TO ≤ 24 > 24 TO ≤ 38 SPECIAL DESIGN


STANDARD TRENCH INSTALLATION

(PIPE CULVERT INSTALLATION DETAIL) NOTE: CENTER PIPE IN TRENCH SEE GENERAL NOTE (B)

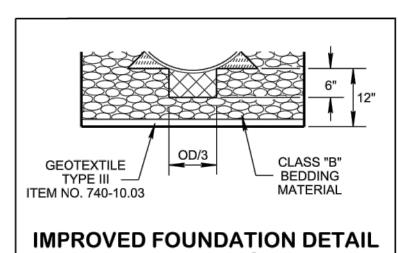

SEE GENERAL NOTE (G)

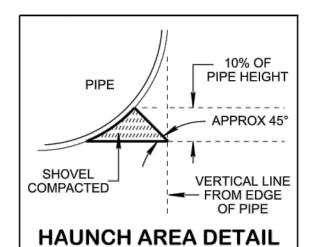

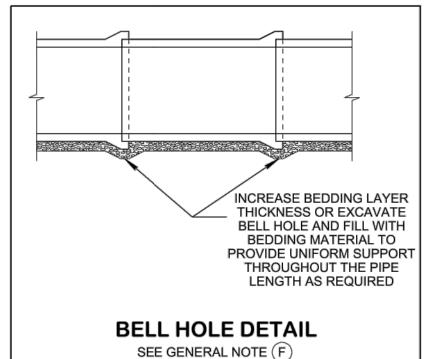

LEGEND


= INSIDE DIAMETER

OUTSIDE DIAMETER


CLASS "B" BEDDING COMPACTED TO 90% STANDARD PROCTOR DENSITY




CLASS "B" BEDDING UNCOMPACTED

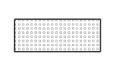

FIRM INSITU SOIL OR CLASS "B" BEDDING COMPACTED TO 90% STANDARD PROCTOR DENSITY

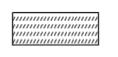

HAUNCH AREA, SHOVEL COMPACTED

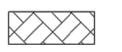

UNCLASSIFIED BACKFILL (FINE COMPACTABLE SOIL)

GENERAL NOTES

REINFORCED CONCRETE PIPE SHALL MEET THE REQUIREMENTS OF AASHTO M-170. THE WALL THICKNESS SHALL BE "WALL B" (EXPECT: FOR STRUCTURES DEEPER THAN THE MINIMUM DEPTH, "WALL C" MAY BE USED) AND THE RCP CLASS SHALL BE AS LISTED IN "TABLE A". ALL PIPE MANUFACTURING PLANTS SHALL BE CERTIFIED BY EITHER ACPA OR NPCA. REFER SOP 5-3 FOR MORE INFORMATION.

INSTALLATIONS REQUIREMENTS:

- FOR EMBANKMENT AREAS OR WHERE TRENCH CONDITIONS DO NOT EXIST, AN INDUCED TRENCH SOIL EMBANKMENT SHALL BE CONSTRUCTED
- FOR TRENCHES WITH IN SITU SOIL WALLS, THE SOIL SHALL BE AT LEAST AS FIRM AS THE MAJORITY OF THE SUBGRADE AS DETERMINED BY THE ENGINEER. SOIL NOT MEETING THIS REQUIREMENT SHALL BE REMOVED AND REPLACED.
- FOR ADDITIONAL INSTALLATION INFO SEE SECTION 27 "CONCRETE CULVERTS" OF THE AASHTO STANDARD SPECIFICATIONS FOR HIGHWAYS AND BRIDGES AND ASTM C-1479-10.
- ONLY AS MUCH TRENCH AS CAN BE SAFELY MAINTAINED SHALL BE OPENED. ALL TRENCHES SHALL BE BACKFILLED AND COMPACTED TO THE MINIMUM COVER DEPTH 12" ABOVE THE PIPE AS SOON AS PRACTICABLE, BUT NOT LATER THAN THE END OF EACH WORKING DAY IN ACCORDANCE WITH THE COMPACTED REQUIREMENTS.
- JOINTS BETWEEN PIPES REQUIRE A RUBBER GASKET MEETING ASTM C443. AT CONNECTIONS TO STRUCTURES USE NON-SHRINK GROUT OR RUBBER GASKET PER C923 OR C1478. WHERE PIPE WITH BELLS ARE INSTALLED, BELL HOLES SHALL BE EXCAVATED IN BEDDING TO SUCH DIMENSIONS THAT THE ENTIRE LENGTH OF THE BARREL OF THE PIPE WILL BE SUPPORTED BY THE BEDDING WHEN PROPERLY INSTALLED AS SHOWN IN BELL HOLE DETAIL.
- WHERE THE TRENCH FOUNDATION IS FOUND UNACCEPTABLE OR LOCATION WHERE THE WATER TABLE IS FOUND HIGH:
 - (1) IMPROVED FOUNDATION OR EXCAVATABLE FLOWABLE FILL (EFF) MAY BE USED AT ENGINEER'S INSTRUCTION AS SHOWN ON THIS SHEET. AS NEEDLED THE COST OF REMOVAL OF UNSATISFACTORY BEDDING MATERIAL AND REPLACEMENT WITH SATISFACTORY MATERIAL, INCLUDING GEOTEXTILE, WILL BE PAID SEPARATELY.
 - (2) FIELD ENGINEER SHALL REVIEW SITE CONDITIONS TO CONFIRM TYPICAL BEDDING AS SHOWN IS ADEQUATE TO PROVIDE STRUCTURAL SUPPORT OR FOUNDATION IMPROVEMENT IS REQUIRED.
- (H) FOR MULTIPLE PIPES MINIMUM SPACING BETWEEN PIPES IS:

36" PIPES AND SMALLER: EQUAL TO THE OUTSIDE DIAMETER OF THE LARGEST PIPE

PIPES LARGER THAN 36": EQUAL TO HALF THE OUTSIDE DIAMETER OF THE LARGEST PIPE.

- FOR MINIMUM COVER DEPTHS FOR CONSTRUCTION LOADS SEE D-PB-3.
- CLASS "B" BEDDING MAY NOT BE REQUIRED UNDER SIDE DRAINS FOR PRIVATE DRIVES, FIELD ENTRANCES, PIPES OUTSIDE THE SHOULDER LIMITS OF INTERCHANGE RAMPS, OR PIPES OUTSIDE NORMAL SLOPE LINES. BEDDING TYPE AS PER STANDARD SPECIFICATION 204.10.B.
- ARCH AND OVAL SHAPED PIPE CULVERTS SHALL BE INSTALLED THE SAME AS CIRCULAR WITH O.D. EQUAL TO THE WIDEST HORIZONTAL DIMENSION ON THE PIPE. TO ESTIMATE BEDDING MATERIAL FOR THESE PIPES WITH INTERNAL WIDTH THE SAME AS DIAMETER IN THE TABLE, MULTIPLY BEDDING QUANTITY BY 0.5 FOR THE SHOWN MINIMUM TRENCH DIMENSIONS.

BEDDING AND BACKFILL REQUIREMENTS:

- CLASS "B" BEDDING MATERIAL MEETING THE REQUIREMENTS OF CONSTRUCTION SPECIFICATION SUBSECTION 204.04 SHALL BE PLACED IN LIFTS, NOT TO EXCEED 6 INCHES, TO THE PIPE SPRINGLINE. A MINIMUM COMPACTION LEVEL OF 90% OF THE STANDARD PROCTOR DENSITY PER AASHTO T99 SHALL BE ACHIEVED BY USE OF VIBRATORY PLATE.
- UNCLASSIFIED BACKFILL SHALL BE PLACED AND COMPACTED IN LAYERS NOT EXCEEDING A 8 INCH LOOSE LIFT THICKNESS AND BROUGHT UP EVENLY AND SIMULTANEOUSLY ON BOTH SIDES OF THE PIPE TO AN ELEVATION NOT LESS THAN ONE FOOT ABOVE THE TOP OF THE PIPE.

UNCLASSIFIED BACKFILL TO THE LIMIT OF PIPE BACKFILL LINE SHALL BE COMPACTED IN ACCORDANCE TO STANDARD SPECIFICATION 204.11. HYDRO-HAMMER TYPE OF COMPACTORS MAY BE USED AROUND THE PIPE HOWEVER THEY SHALL NOT BE USED DIRECTLY OVER THE PIPE TO PREVENT ANY DAMAGE. ALL COMPACTION EQUIPMENT USED SHALL BE APPROVED BY THE ENGINEER.

PLACE 6 INCHES MINIMUM OF CLASS "B" BEDDING MATERIAL, ALONG WITH SUFFICIENT ADDITIONAL CLASS "B" BEDDING MATERIAL ACCURATELY SHAPED AS SHOWN IN HAUNCH AREA DETAIL.

END TREATMENTS:

- (1) ALL CROSS DRAINS (PERPENDICULAR) PLACED UNDER A MAINLINE ROADWAY REQUIRE TYPE U ENDWALLS CONFORMING TO THE ROADWAY FILL SLOPE AS SHOWN ON STANDARD DRAWINGS D-PE-15A THROUGH D-PE-48A FOR END WALL GEOMETRY AND D-PE-99 FOR GRATE DETAILS. ALL CULVERT ENDWALLS LOCATED WITHIN THE CLEAR ZONE (S-CZ-1) REQUIRE A SAFETY GRATE (18" OR 24" PIPE ENDWALLS MAY OMIT THE STEEL GRATE). ALL CROSS DRAIN CULVERTS LARGER THAN 48" MUST BE PROTECTED BY A GUARDRAIL OR ENDWALL OR MUST BE PLACED OUTSIDE THE CLEAR ZONE. CROSS DRAIN ENDWALLS PLACED OUTSIDE THE CLEAR ZONE MAY USE TYPE A (D-PE-1), TYPE B (D-PE-9 THRU 9F), OR STRAIGHT HEADWALL (D-PE-4) IN LIEU OF TYPE U OR IF THE PIPE END WALL IS PROTECTED BY A GUARDRAIL.
- (2) ALL SIDE DRAINS (PARALLEL) PLACED UNDER A SIDE ROAD, DRIVEWAY, OR FIELD ENTRANCE, ETC. THAT INTERSECT A MAINLINE ROADWAY, REQUIRE SAFETY ENDWALLS AS SHOWN ON THE D-SEW- SERIES STANDARD DRAWINGS WITH SAFETY GRATE (D-SEW-1A) WITH A MAXIMUM 6:1 TAPER IF THE CULVERT ENDWALLS ARE LOCATED INSIDE THE CLEAR ZONE (S-CZ-1).
- (3) ALL MEDIAN CROSSOVER SIDE DRAINS (LONGITUDINAL) PLACED UNDER MEDIAN OPENINGS REQUIRE SAFETY ENDWALLS AS SHOWN ON D-SEW-12D STANDARD DRAWING WITH SAFETY GRATE (D-SEW-1A) WITH MAXIMUM 12:1 TAPER IF THE CULVERT ENDWALLS ARE LOCATED INSIDE THE CLEAR ZONE (S-CZ-1).

INSPECTION REQUIREMENTS:

ALL PIPES SHALL UNDERGO INSPECTION ACCORDING TO SECTION 607.09 OF THE STANDARD SPECIFICATIONS FOR ROAD AND BRIDGE CONSTRUCTION OR PER SECTION 27 OF AASHTO STANDARD SPECIFICATIONS FOR HIGHWAYS AND BRIDGES OR PER ASTM C1840.

PAYMENT:

EXCAVATION FOR PIPE WILL NOT BE MEASURED AND PAID FOR DIRECTLY AND ANY SOIL NOT MEETING REQUIREMENT FOR TRENCHES SHALL BE REMOVED AND REPLACED. ALL COST OF THIS WORK WILL BE INCLUDED IN THE COST OF THE PROPOSED PIPE CULVERT. SEE TABLE B FOR PIPE CULVERT ITEM NUMBERS.

PAYMENT FOR CLASS "B" BEDDING MATERIAL, UNCLASSIFIED BACKFILL TO THE LIMIT LINE, AND/OR IF REQUIRED EXCAVATABLE FLOWABLE FILL AND BEDDING MATERIAL WILL BE INCLUDED IN THE UNIT PRICE OF THE PIPE.

PER S.Y.

GEOTEXTILE TYPE III TO BE USED ONLY IF IMPROVED FOUNDATION IS REQUIRED, AND WILL BE PAID UNDER ITEM NO.

GEOTEXTILE (TYPE III)(EROSION CONTROL)

■ REV. 7-12-07: REVISED GENERAL NOTE

REV. 6-1-09: REVISED GENERAL NOTE (AND TITLE NAME. ADDED GENERAL

REV.2-1-12: REVISED DRAWING NAME ADDED EFF DETAIL. REVISED GENERAL NOTES AND TABLE. ADDED MINIMUM COVER TABLE.

REV. 8-21-12: REVISED GENERAL NOTES. CHANGED BACKFILL MATERIAL.

REV. 1-2-13: REVISED TRENCH DETAILS REVISED BEDDING TABLE.

REV. 3-16-17: CLARIFIED PAYMENT ITEM NO. IN TABLE B.

REV. 06-28-19: REVISED DETAIL FOR STANDARD TRENCH INSTALLATION, TABLE A AND GENERAL NOTES. REDREW SHEET.

REV. 11-30-20: REVISED DETAIL FOR STANDARD TRENCH INSTALLATION, TABLE B AND GENERAL NOTES. ADDED BELL HOLE DETAIL.

REV. 03-04-21: REVISED TABLE B.

REV. 03-01-23: REVISED GENERAL NOTE

APPROVED BY FHWA (ALL OTHERS APPROVED BY TDOT)

STATE OF TENNESSEE STANDARD DRAWING **DEPARTMENT OF TRANSPORTATION**

> STANDARD DETAILS FOR CONCRETE INSTALLATION

> > D-PB-1

PROGRAM MANAGER

BARGE BARGE DESIGN SOLUTIONS, INC

65 GERMANTOWN CT, SUITE 100 MEMPHIS, TN 38018

33276-02

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18-1420-01


CHARLES BAKER **PAVEMENT** RECONSTRUCTION


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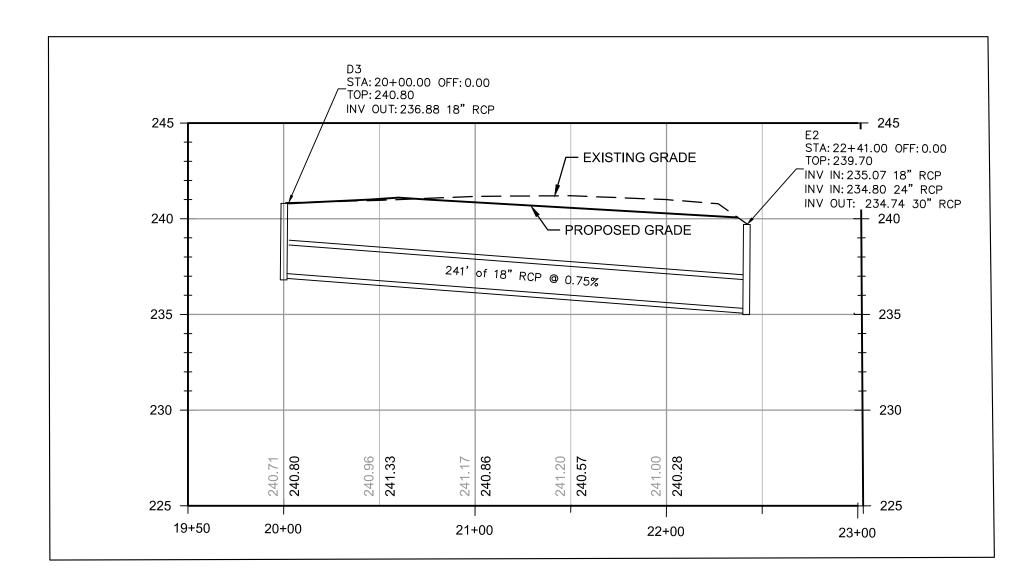
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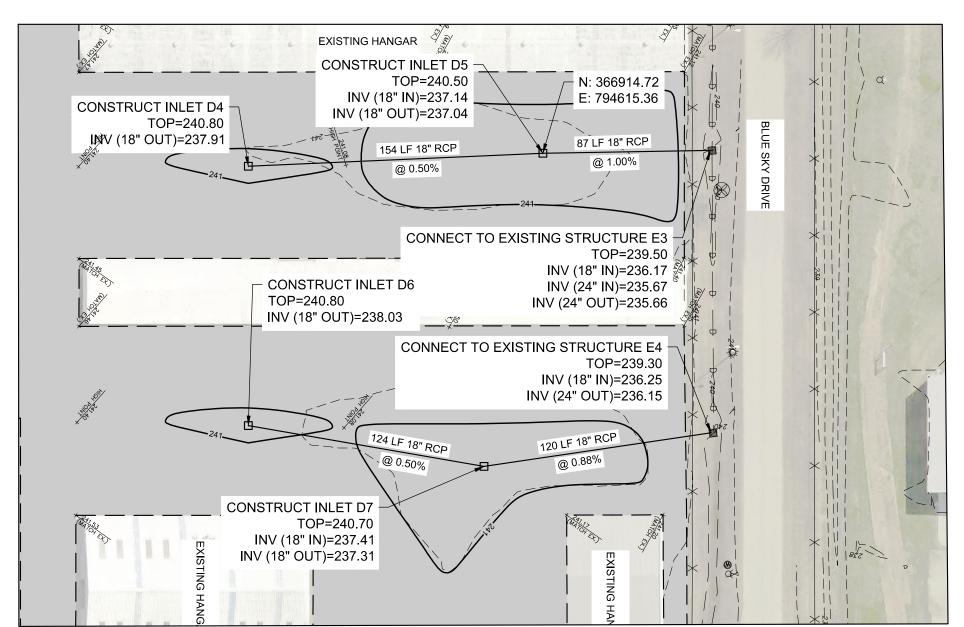
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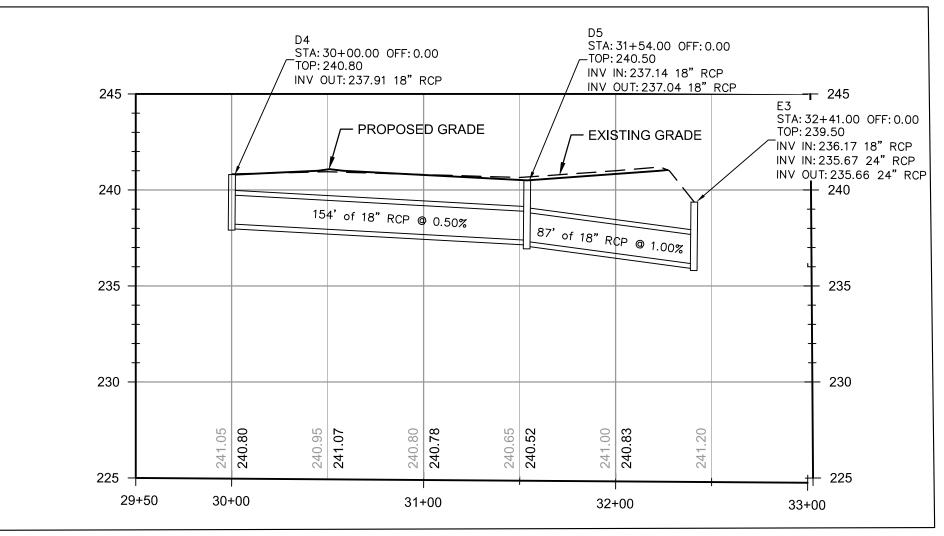
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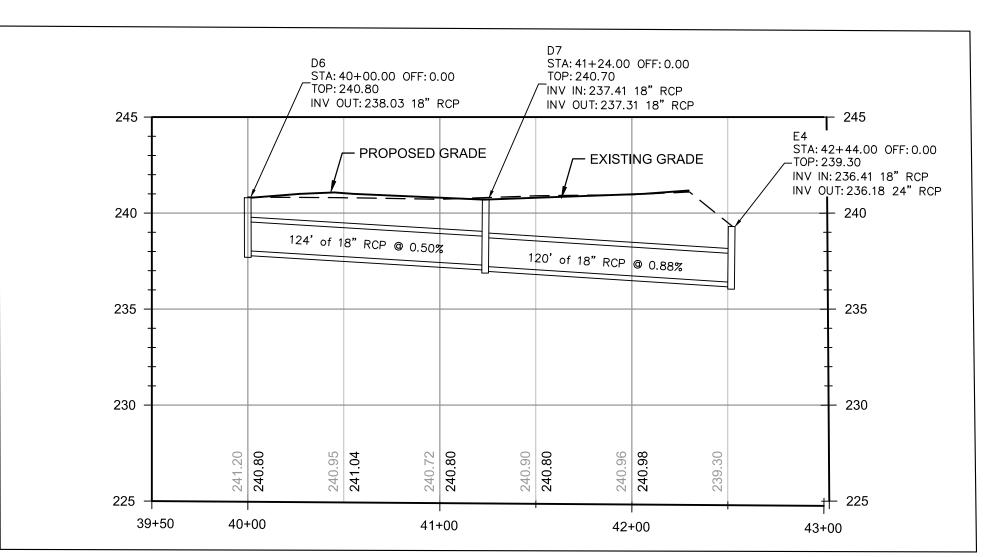









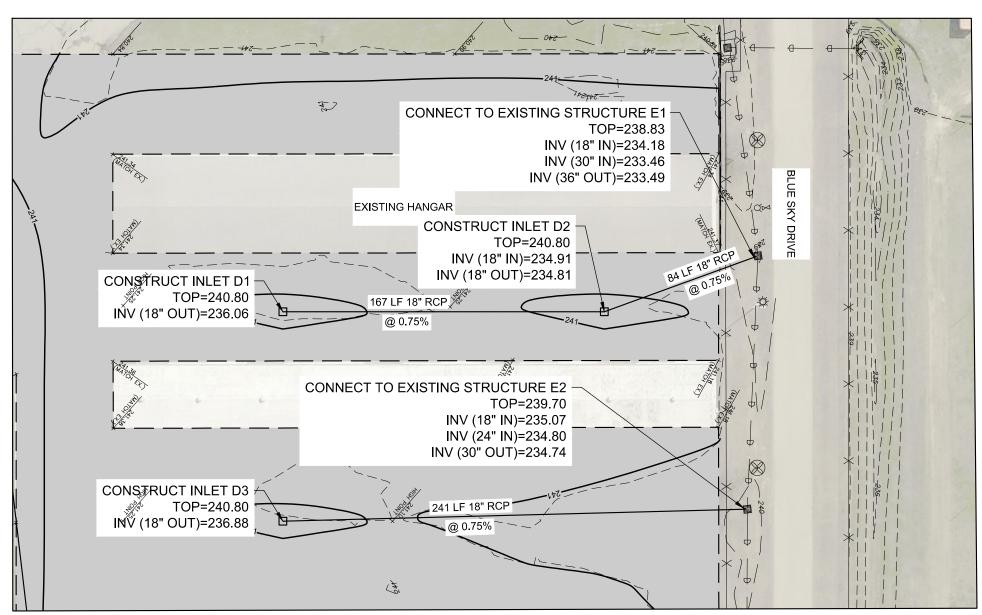

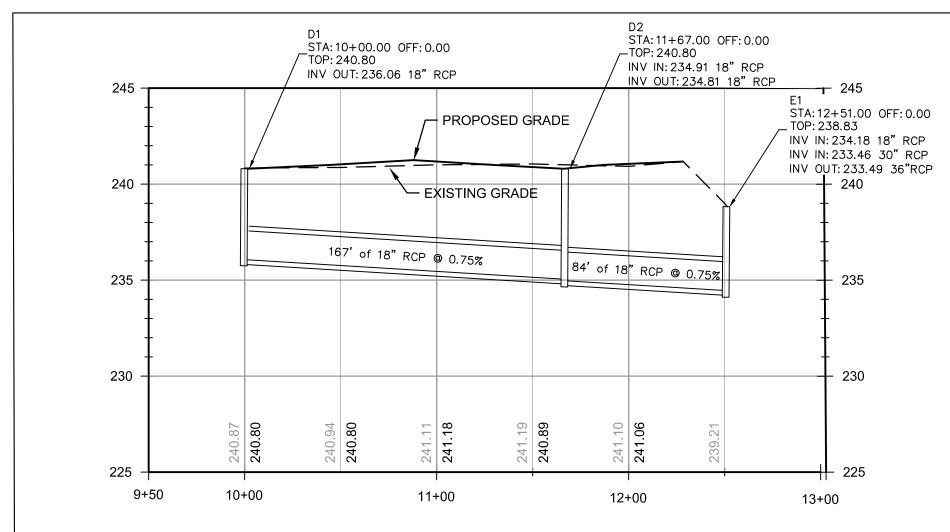

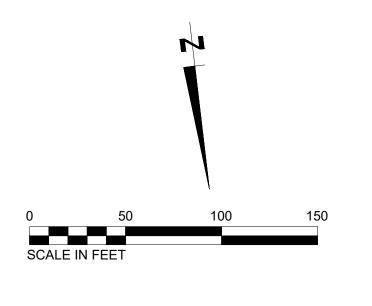



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JEM

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CHARLES BAKER
PAVEMENT
RECONSTRUCTION

SHEET TITLE:

PLAN & PROFILE

DWG. FILE NAME

3327602-94C-PP-01.DWG


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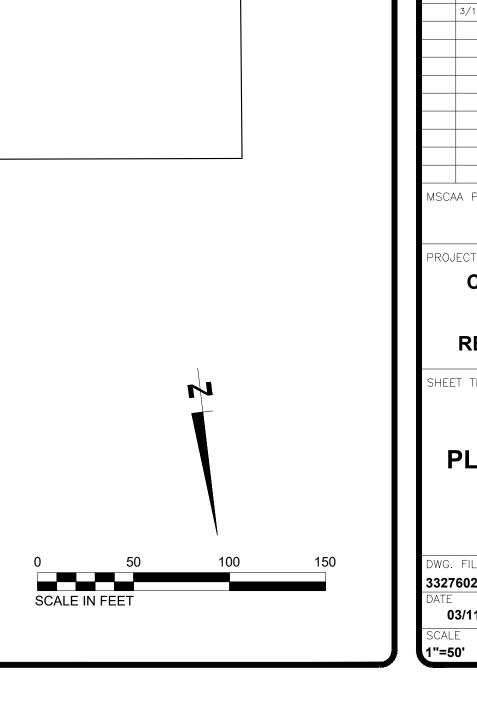
SCALE SHEET

1"=50'

SHEET NO. C-PP-01

46 OF 47



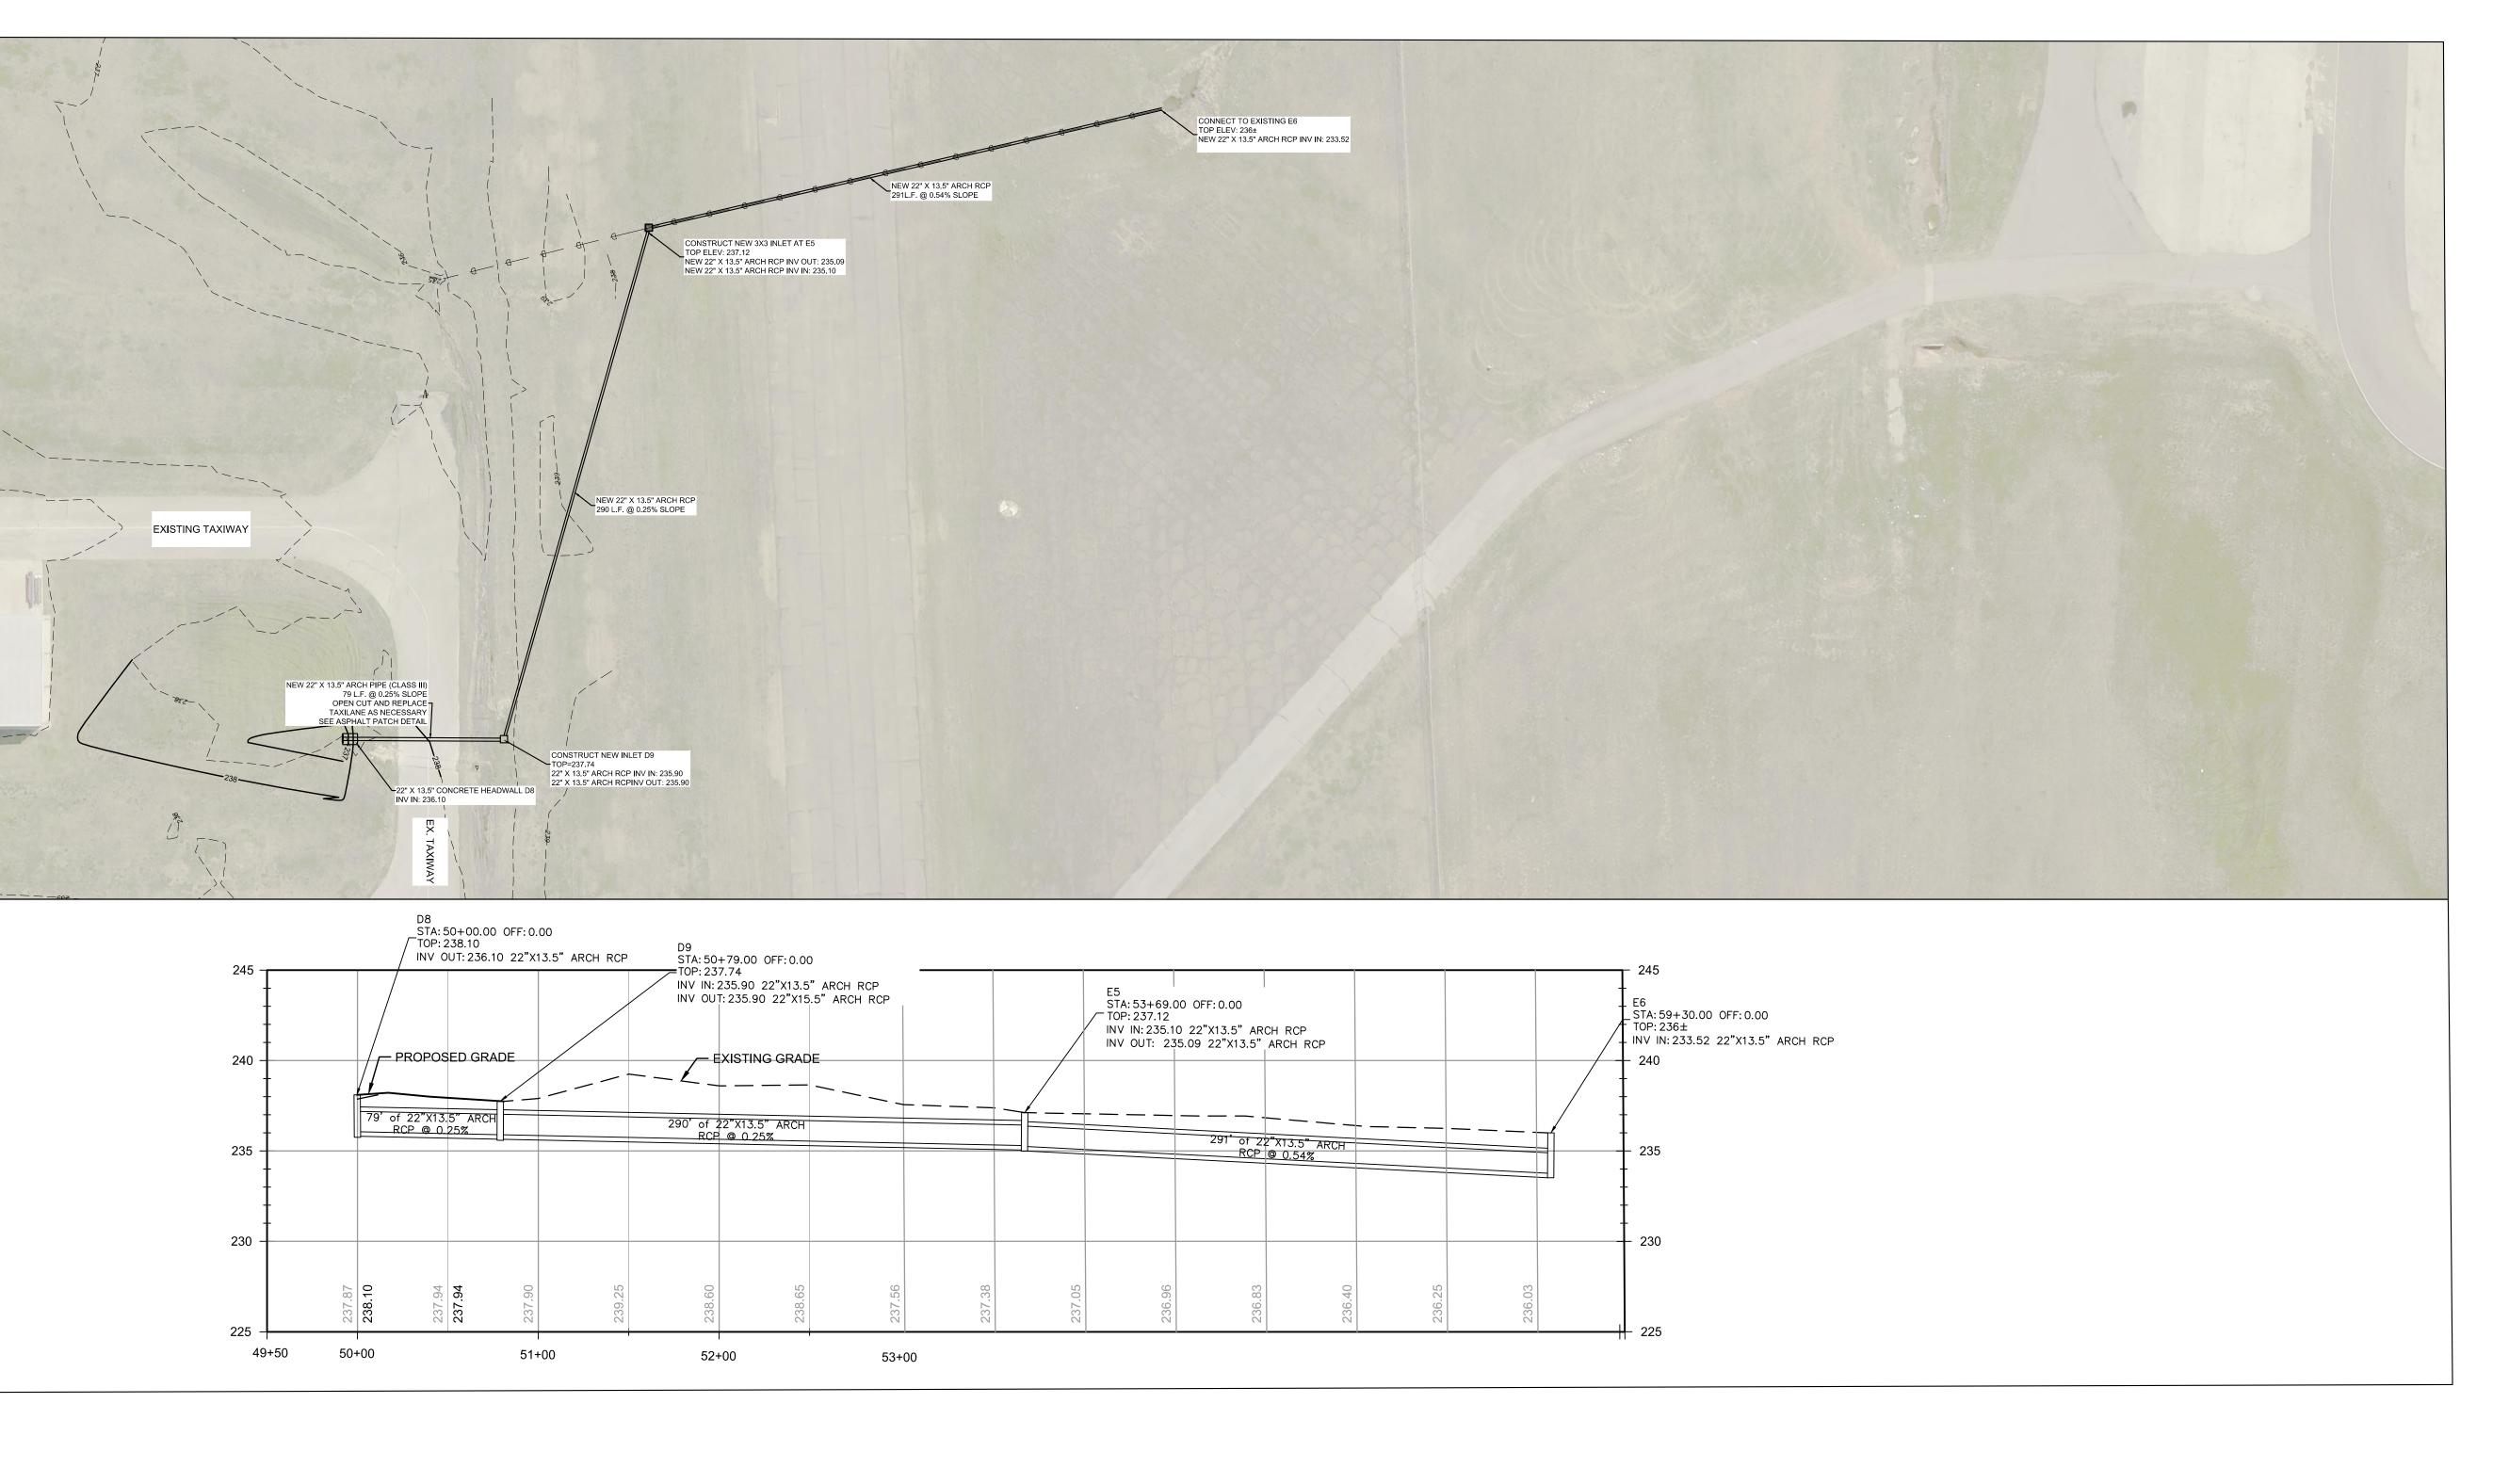



PROGRAM MANAGER

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MSCAA PROJ. NO. 18-1420-01

CHARLES BAKER PAVEMENT RECONSTRUCTION

SHEET TITLE:

PLAN & PROFILE

DWG. FILE NAME 3327602-95C-PP-02.DWG

C-PP-02 03/11/2024 47 OF 47